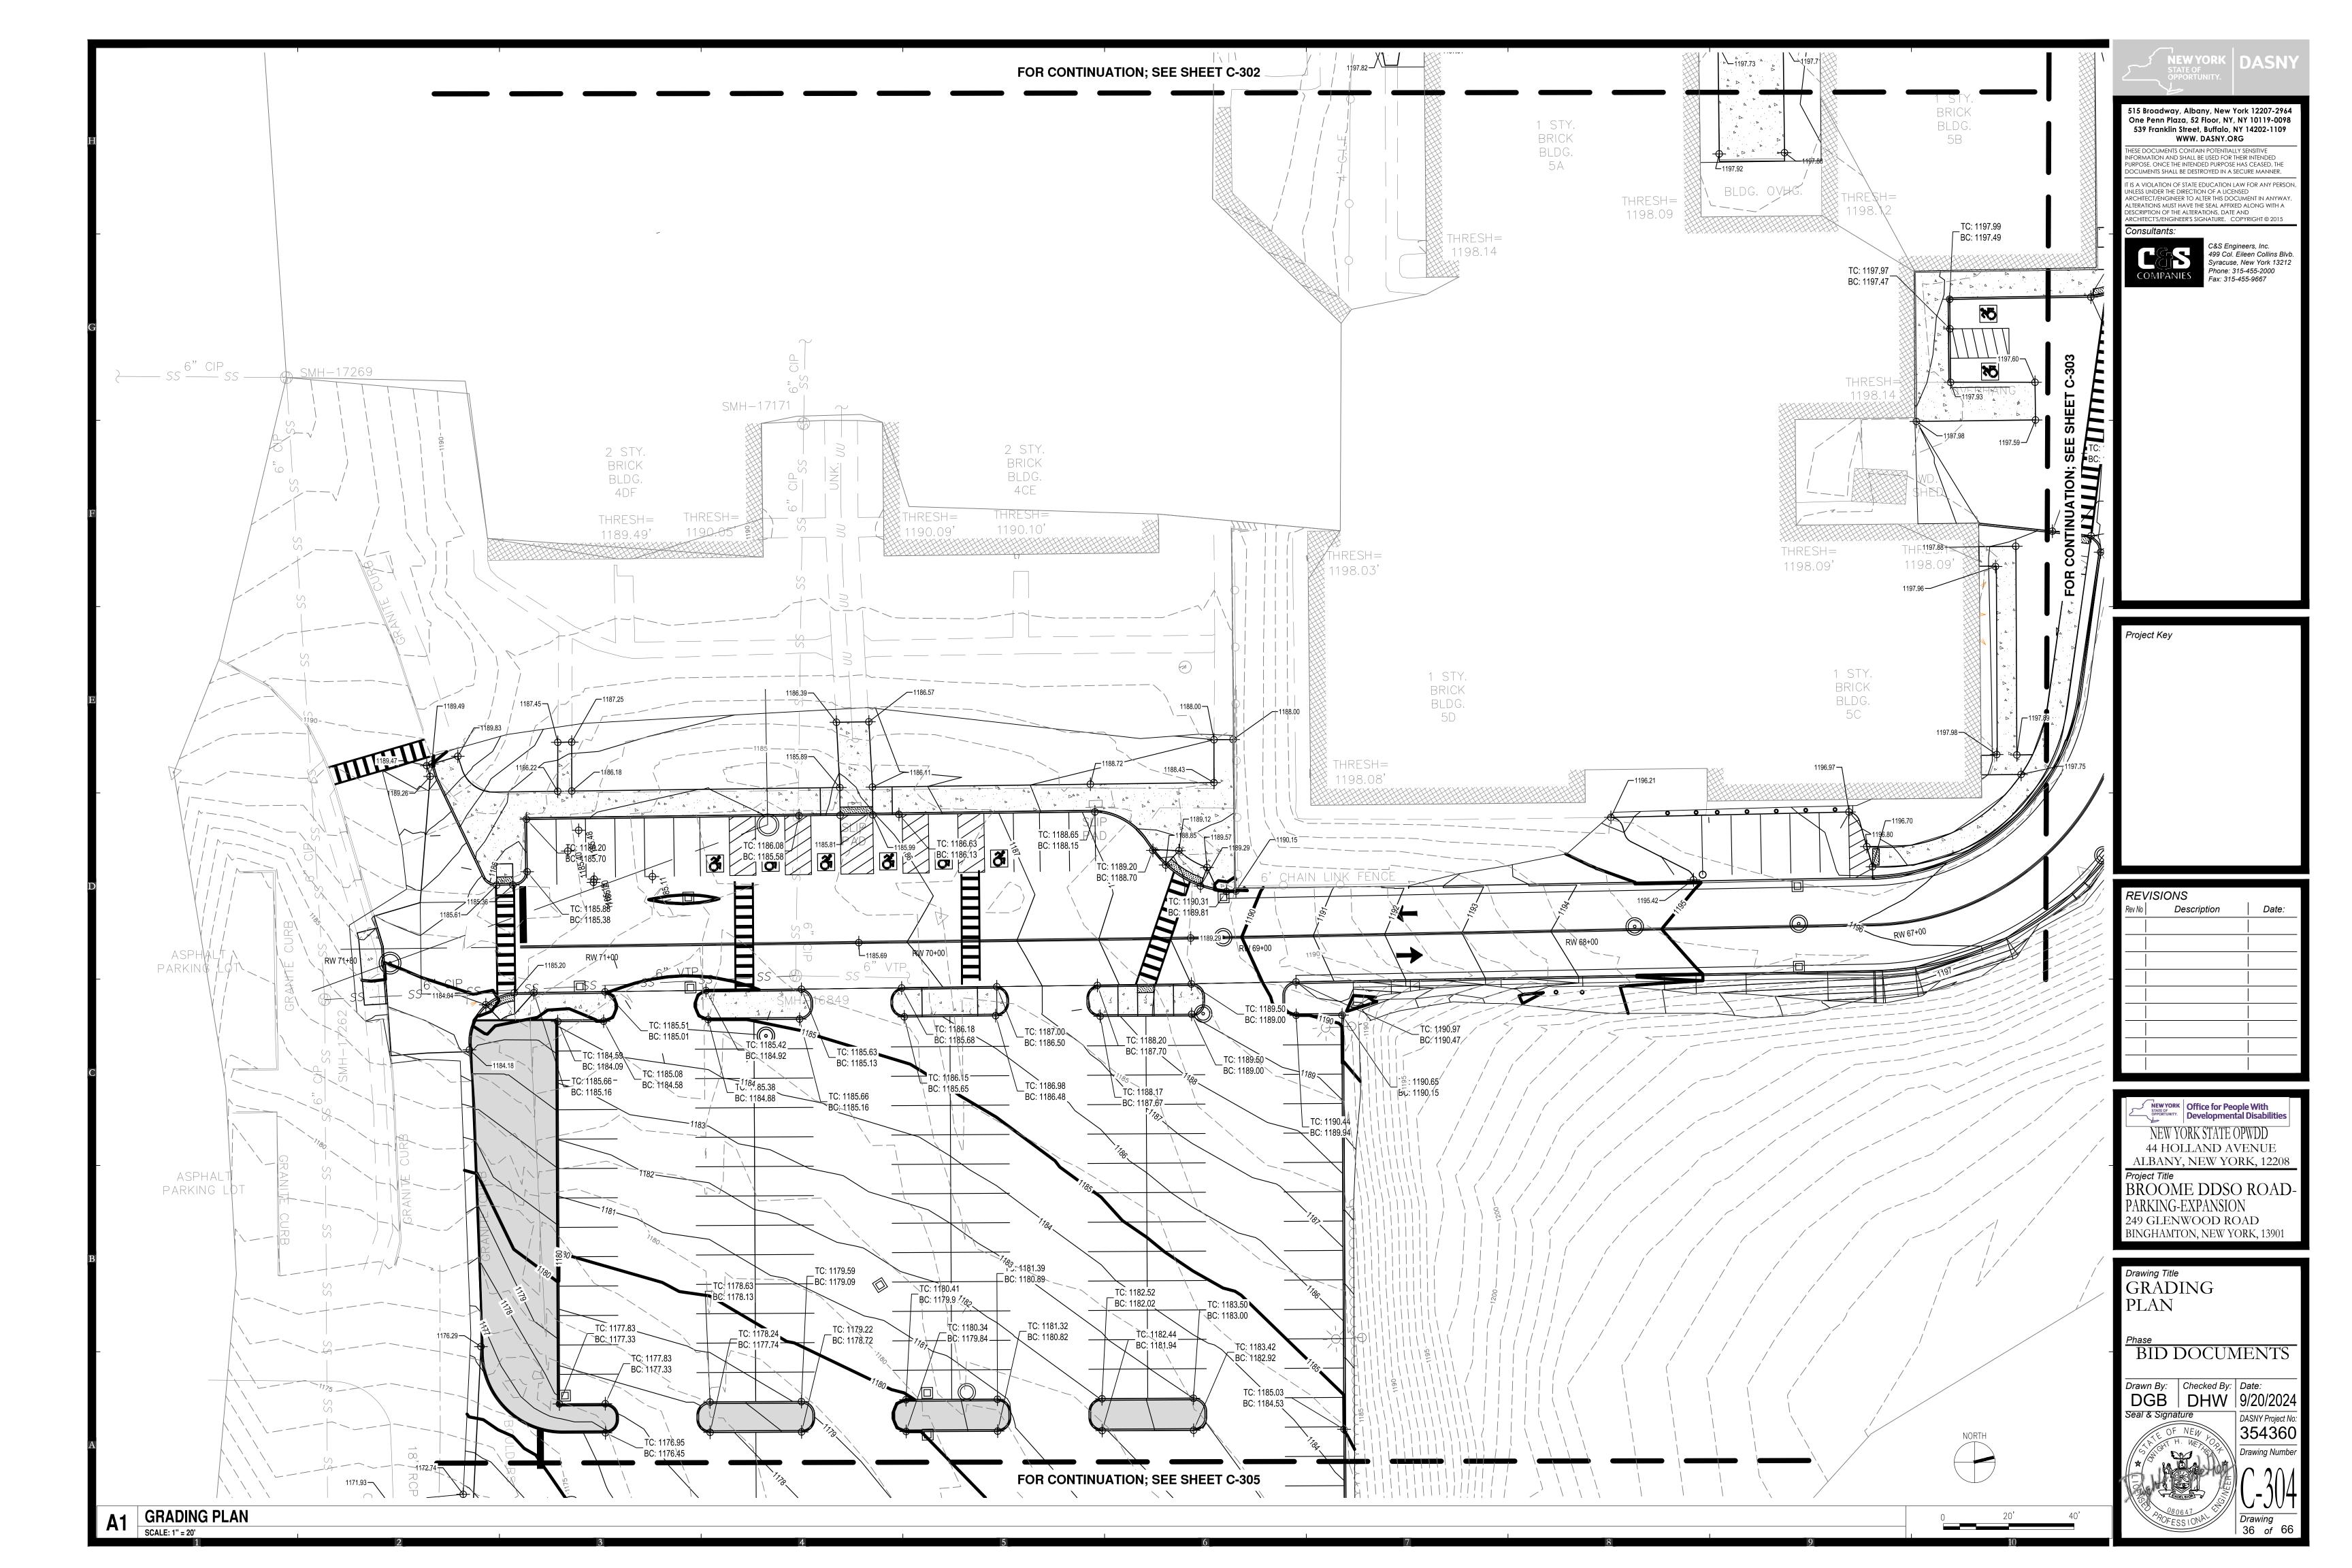
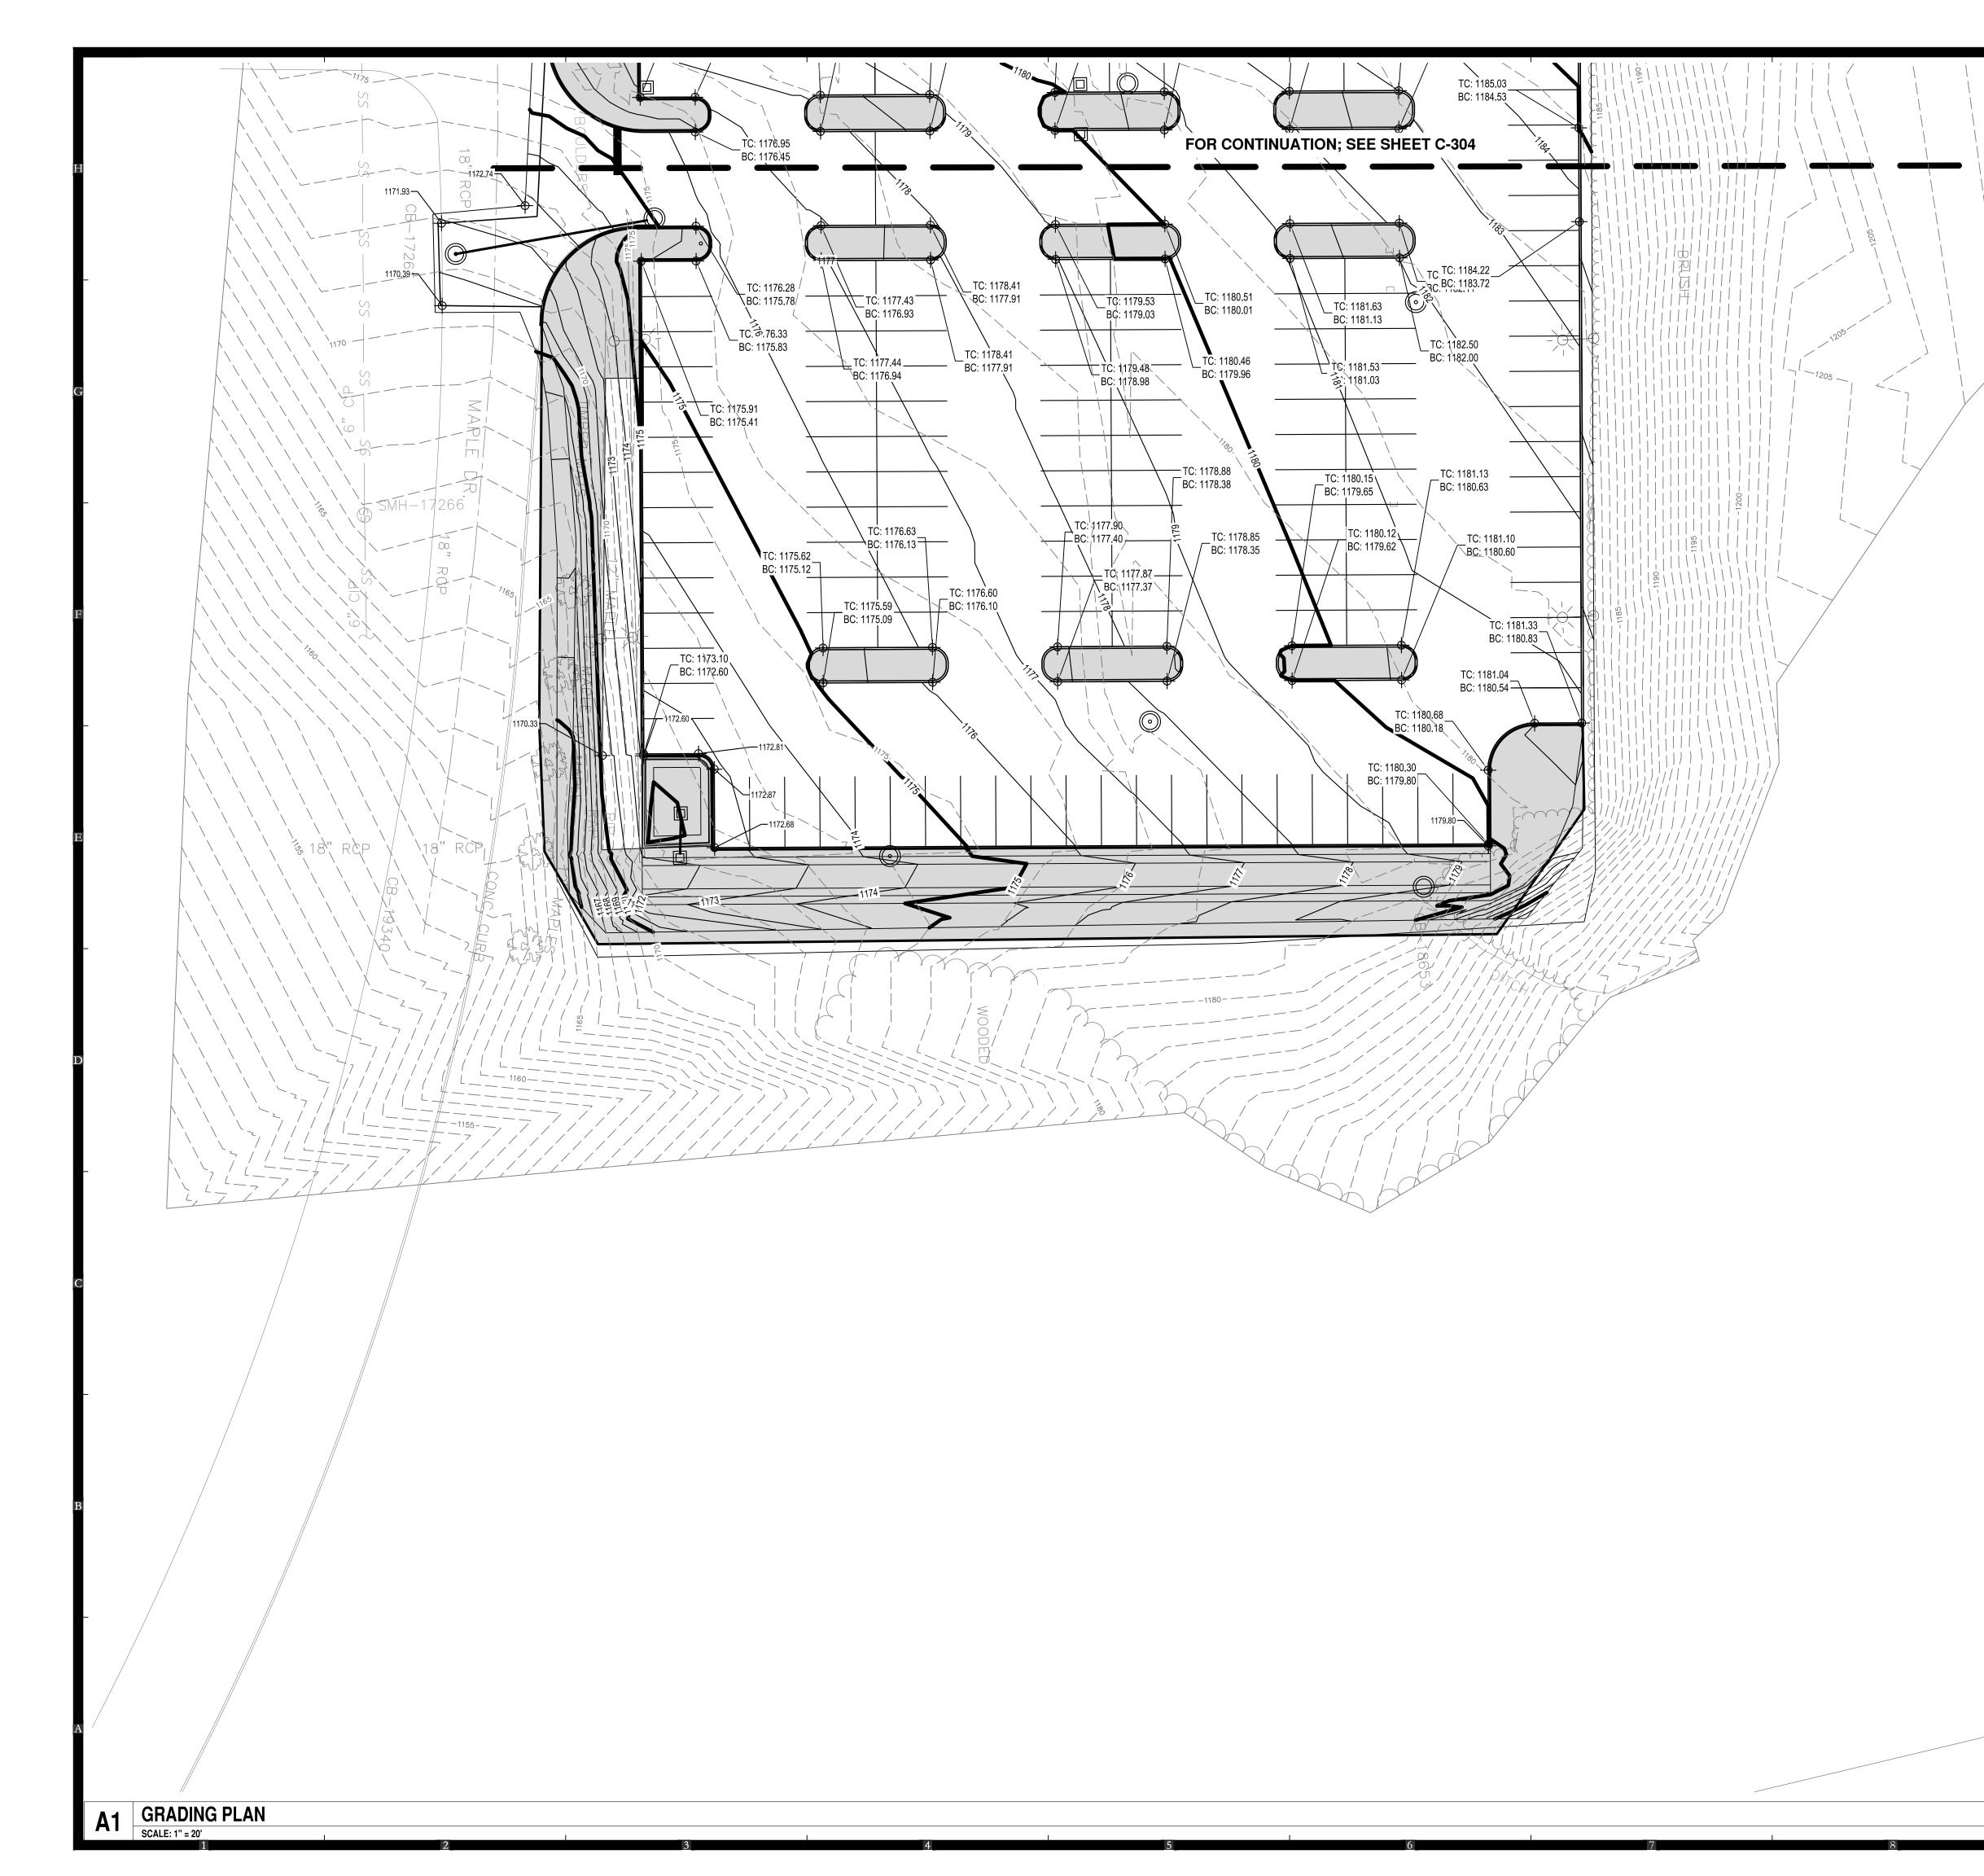
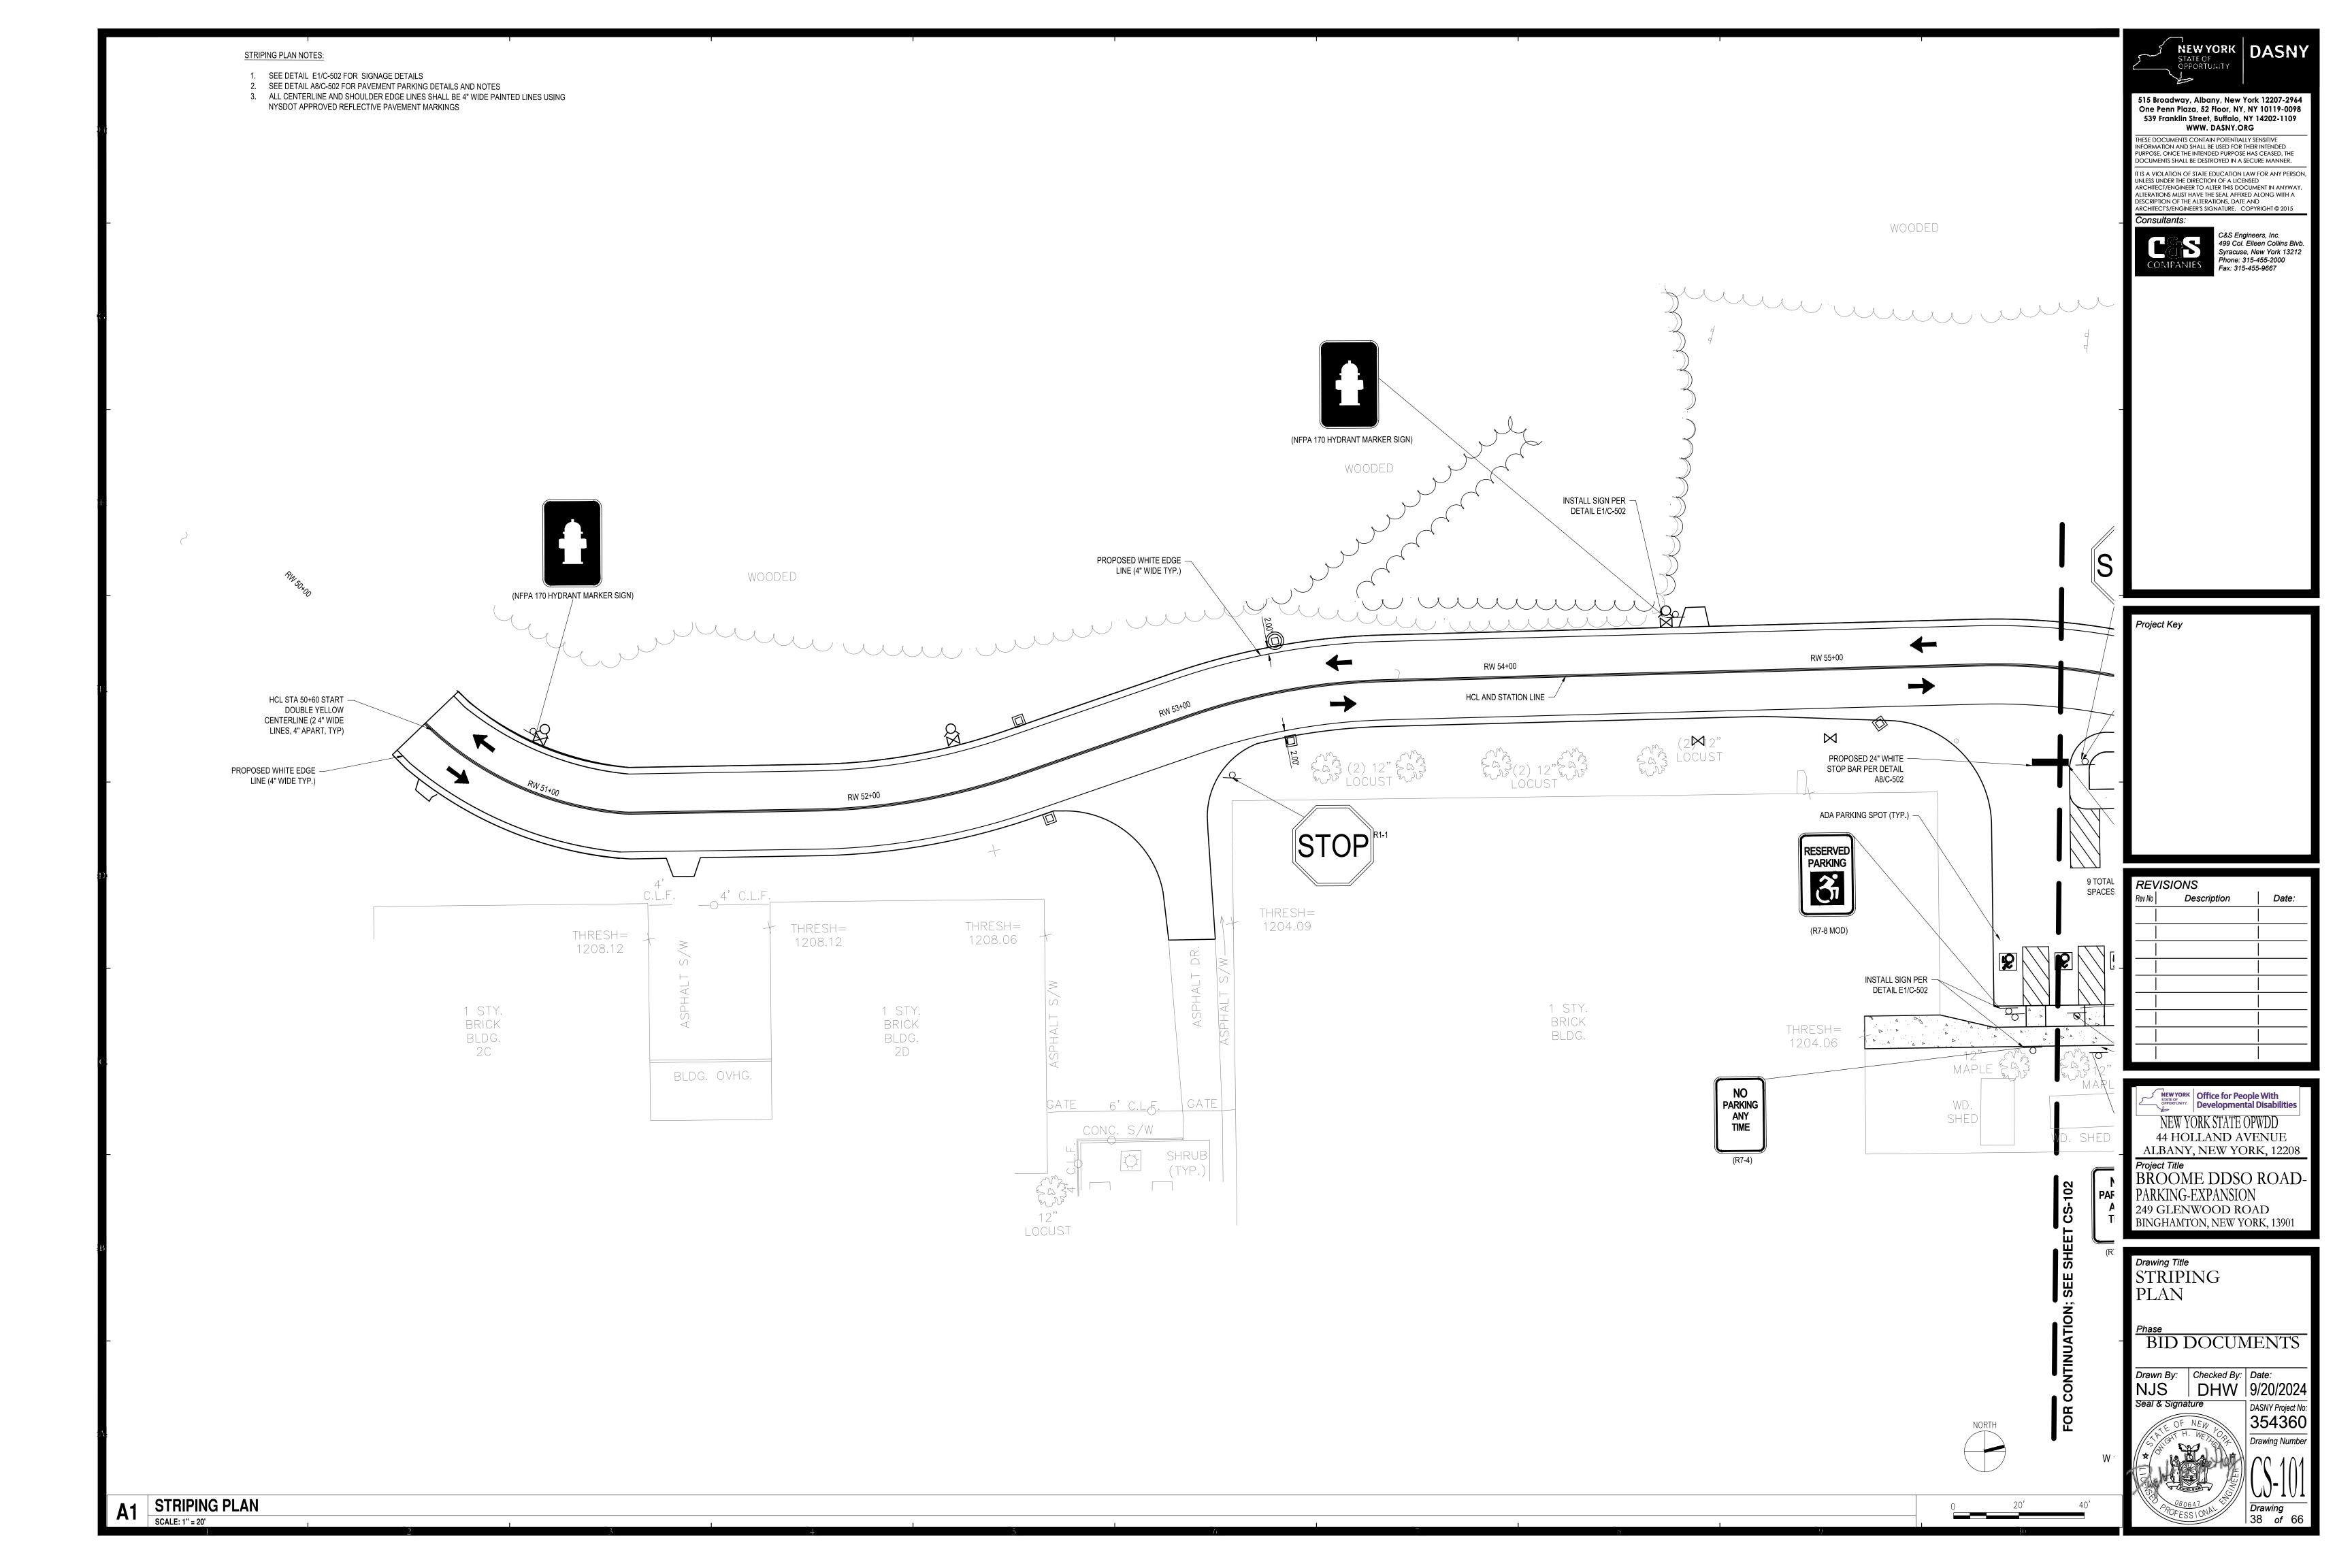


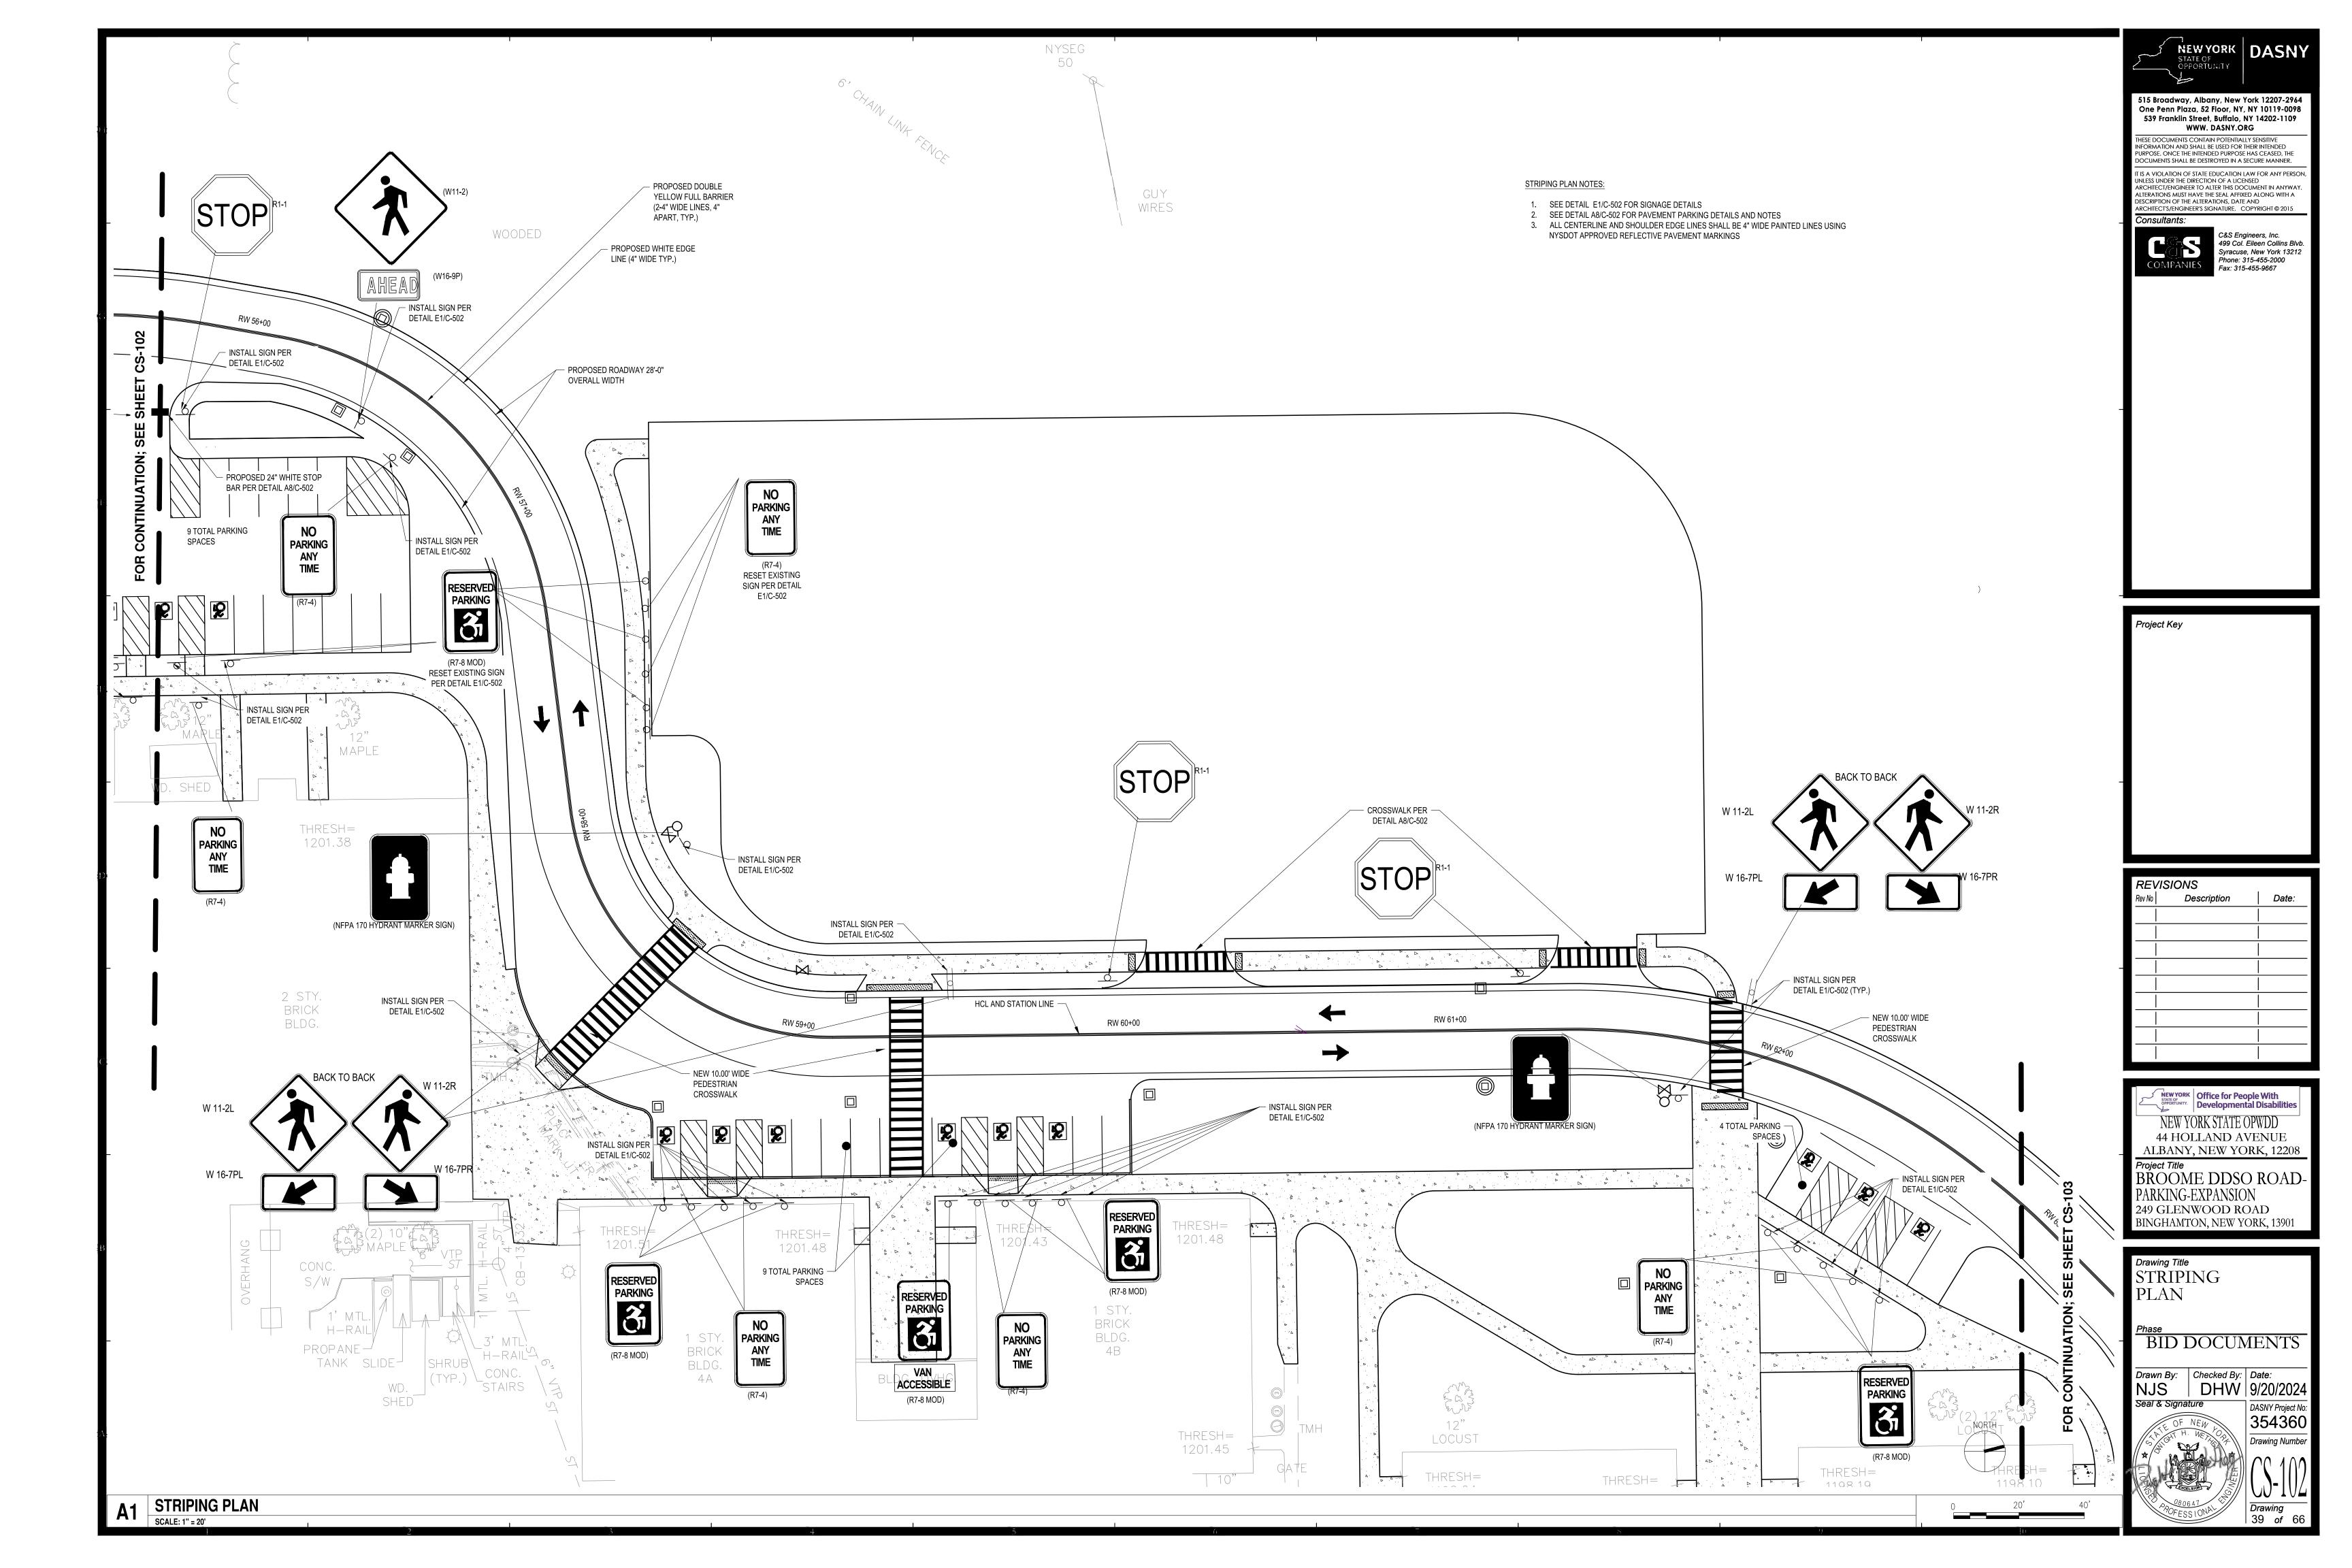
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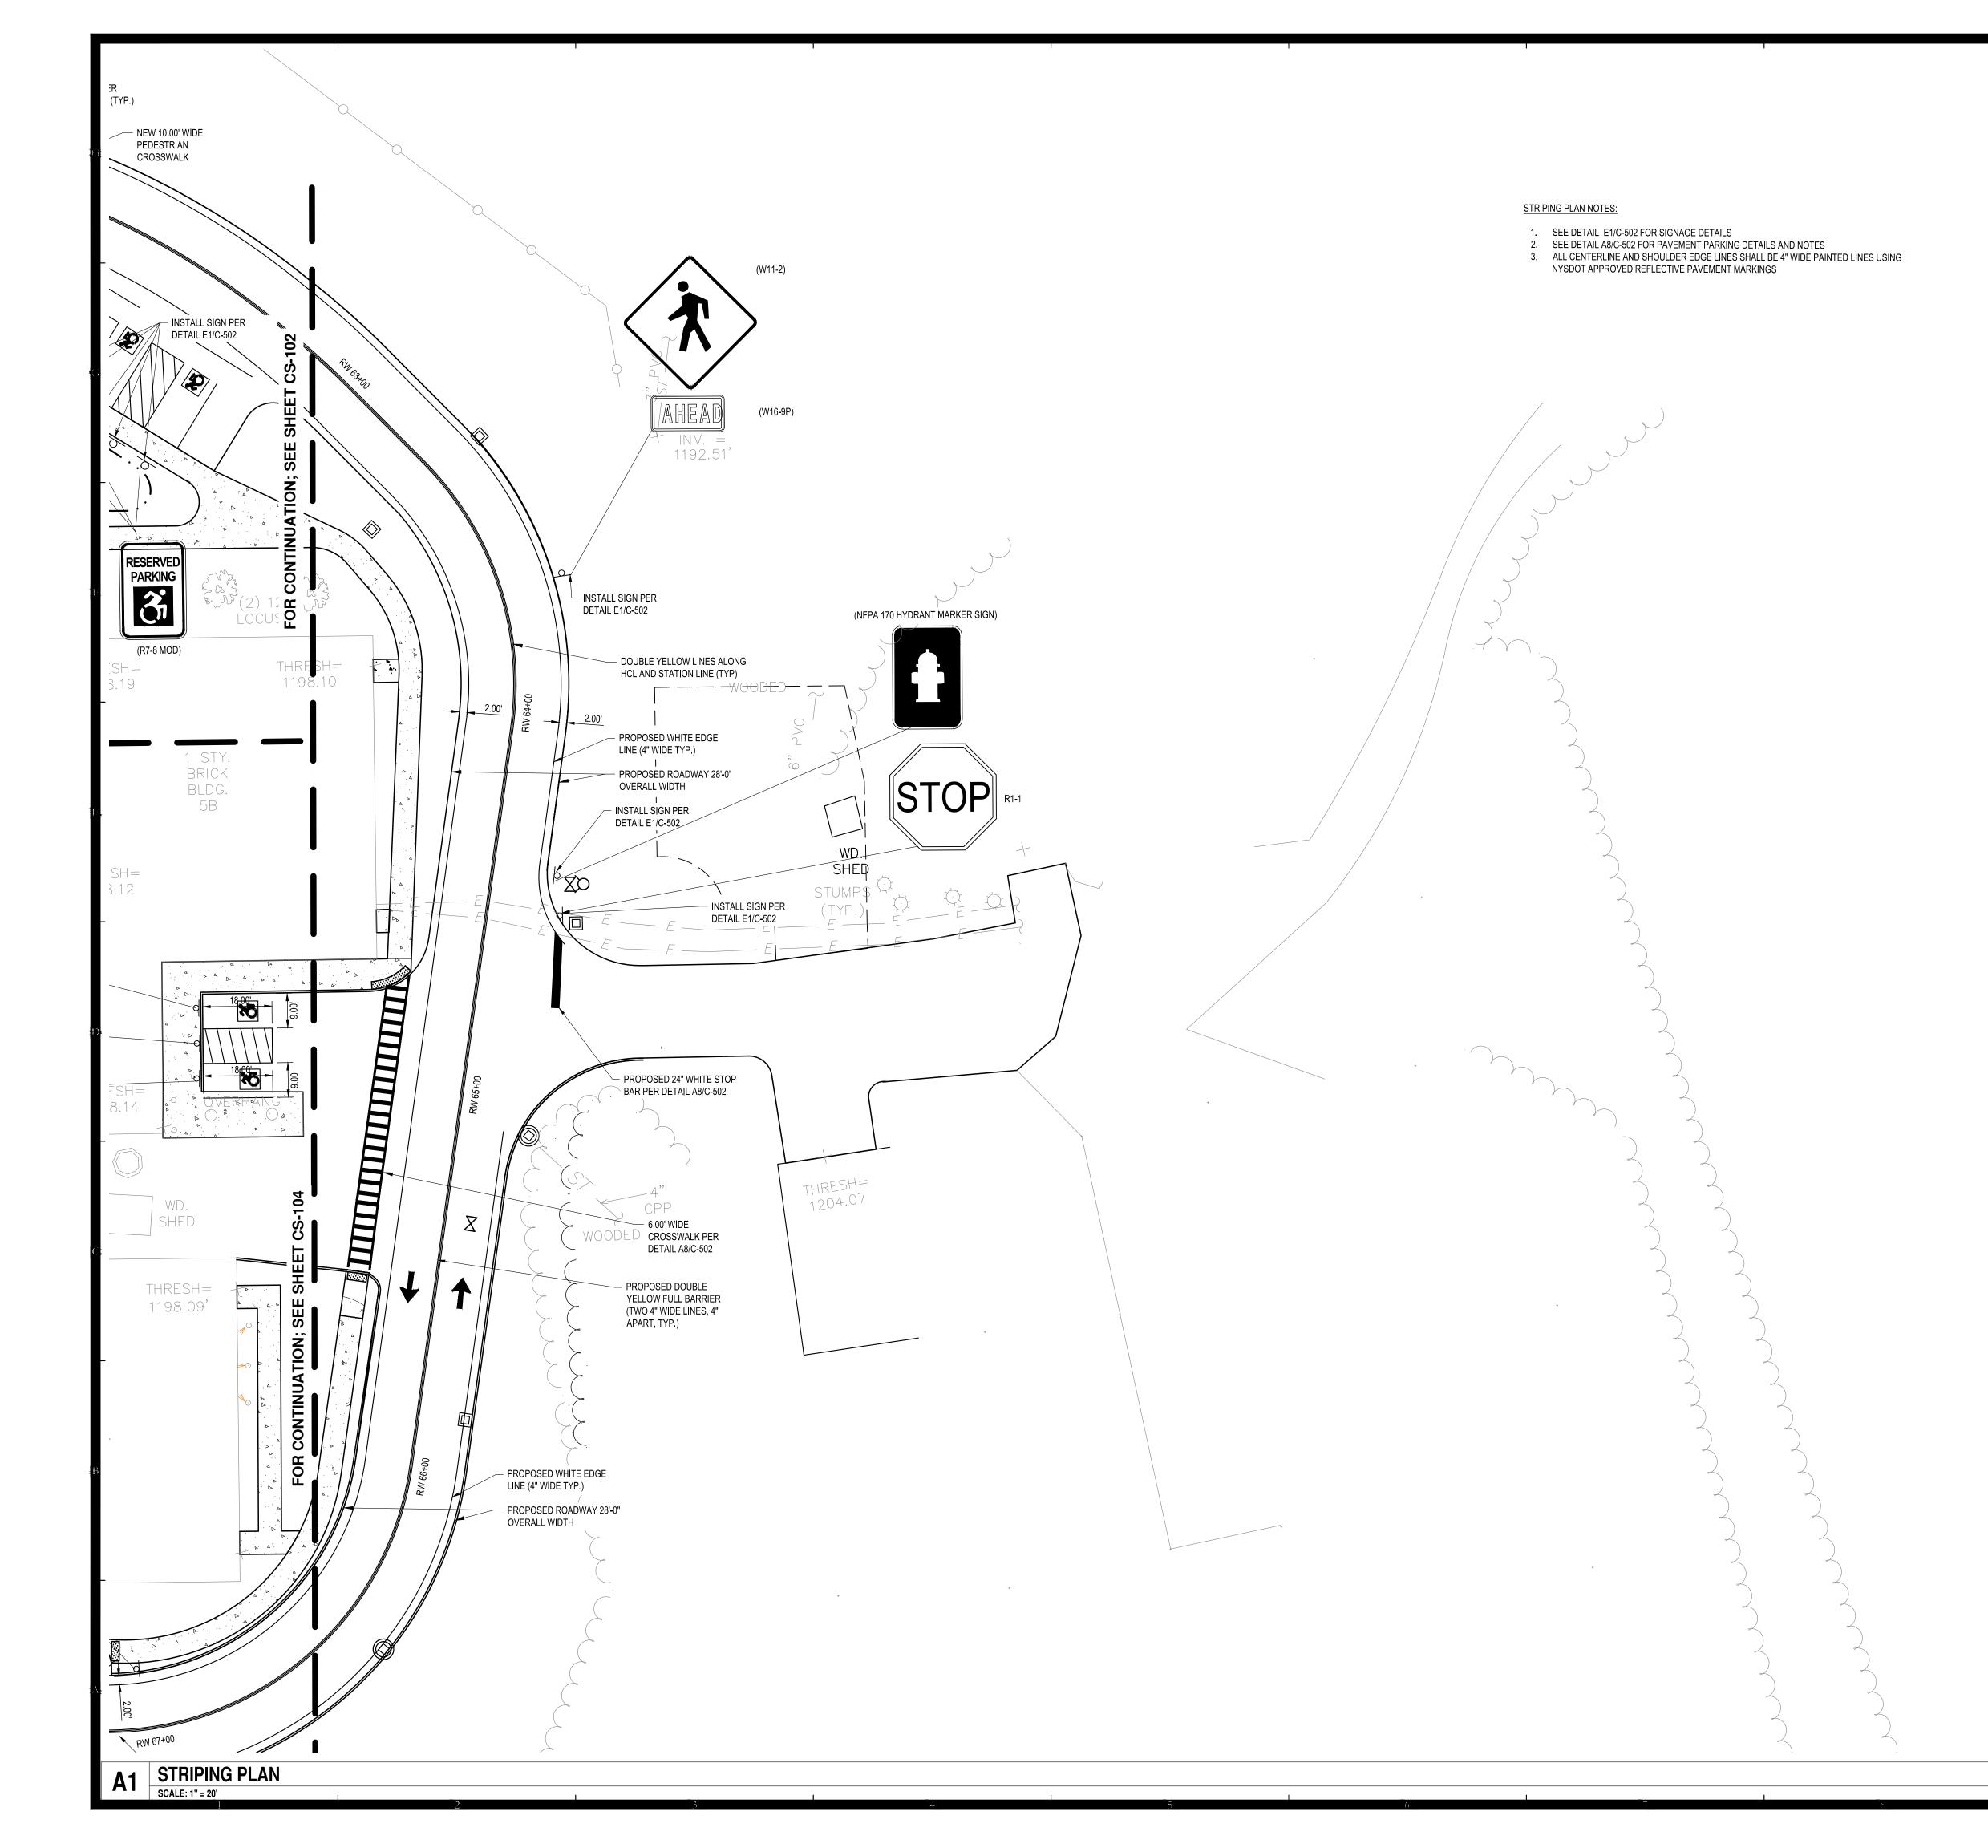


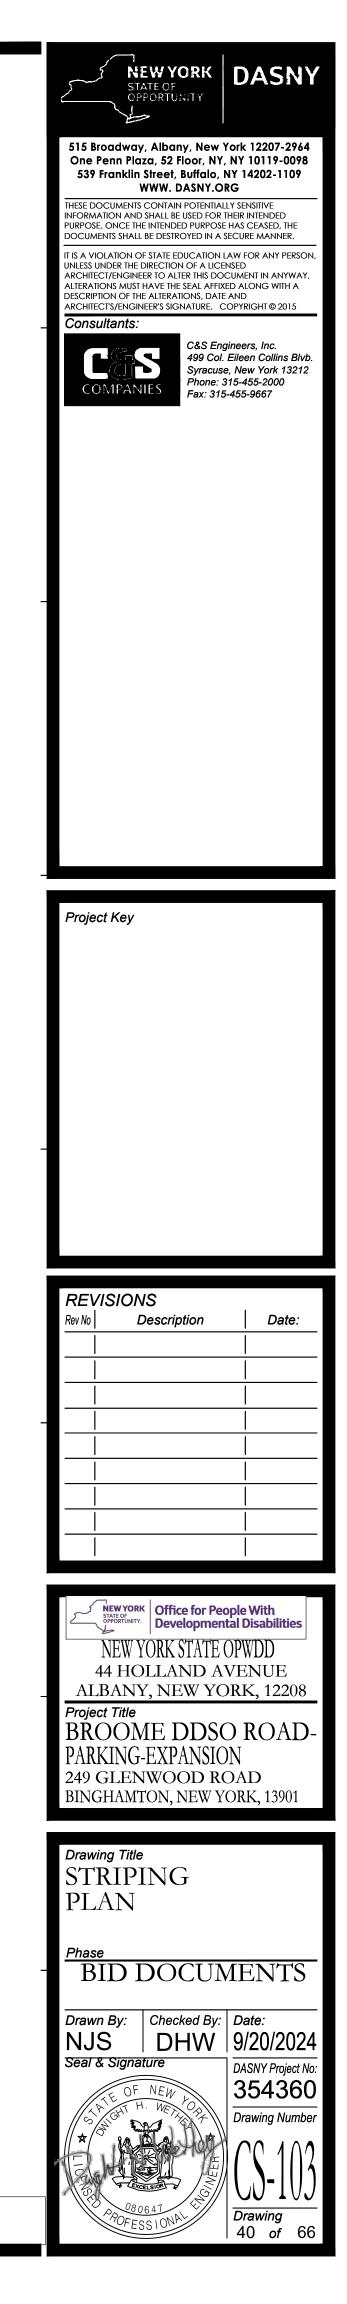


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	249 GLENWOOD ROAD BINGHAMTON, NEW YORK, 13901 Drawing Title GRADING PLAN <u>Phase</u> BID DOCUMENTS Drawn By: Checked By: Date:
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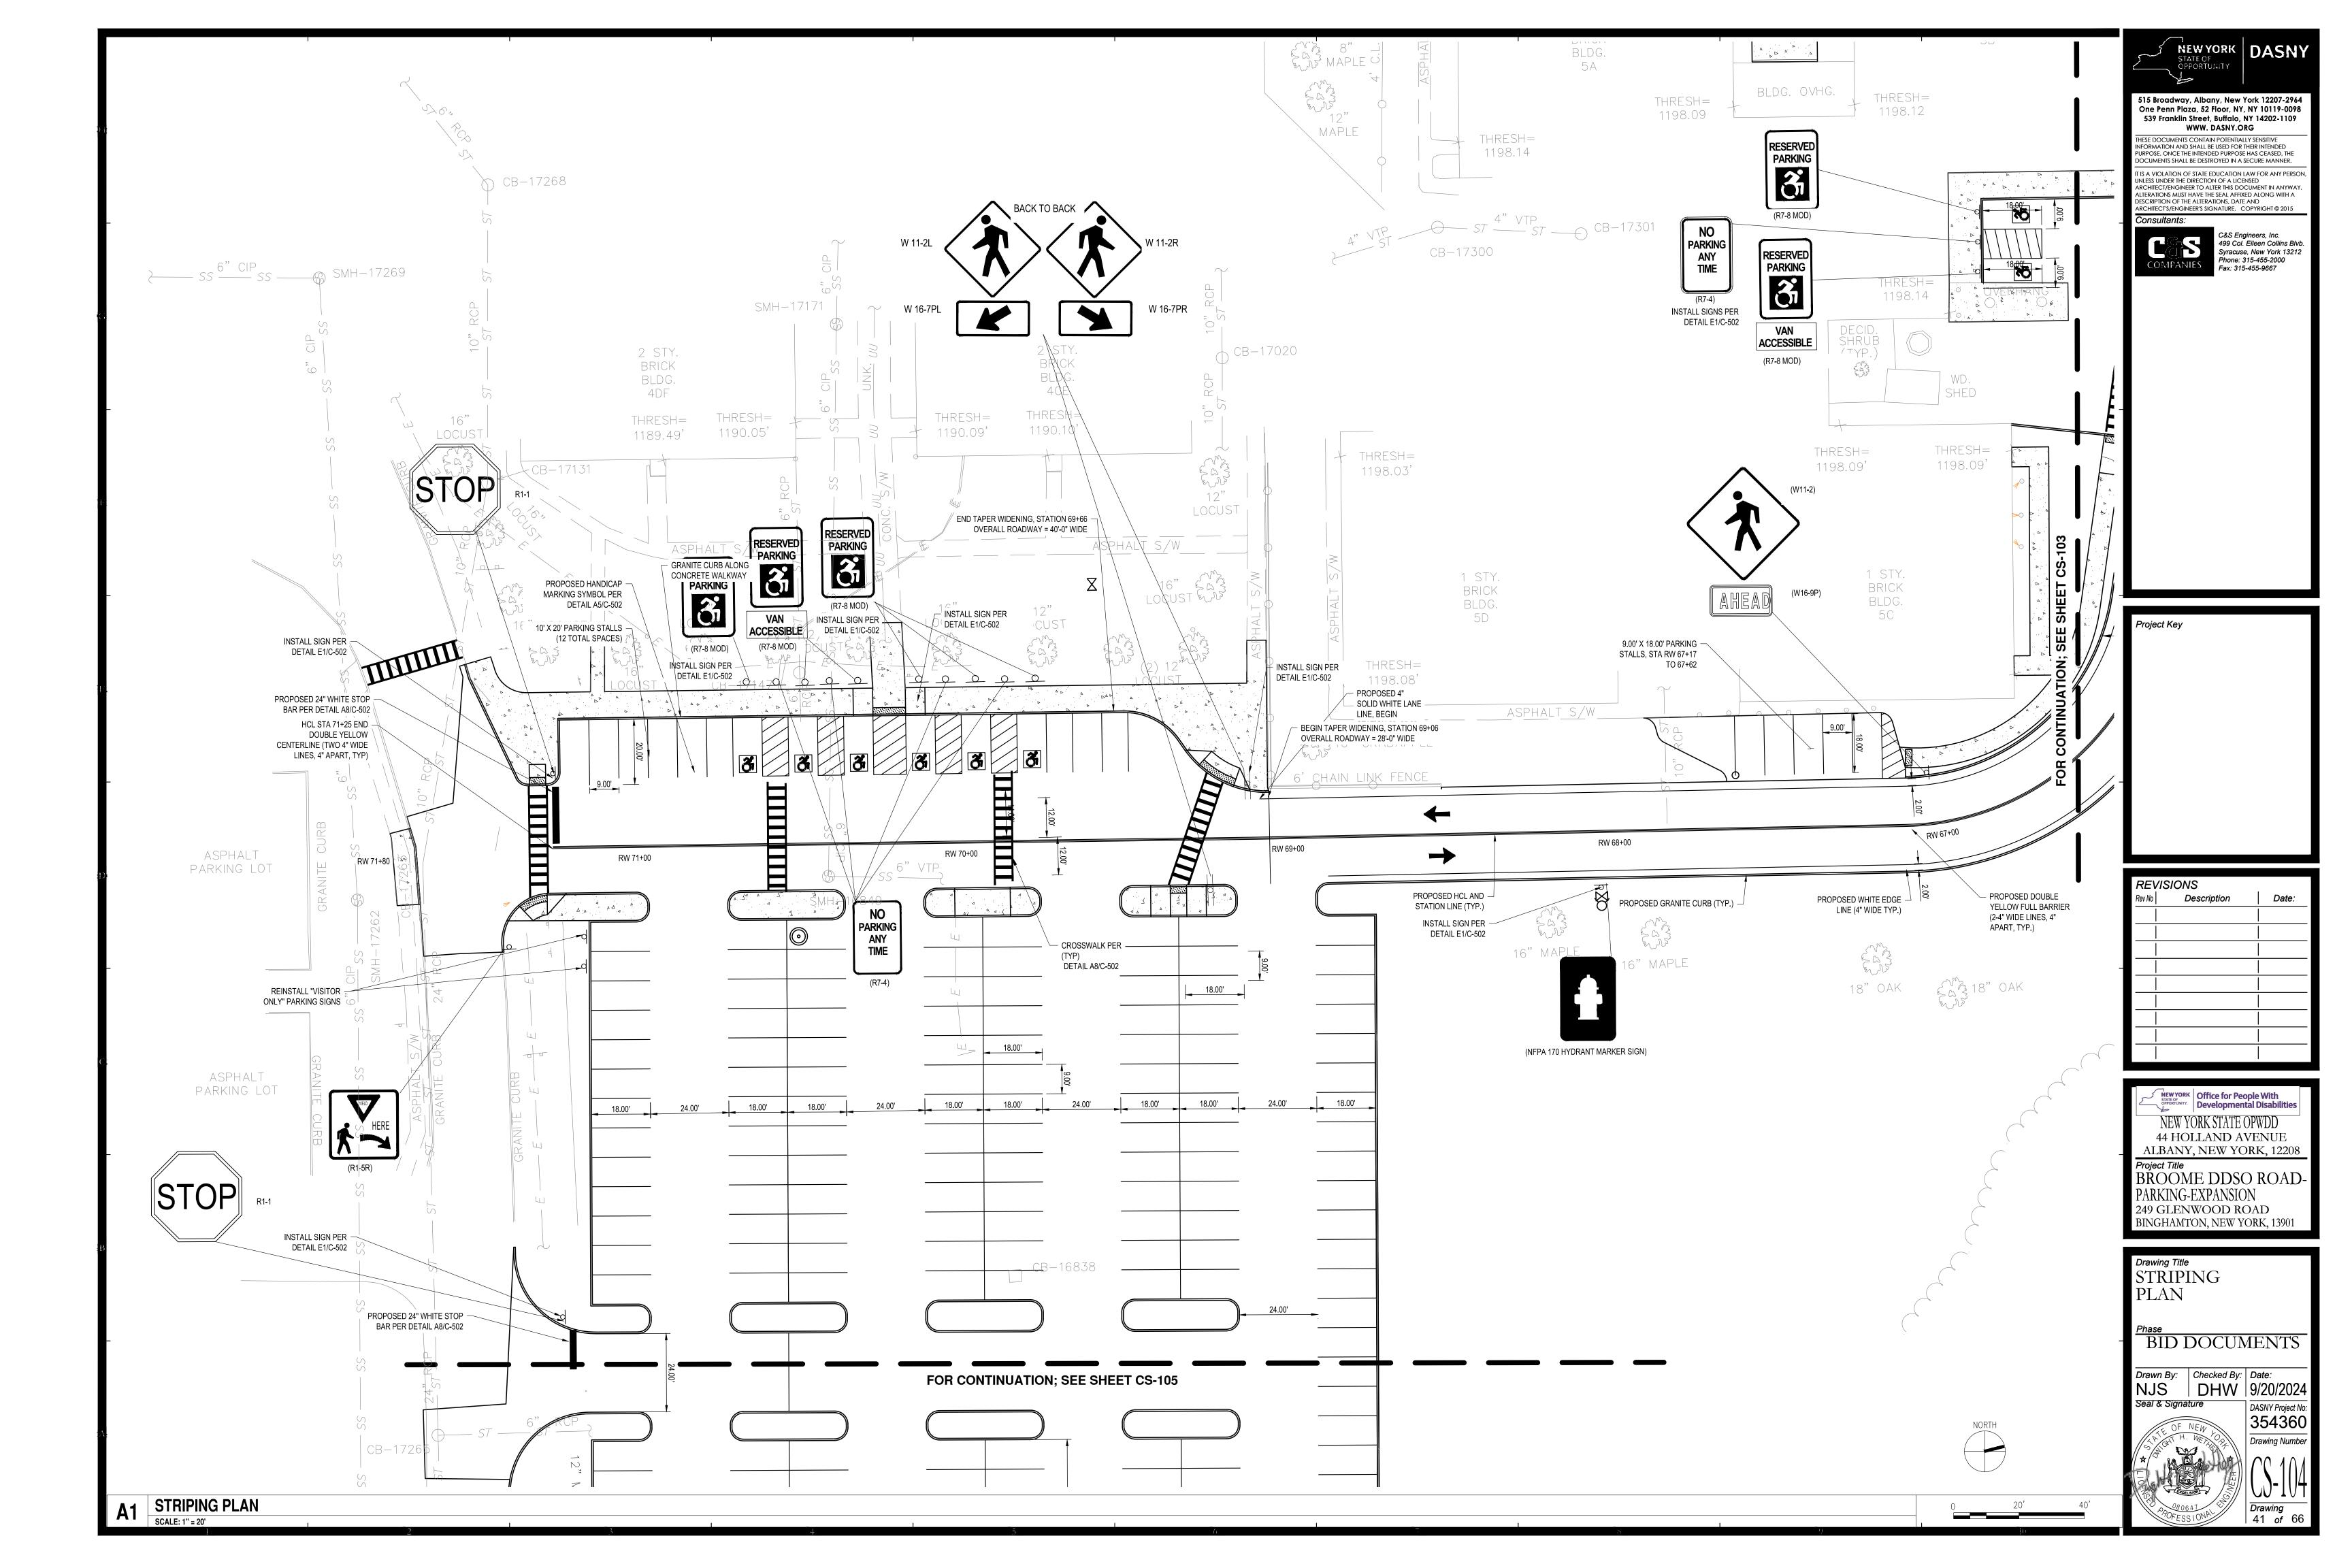


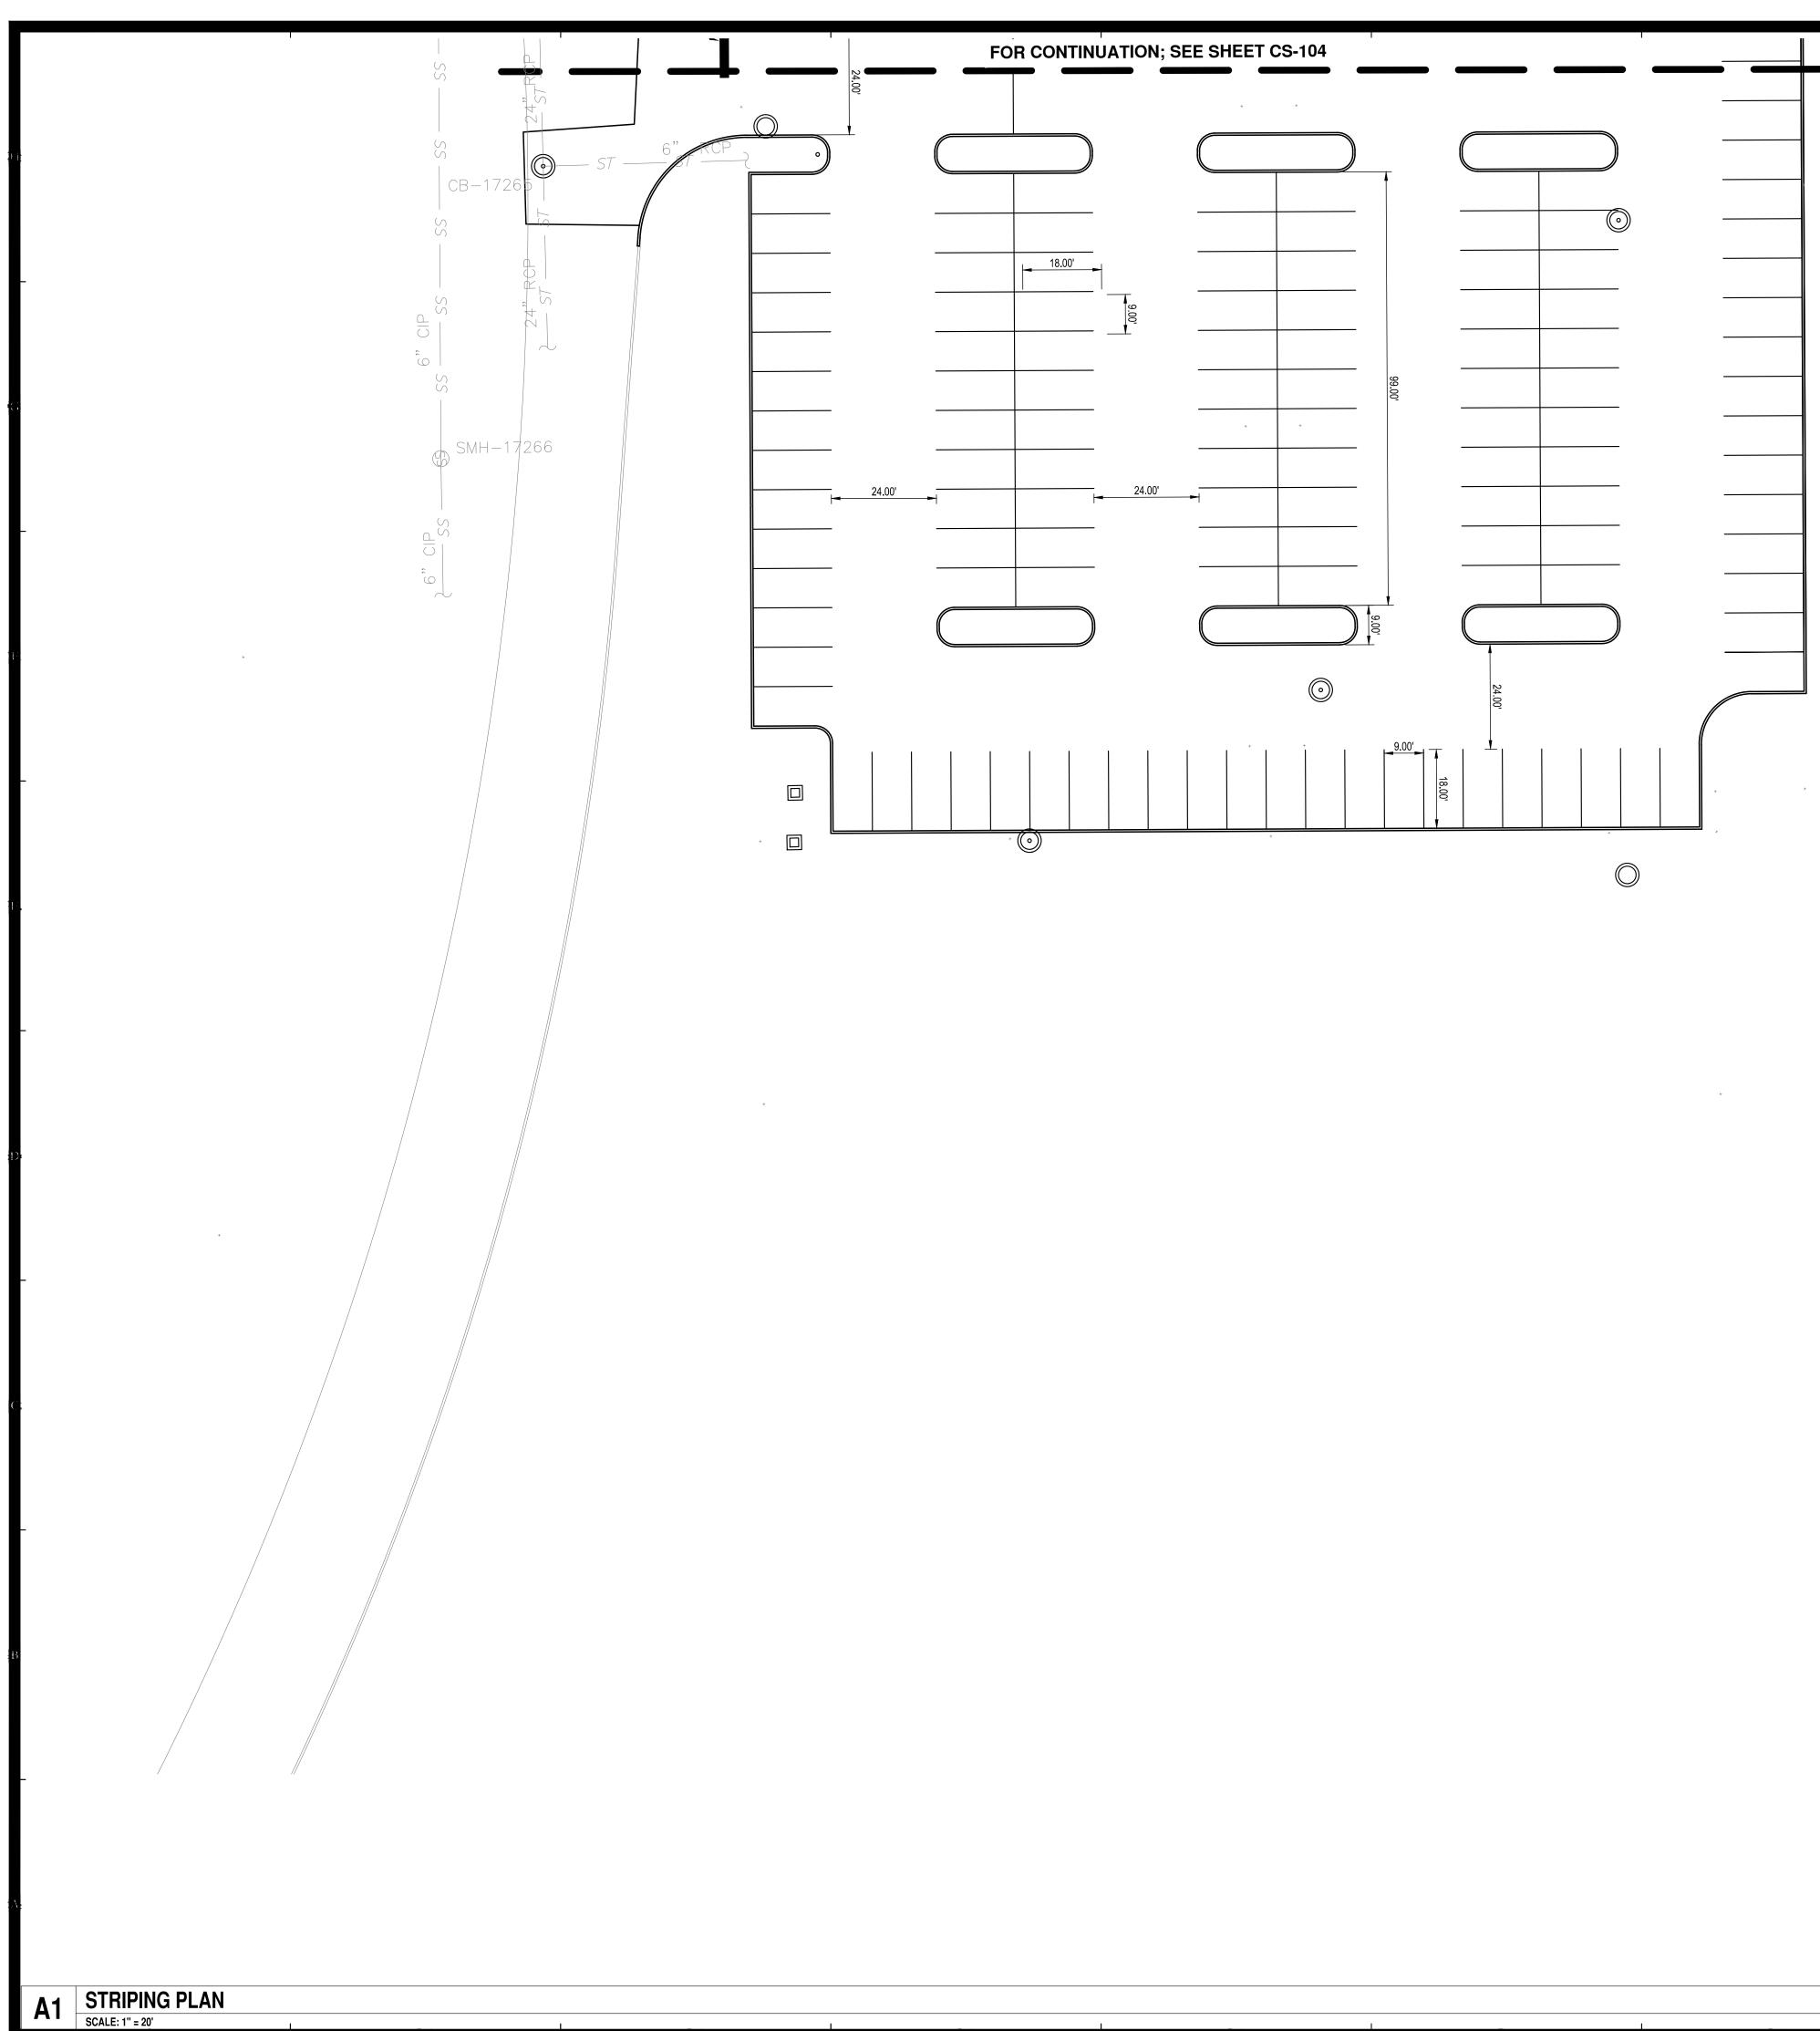






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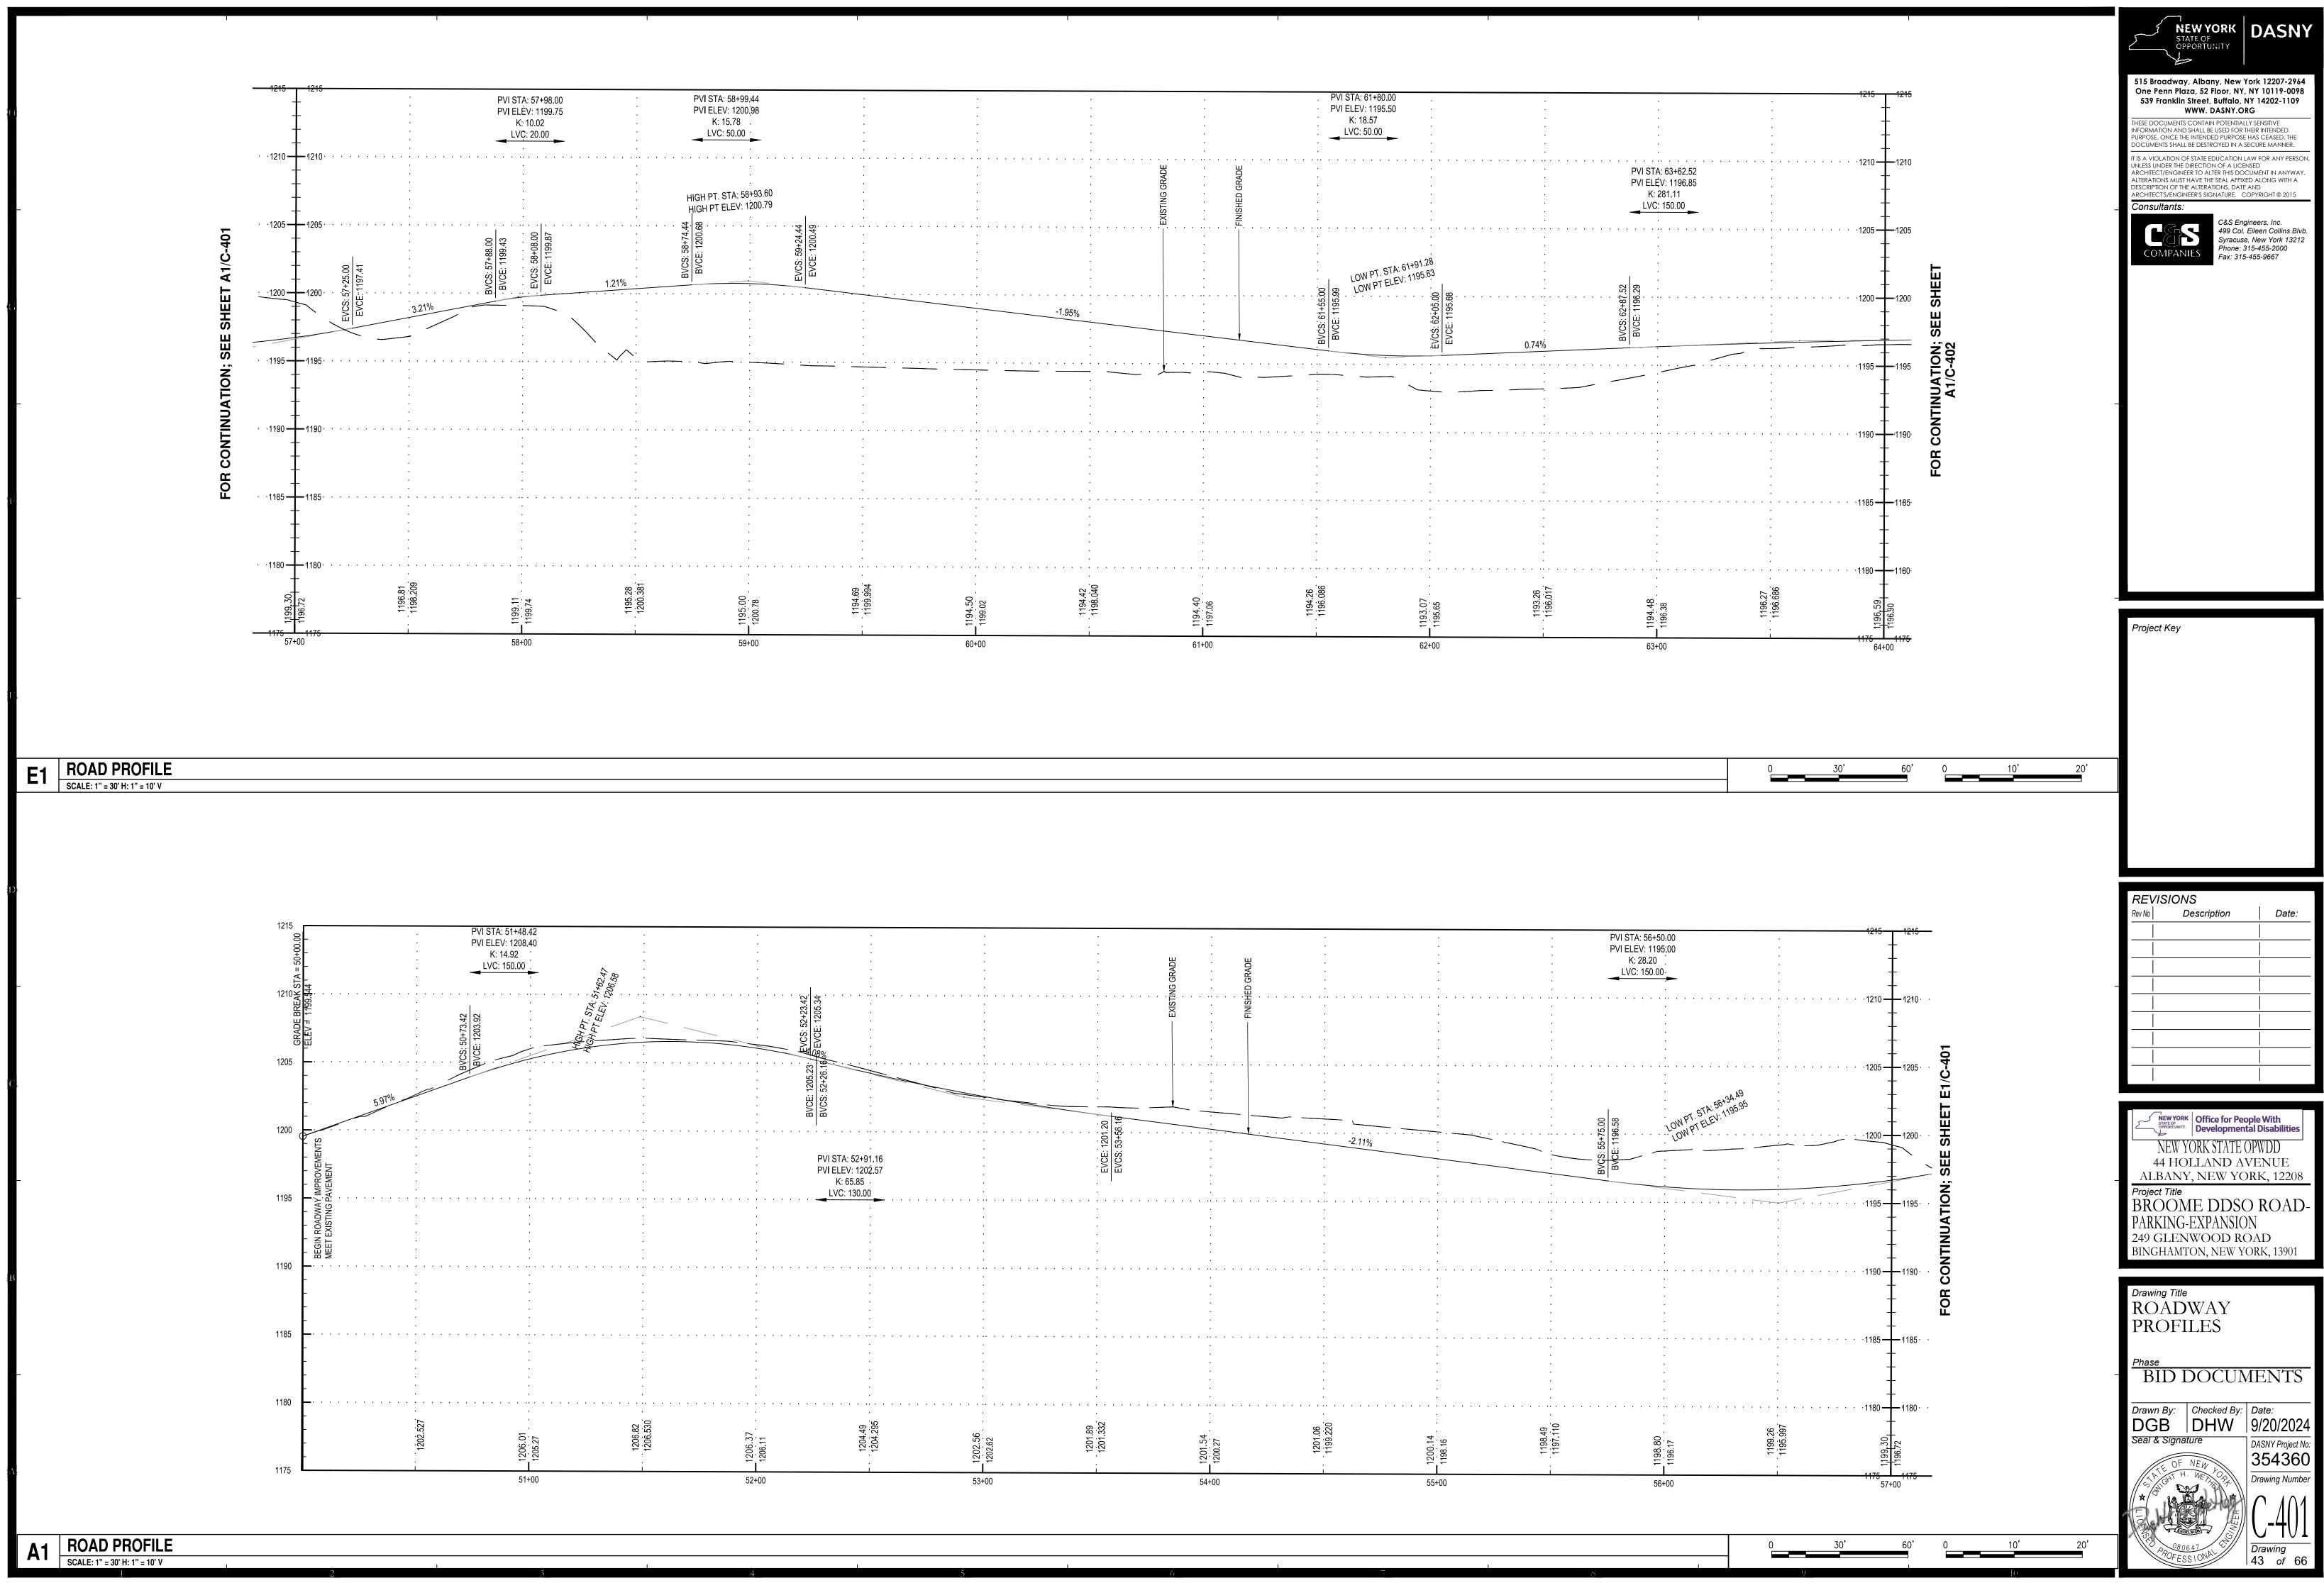


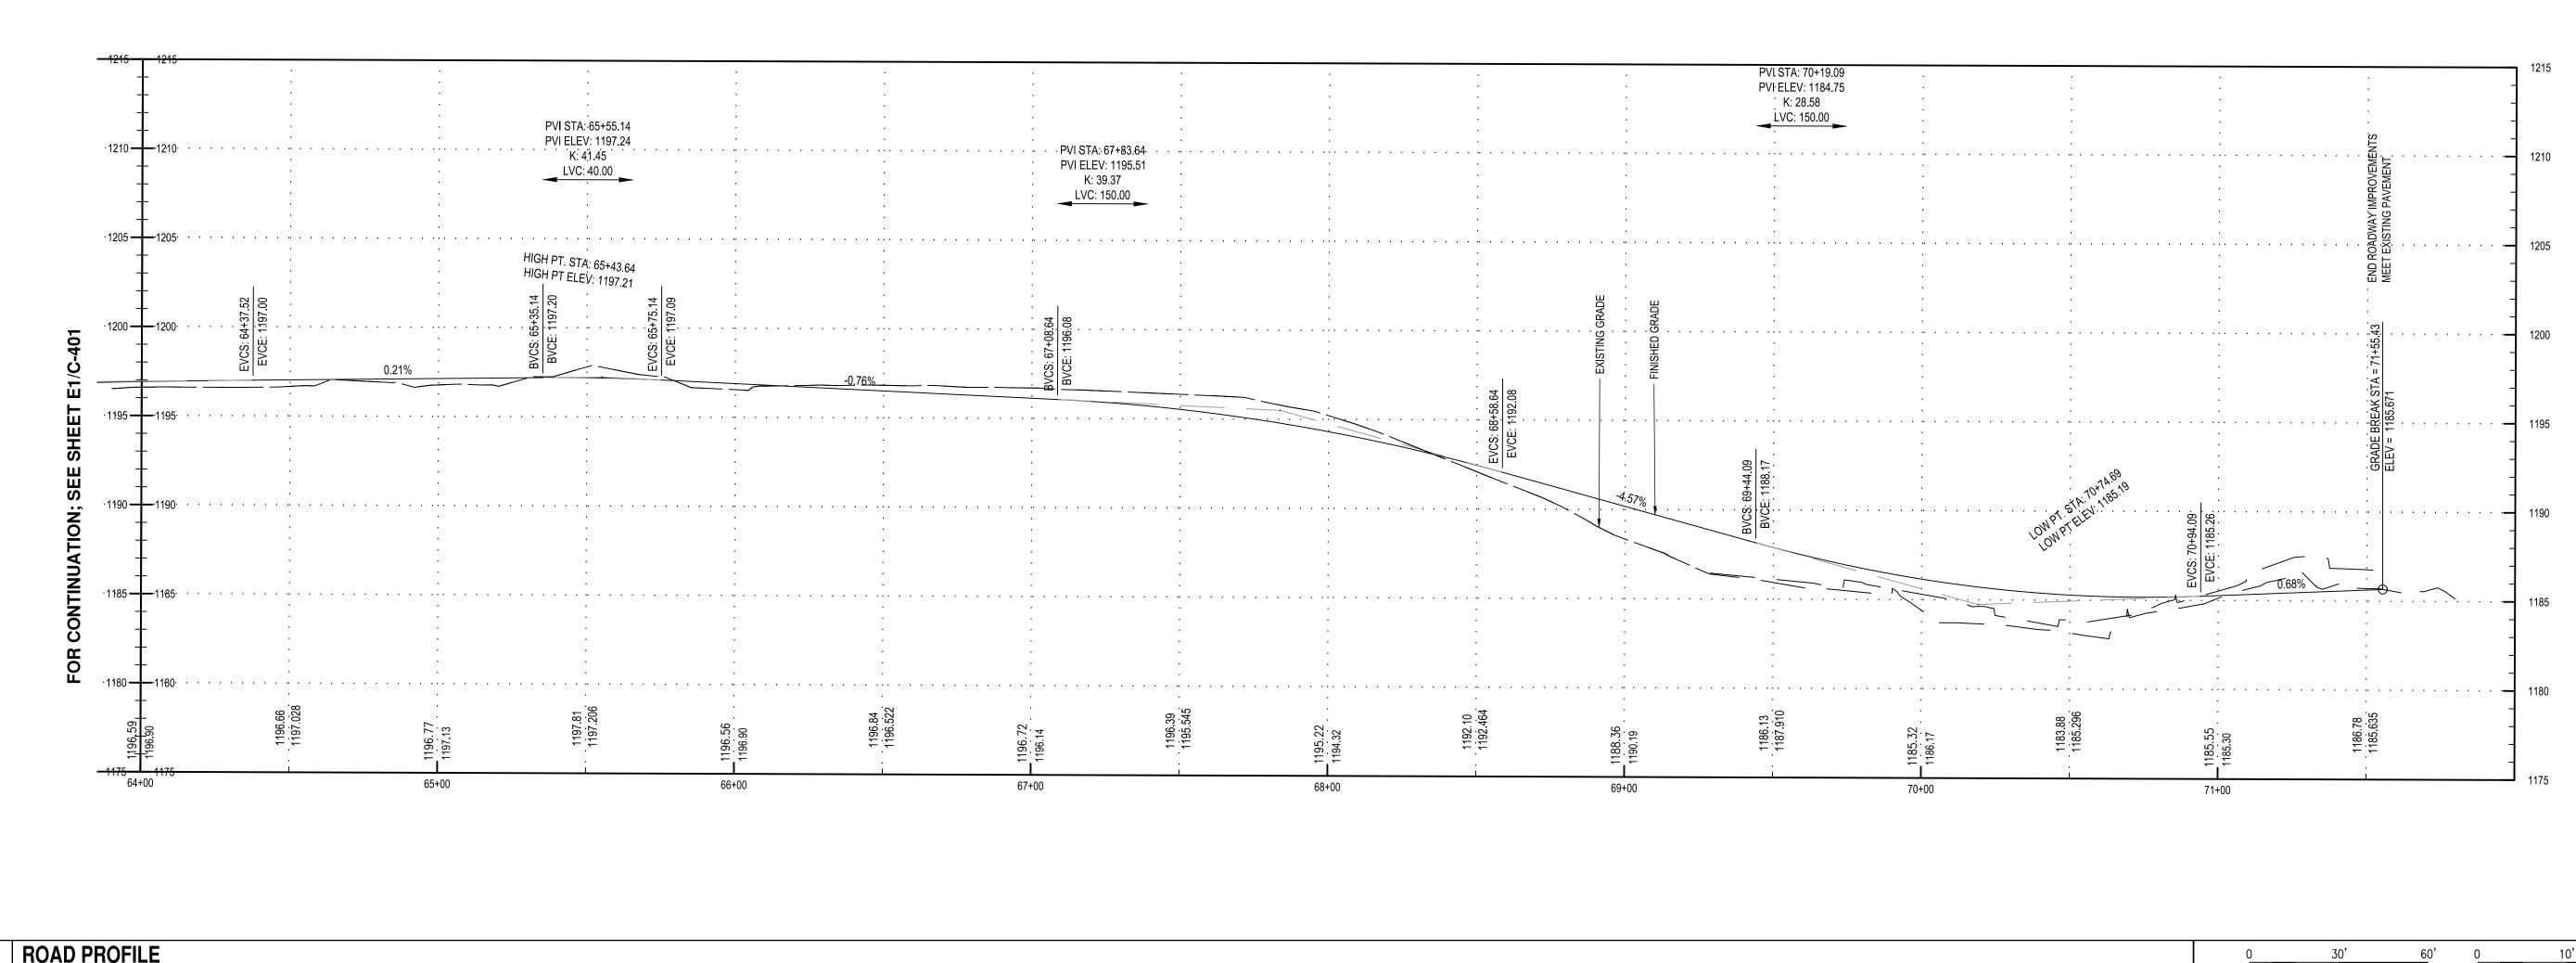


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-	
	Project Key
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	REVISIONS Rev No Description Date:
-	-
-	NEW YORK Developmental Disabilities NEW YORK STATE OPWDD 44 HOLLAND AVENUE ALBANY, NEW YORK, 12208
	Project Title BROOME DDSO ROAD- PARKING-EXPANSION 249 GLENWOOD ROAD BINGHAMTON, NEW YORK, 13901
	Drawing Title STRIPING PLAN
-	BID DOCUMENTS
	Drawn By:Checked By:Date:NJSDHW9/20/2024Seal & SignatureDASNY Project No:25.4260
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0 20' 40'	$\begin{array}{c} \hline \\ \hline $

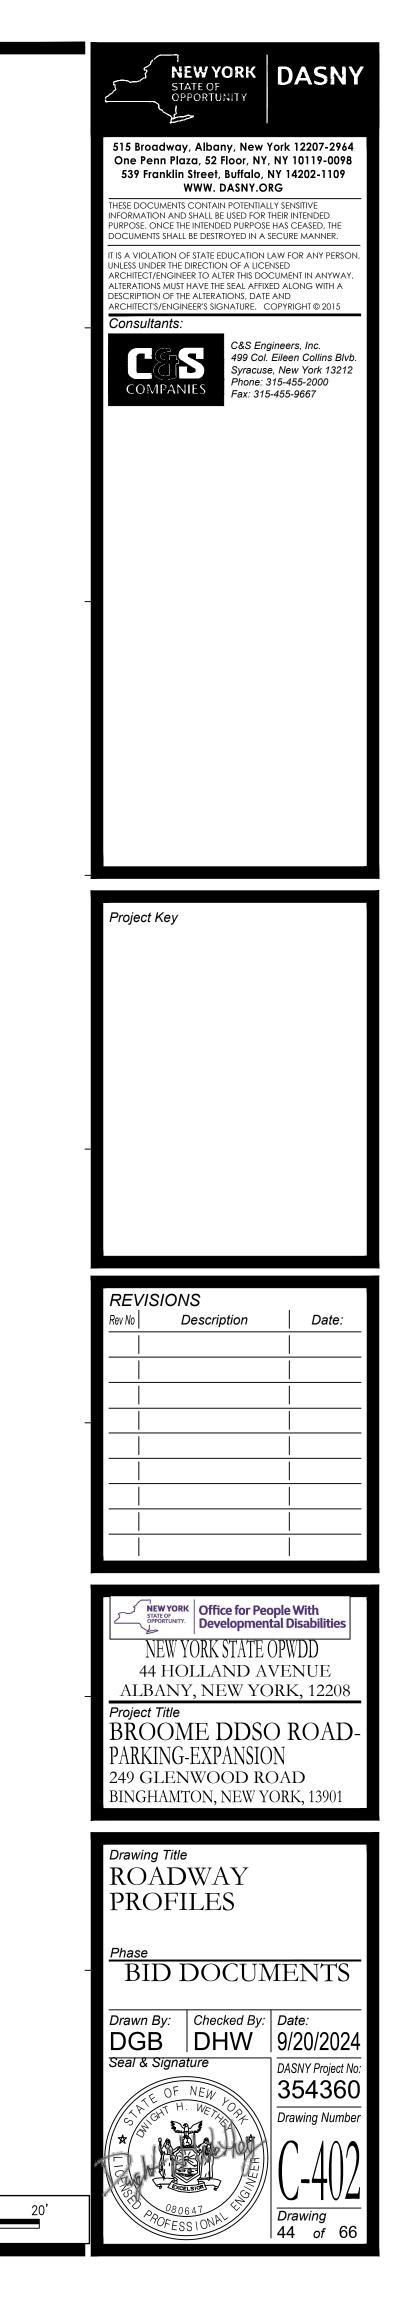
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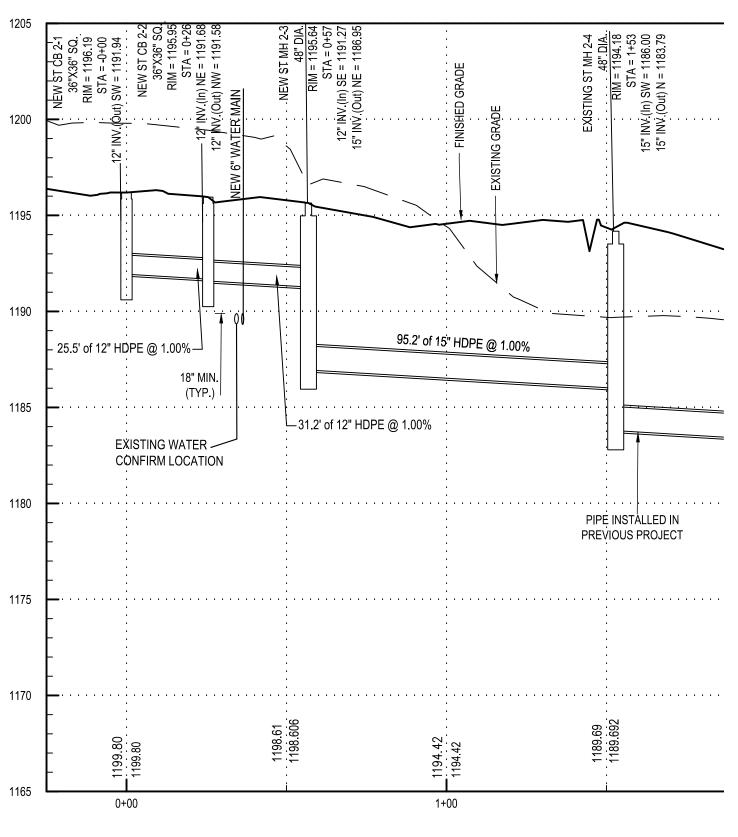


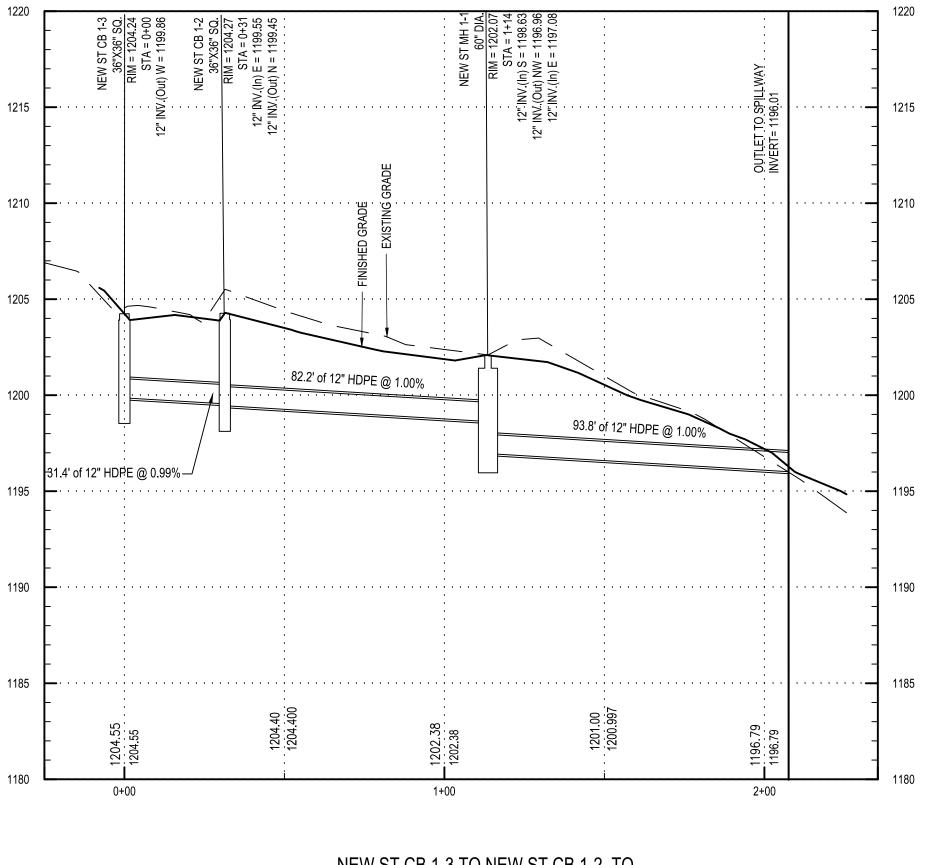


A1 **ROAD PROFILE** SCALE: 1" = 30' H: 1" = 10' V

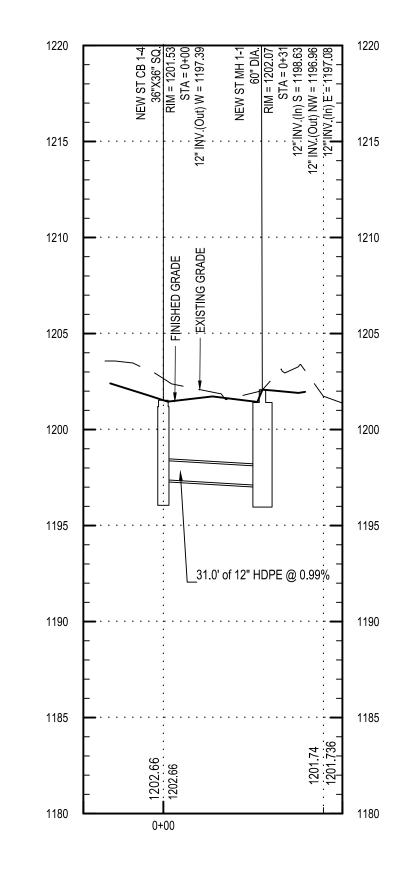


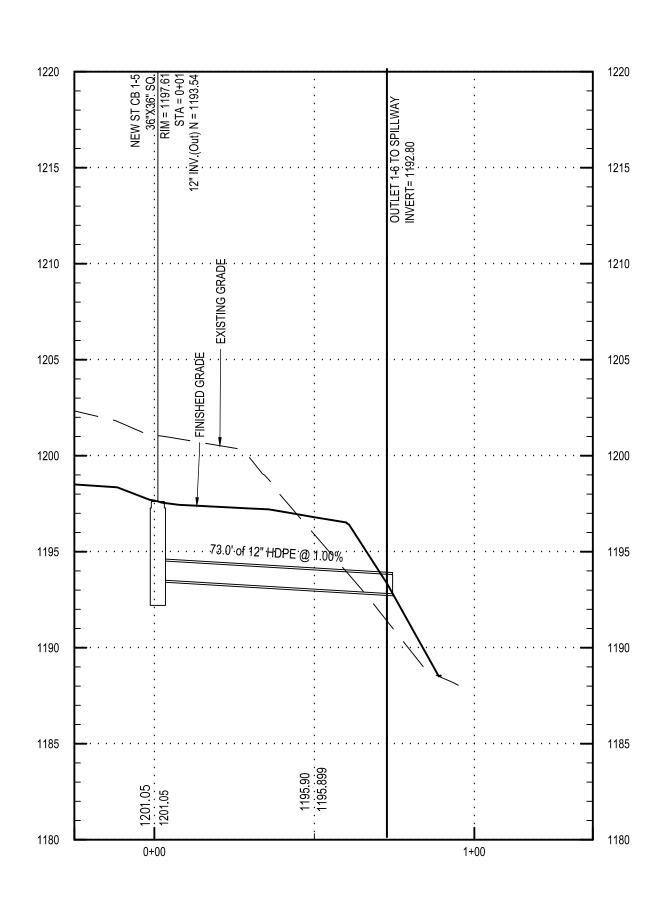






NEW ST CB 1-3 TO NEW ST CB 1-2 TO NEW ST MH 1-1 TO OUTLET 1-1A PROFILE





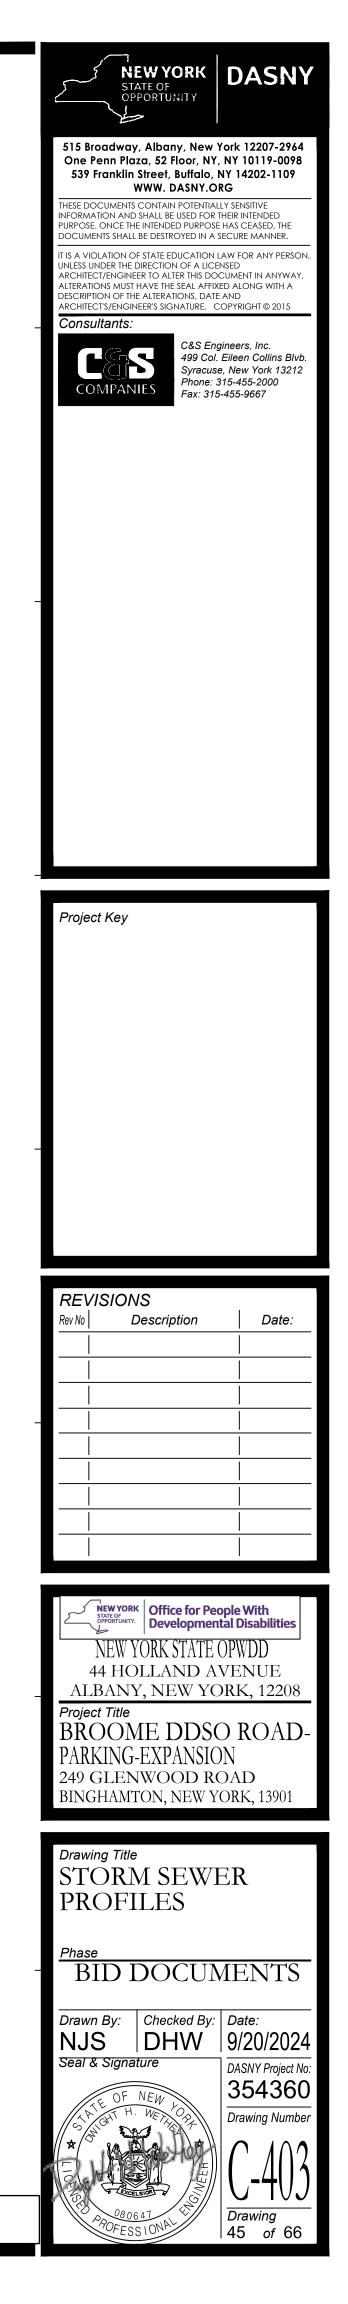
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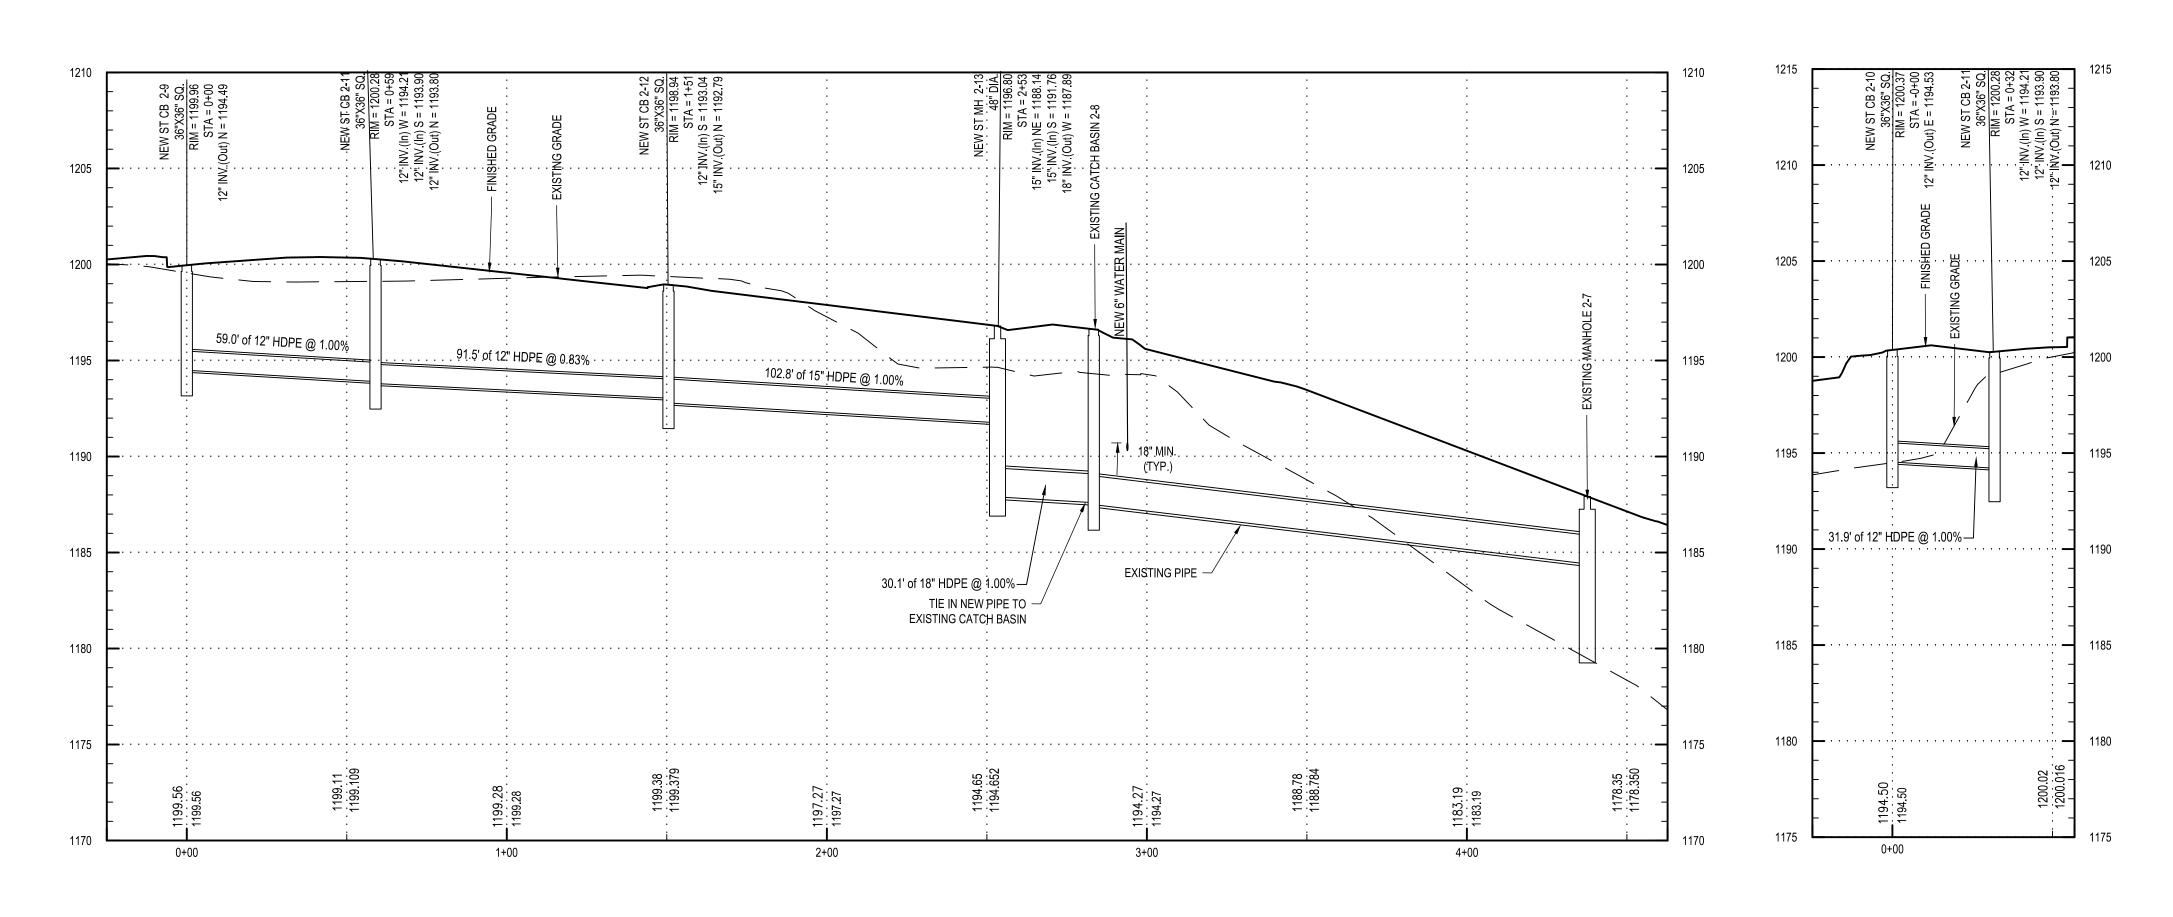
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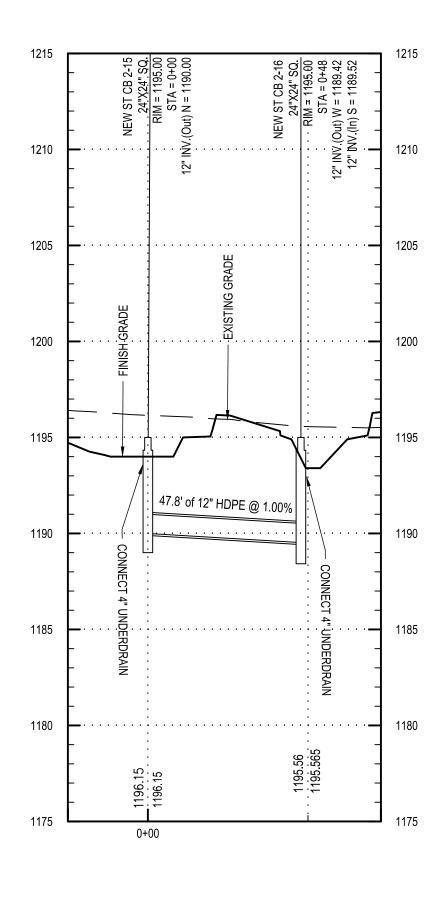
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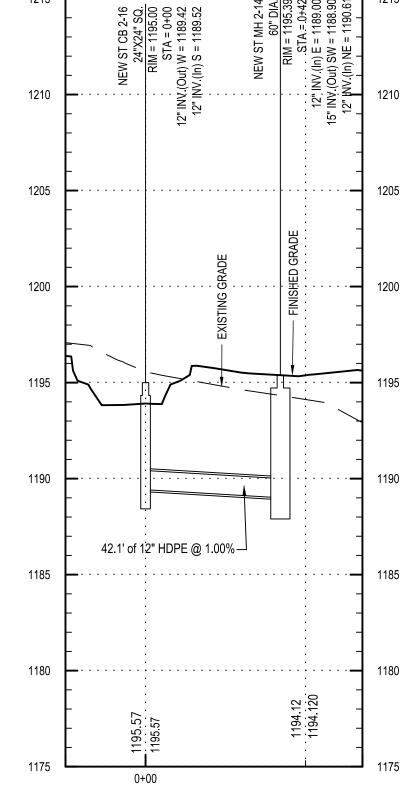
10'

30'





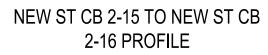




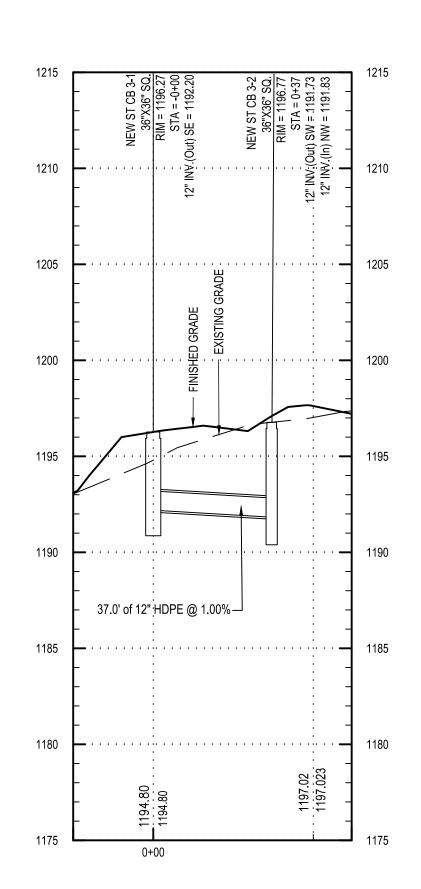
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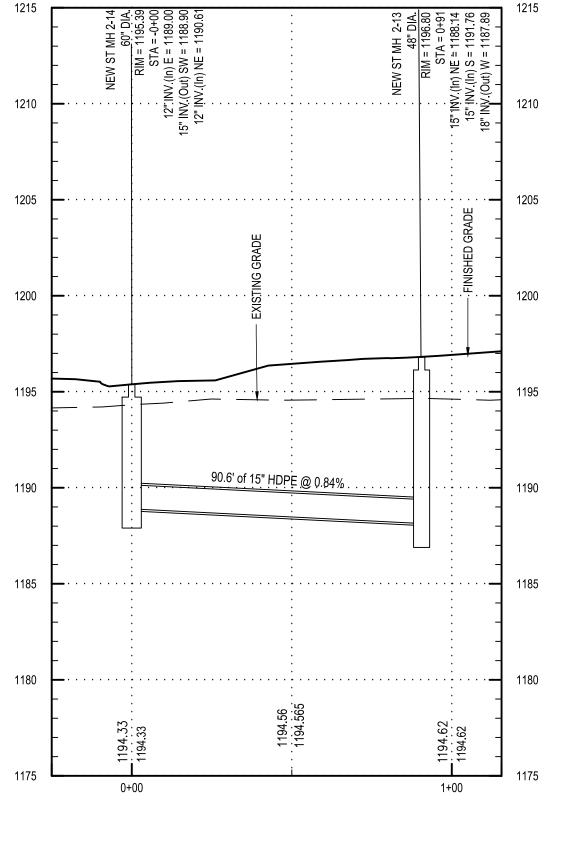
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NEW ST CB 2-16 TO NEW ST MH 2-14 PROFILE



NEW ST CB 2-9 TO NEW ST CB 2-11 TO NEW ST CB 2-12 TO NEW ST MH 2-13 TO EXIISTING ST CB 2-8 TO EXISTING ST MH 2-7

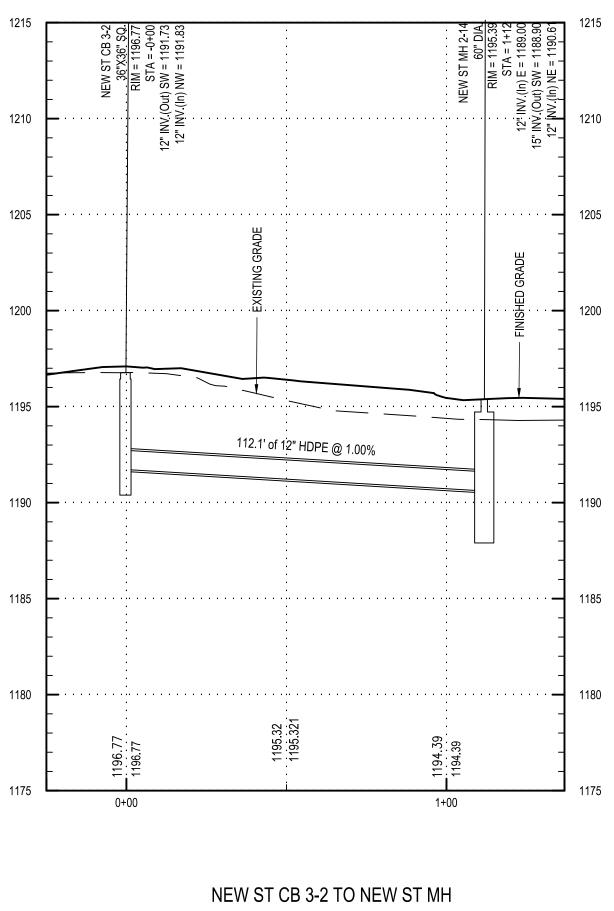




NEW ST MH 2-14 TO NEW ST MH 2-13 PROFILE

NEW ST CB 3-1 TO NEW ST CB 3-2 PROFILE

NEW ST CB 2-10 TO NEW ST CB 2-11 PROFILE



2-14 PROFILE

30'

60'

10'

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 NEW YORK
 Office for People With

 STATE OF OPPORTUNITY.
 Developmental Disabilities
 NEW YORK STATE OPWDD 44 HOLLAND AVENUE ALBANY, NEW YORK, 12208 Project Title **BROOME DDSO ROAD-**PARKING-EXPANSION 249 GLENWOOD ROAD BINGHAMTON, NEW YORK, 13901 Drawing Title STORM SEWER PROFILES BID DOCUMENTS Drawn By: Checked By: Date: NJS DHW 9/20/2024 Seal & Signature DASNY Project No 354360 Drawing Number

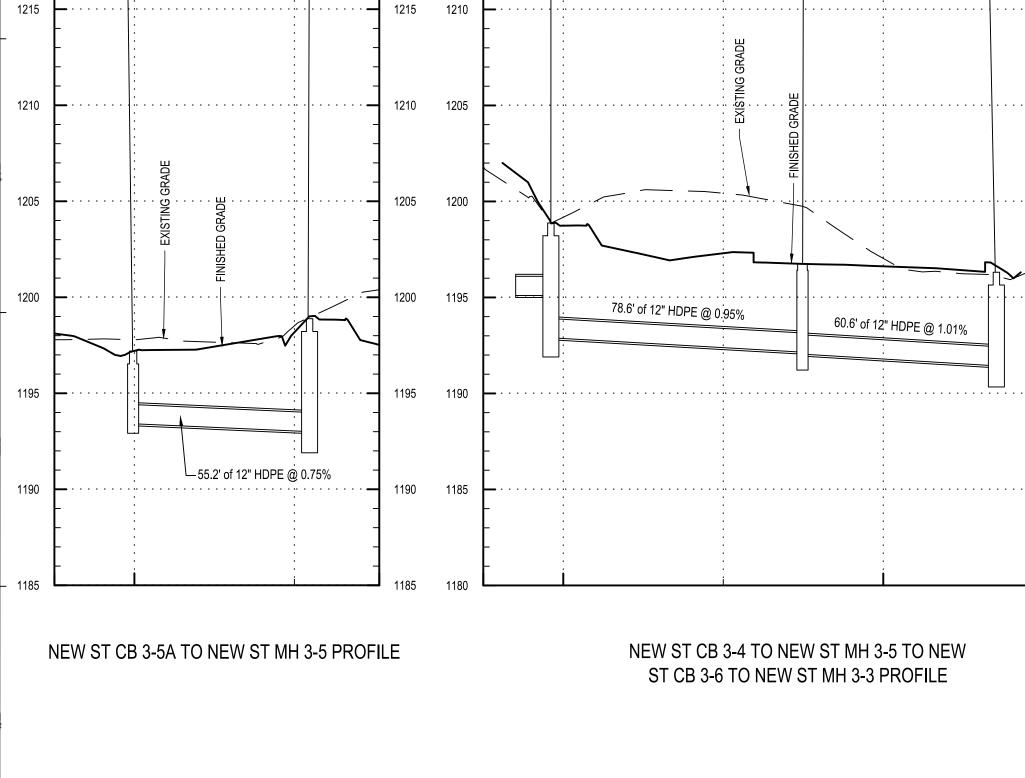
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-404

Drawing 46 of 66

ST CB 3-5A 24"X24" SQ. <u>RIM = 1197.19</u> STA = -0+00 SE = 1193.41 SE = 1193.41

1220



192 - 0+ 192 - 193 193 - 192 - 193

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<u>1</u>3

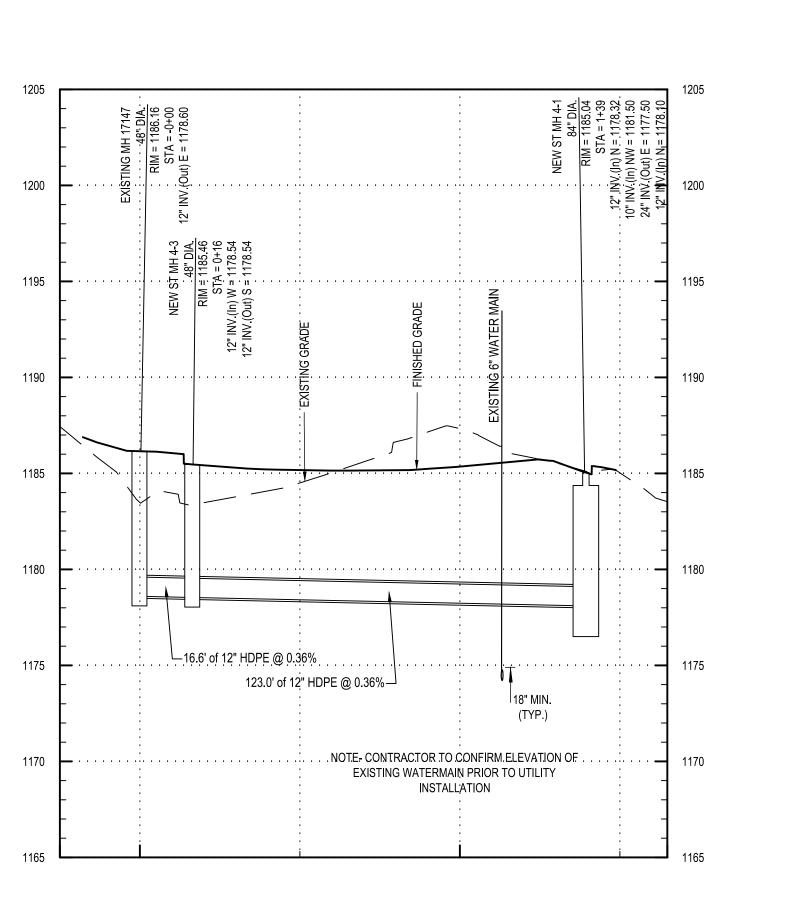


T MH 3-5 48" DIA 1198.88 A = 0+55 1192.90 1192.90 1193.00

SE STA

ר) או "י 12" וועע (י

1220 1215



1215

1210

1205

1200

1195

1190

1185

1180

1175

T MH 3-3 48" DIA = 1196 31 A = 2+35 = 1191 34

<u>N</u>

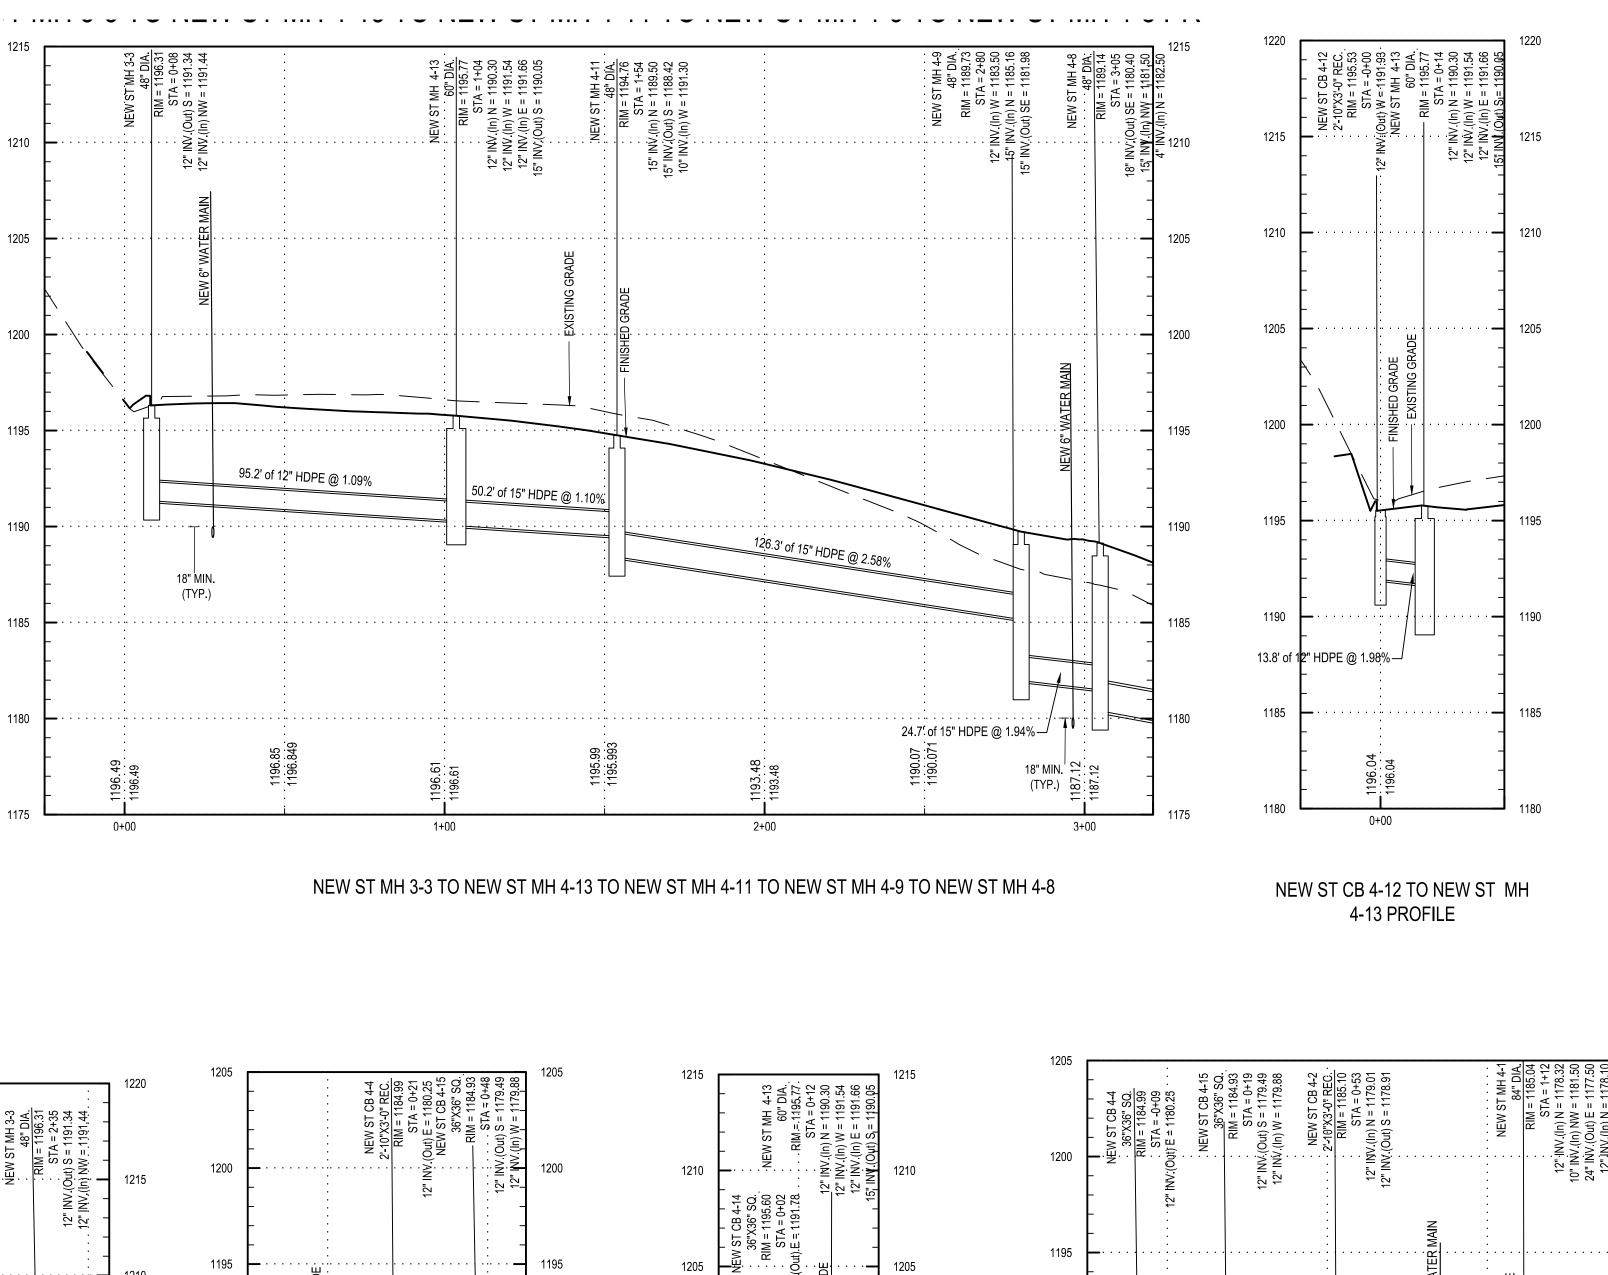
12" |2"|

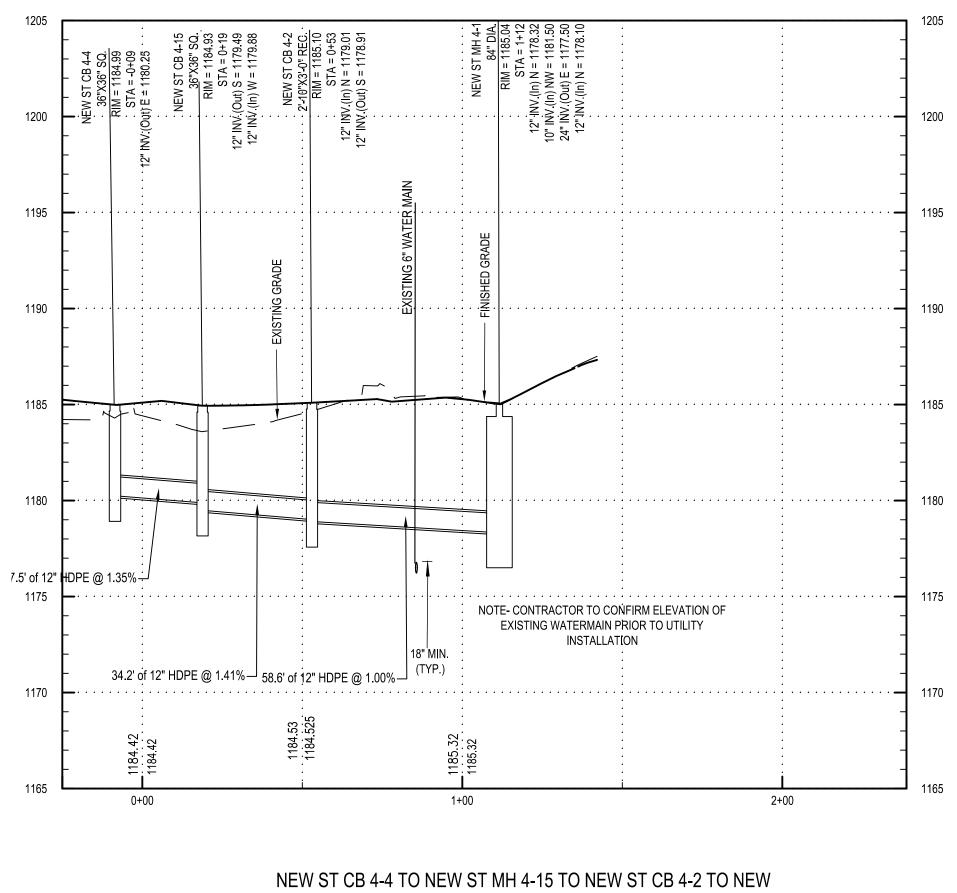
NEW ST CB 3-6 2'-10'X3-0" REC. .RIM = 1196.75 STA = 1+75 n) NW = 1192.15 u(t) SE = 1192.05

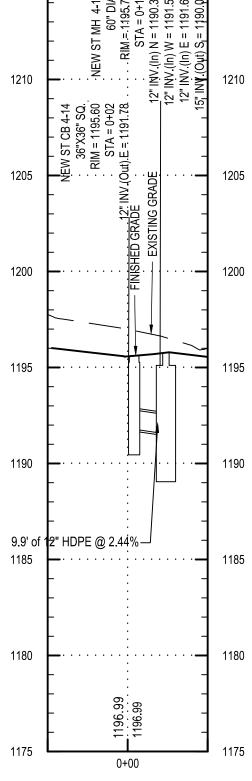
(in) (Out)

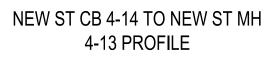
NN .

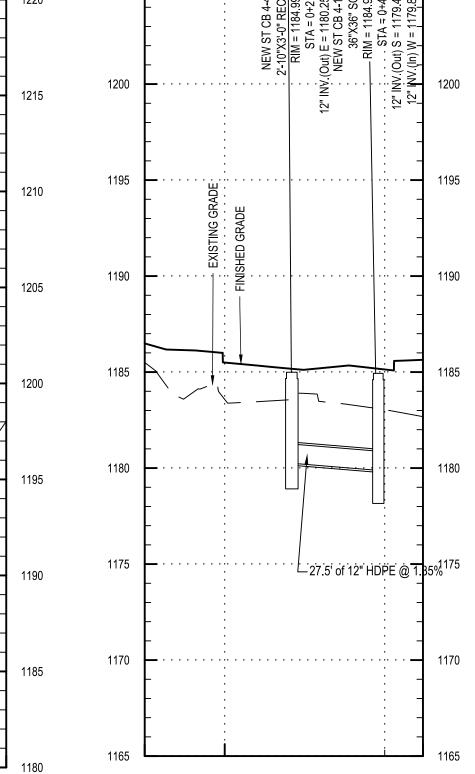
12" 12"

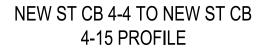


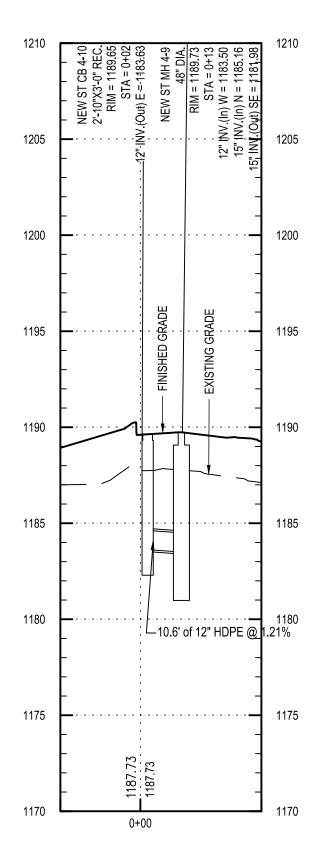






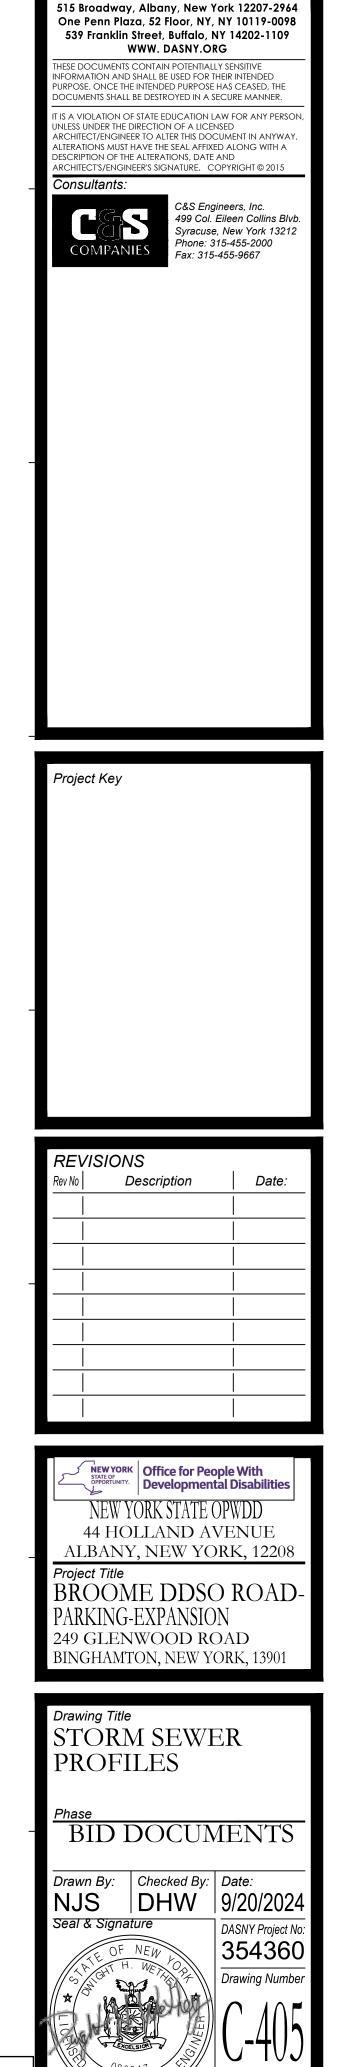






NEW ST CB 4-10 TO NEW ST MH 4-9 PROFILE

60'

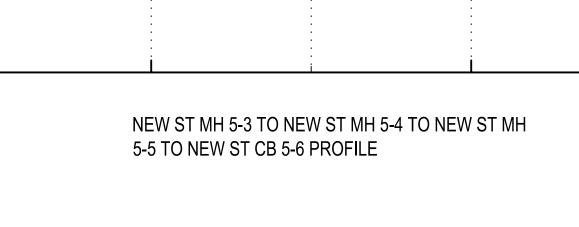


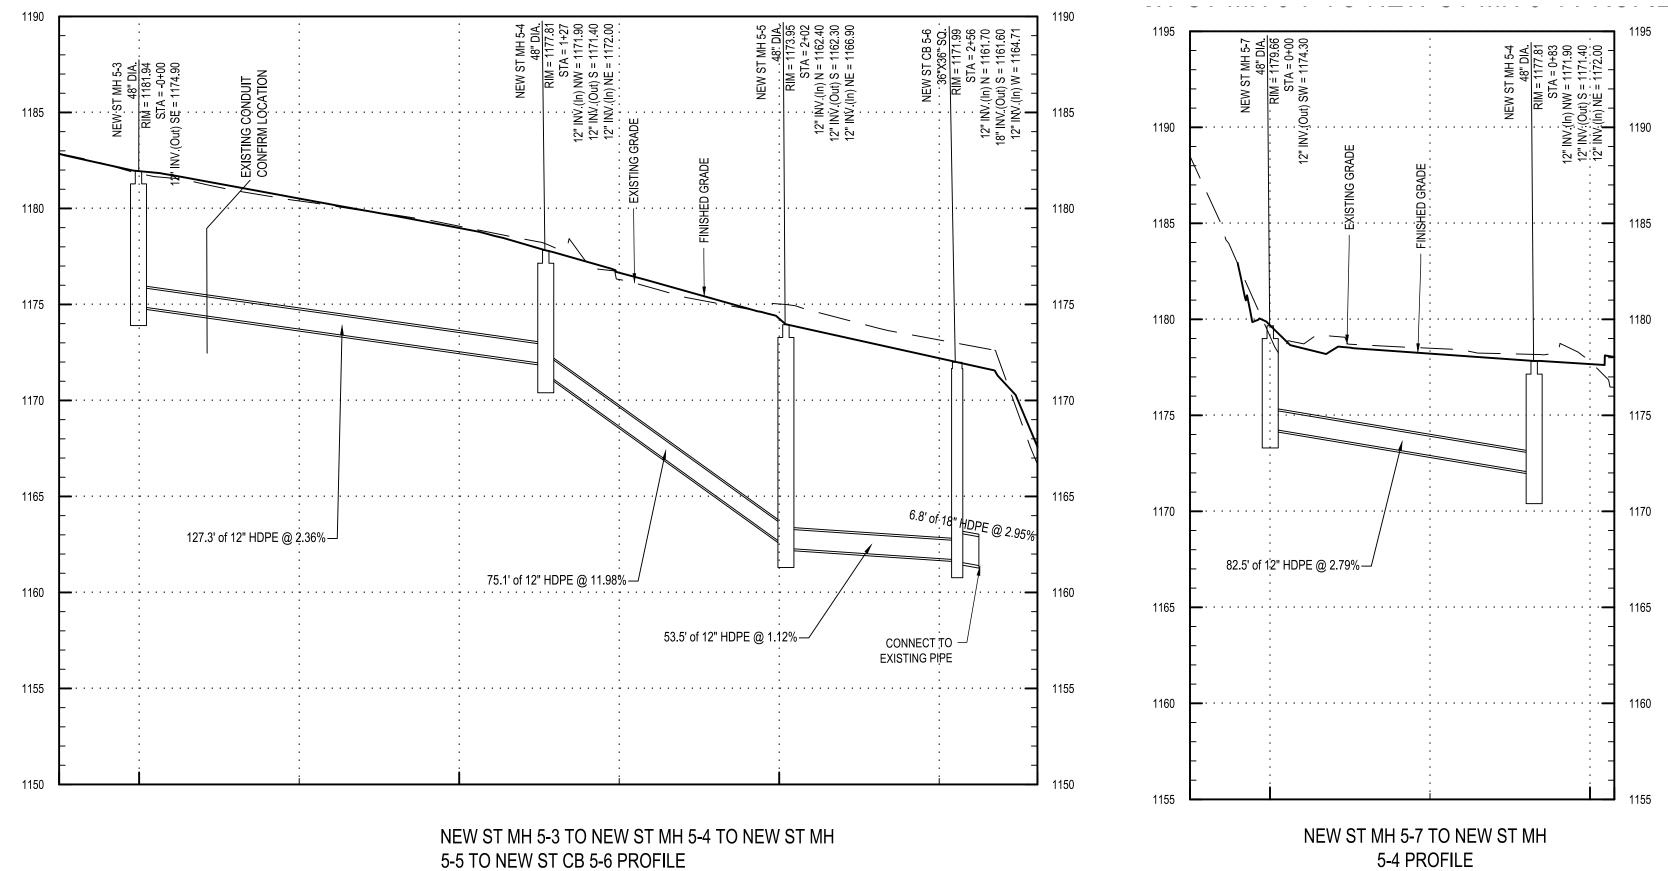
Drawing 47 of 66

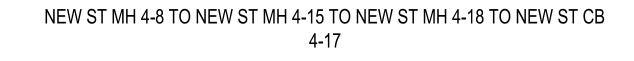
NEW YORK DASNY

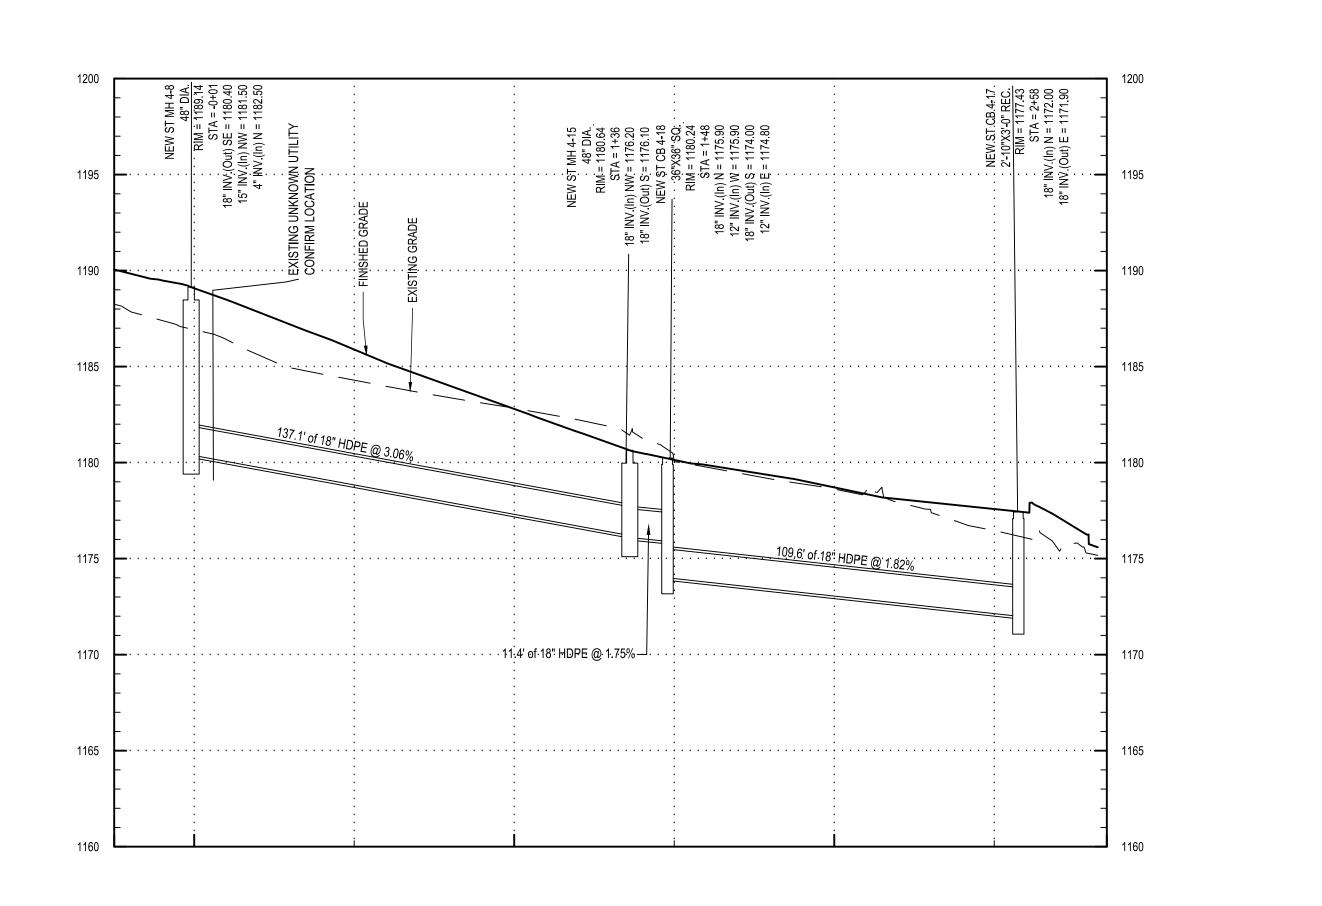
STATE OF OPPORTUNITY

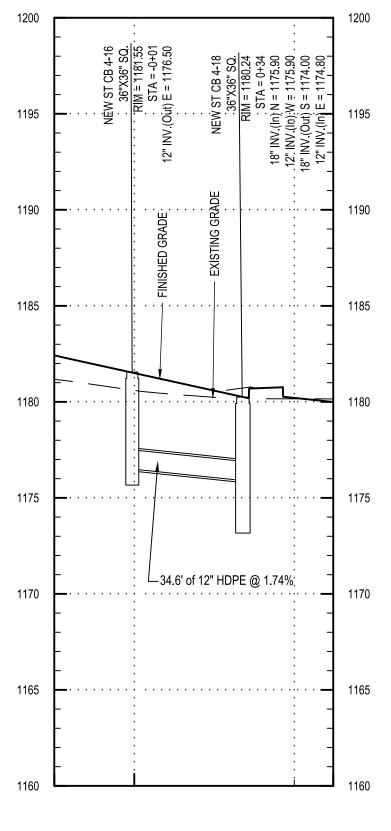
ST MH 4-1 PROFILE



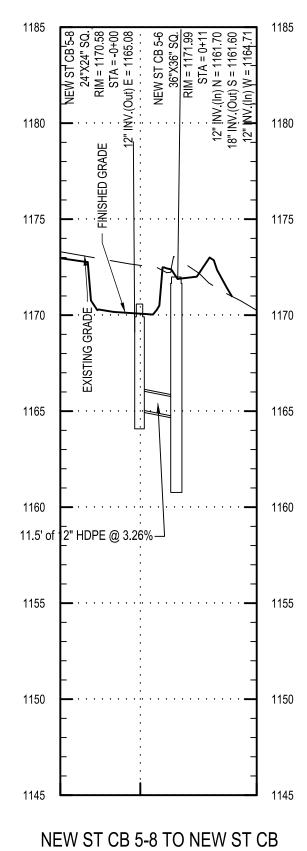


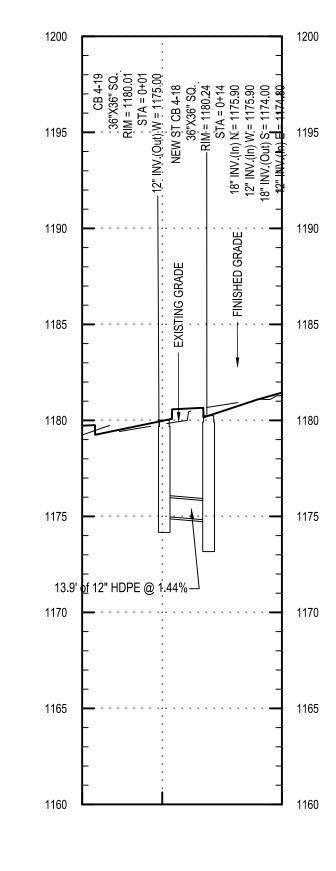




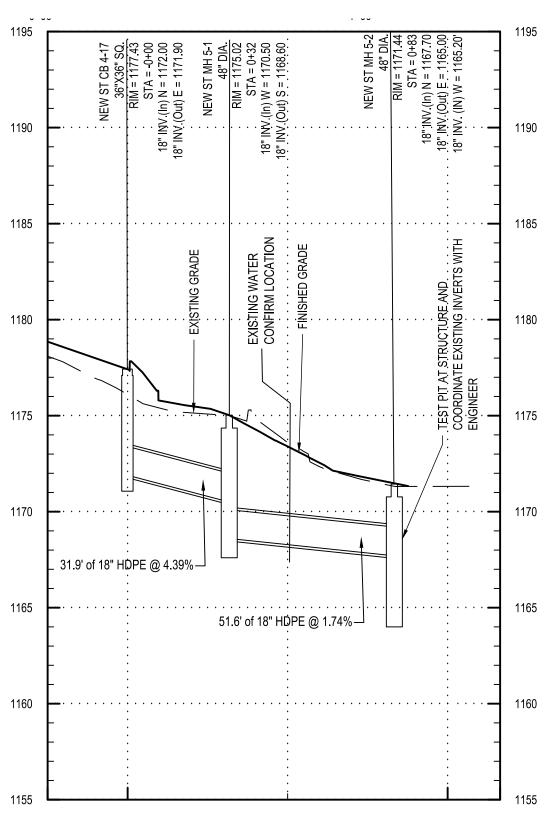


NEW ST CB 4-16 TO NEW ST CB 4-18 PROFILE











NEW ST CB 4-19 TO NEW ST CB 4-18 PROFILE

NEW ST CB 4-17 TO NEW ST MH 5-1 TO NEW ST MH 5-2

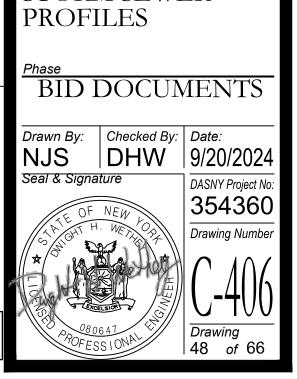
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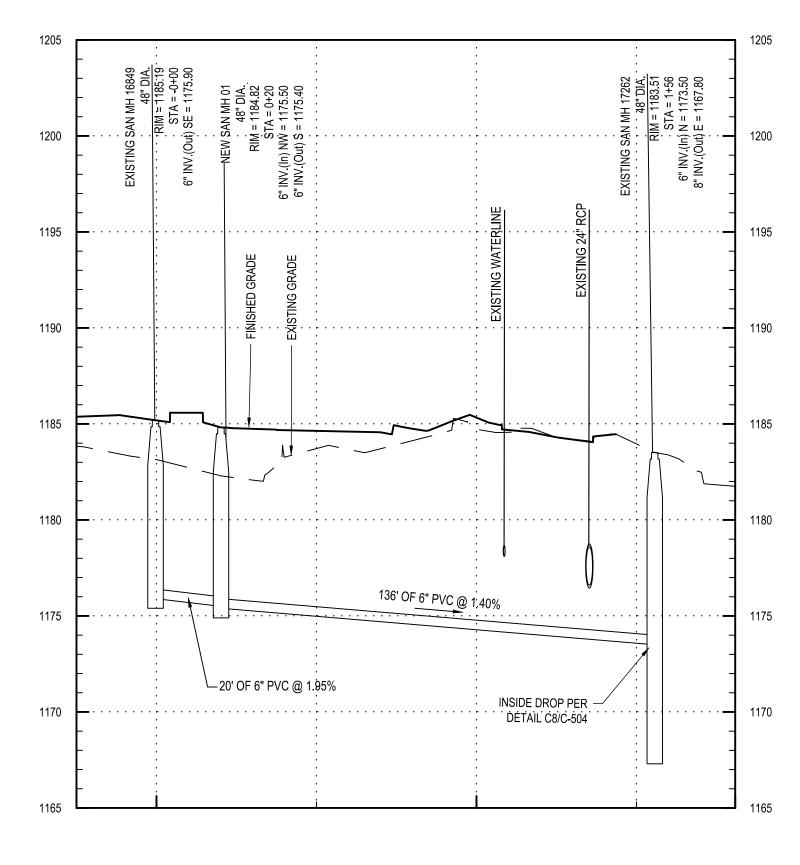
10'

30'

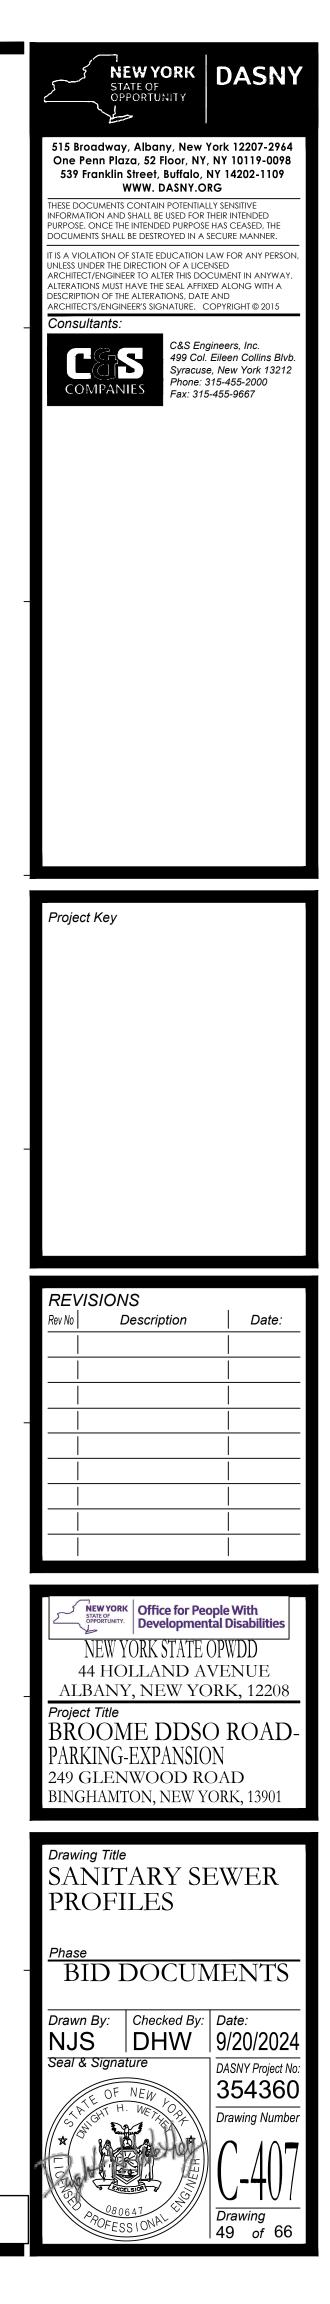
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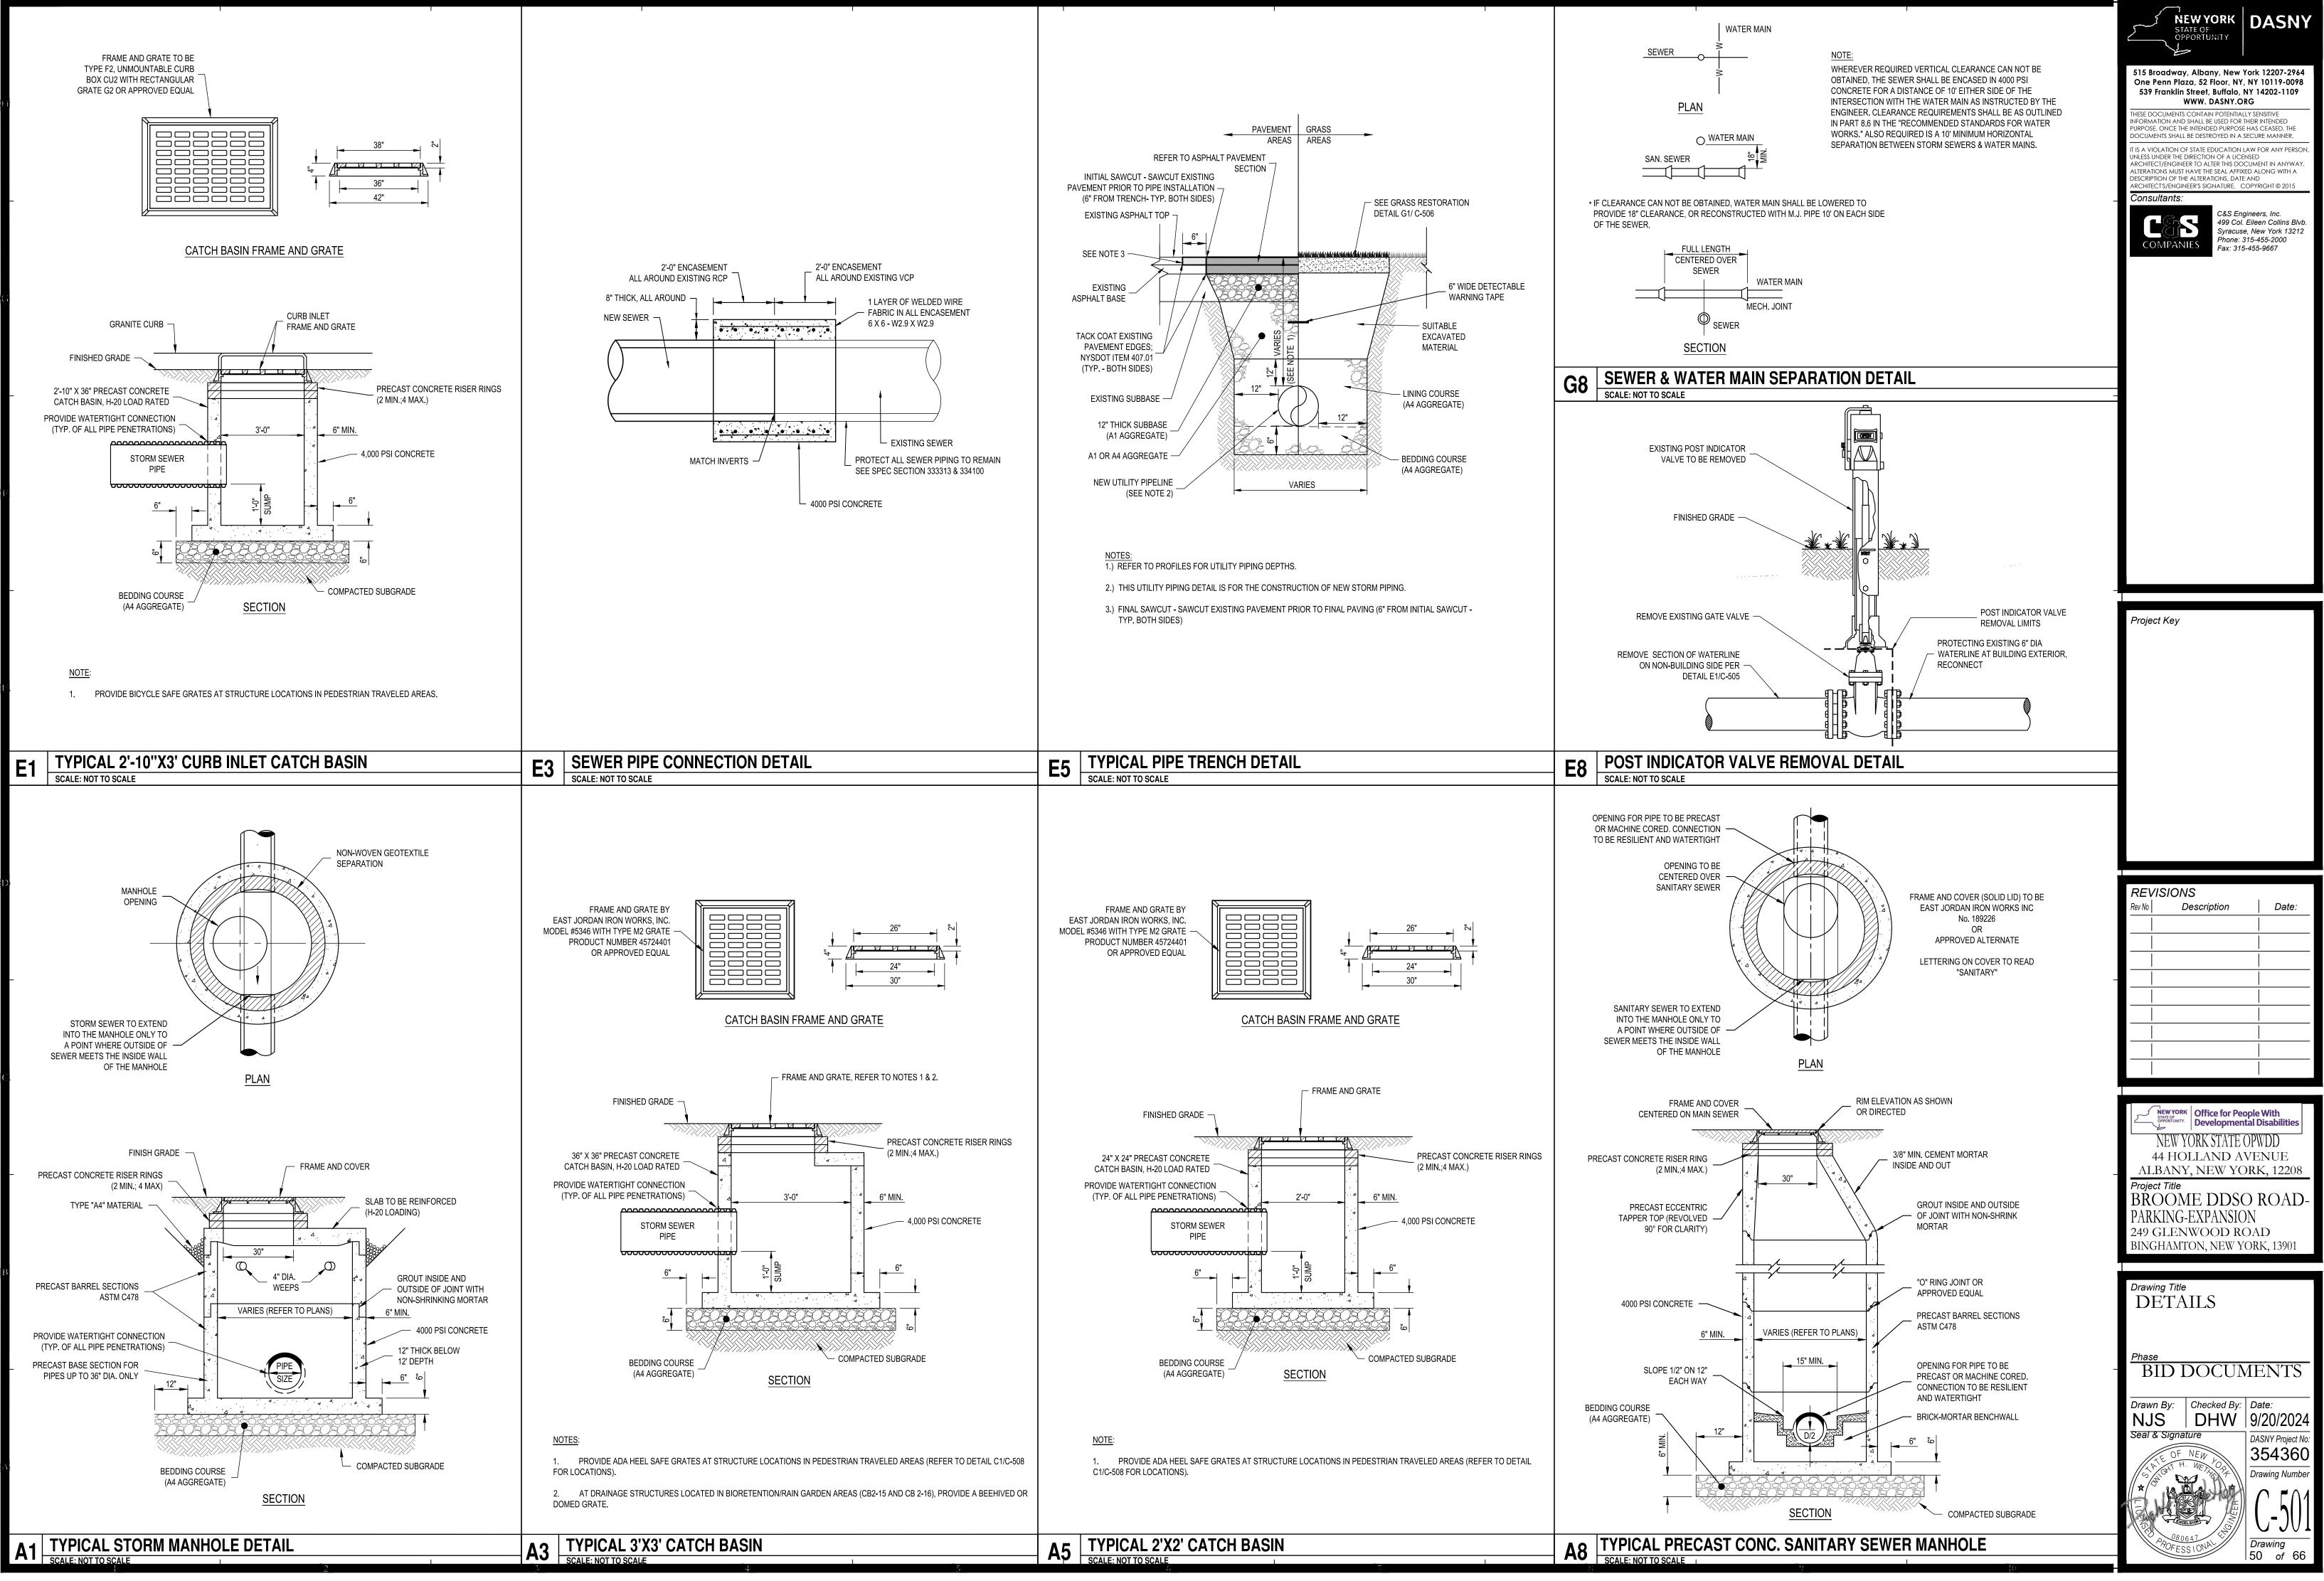


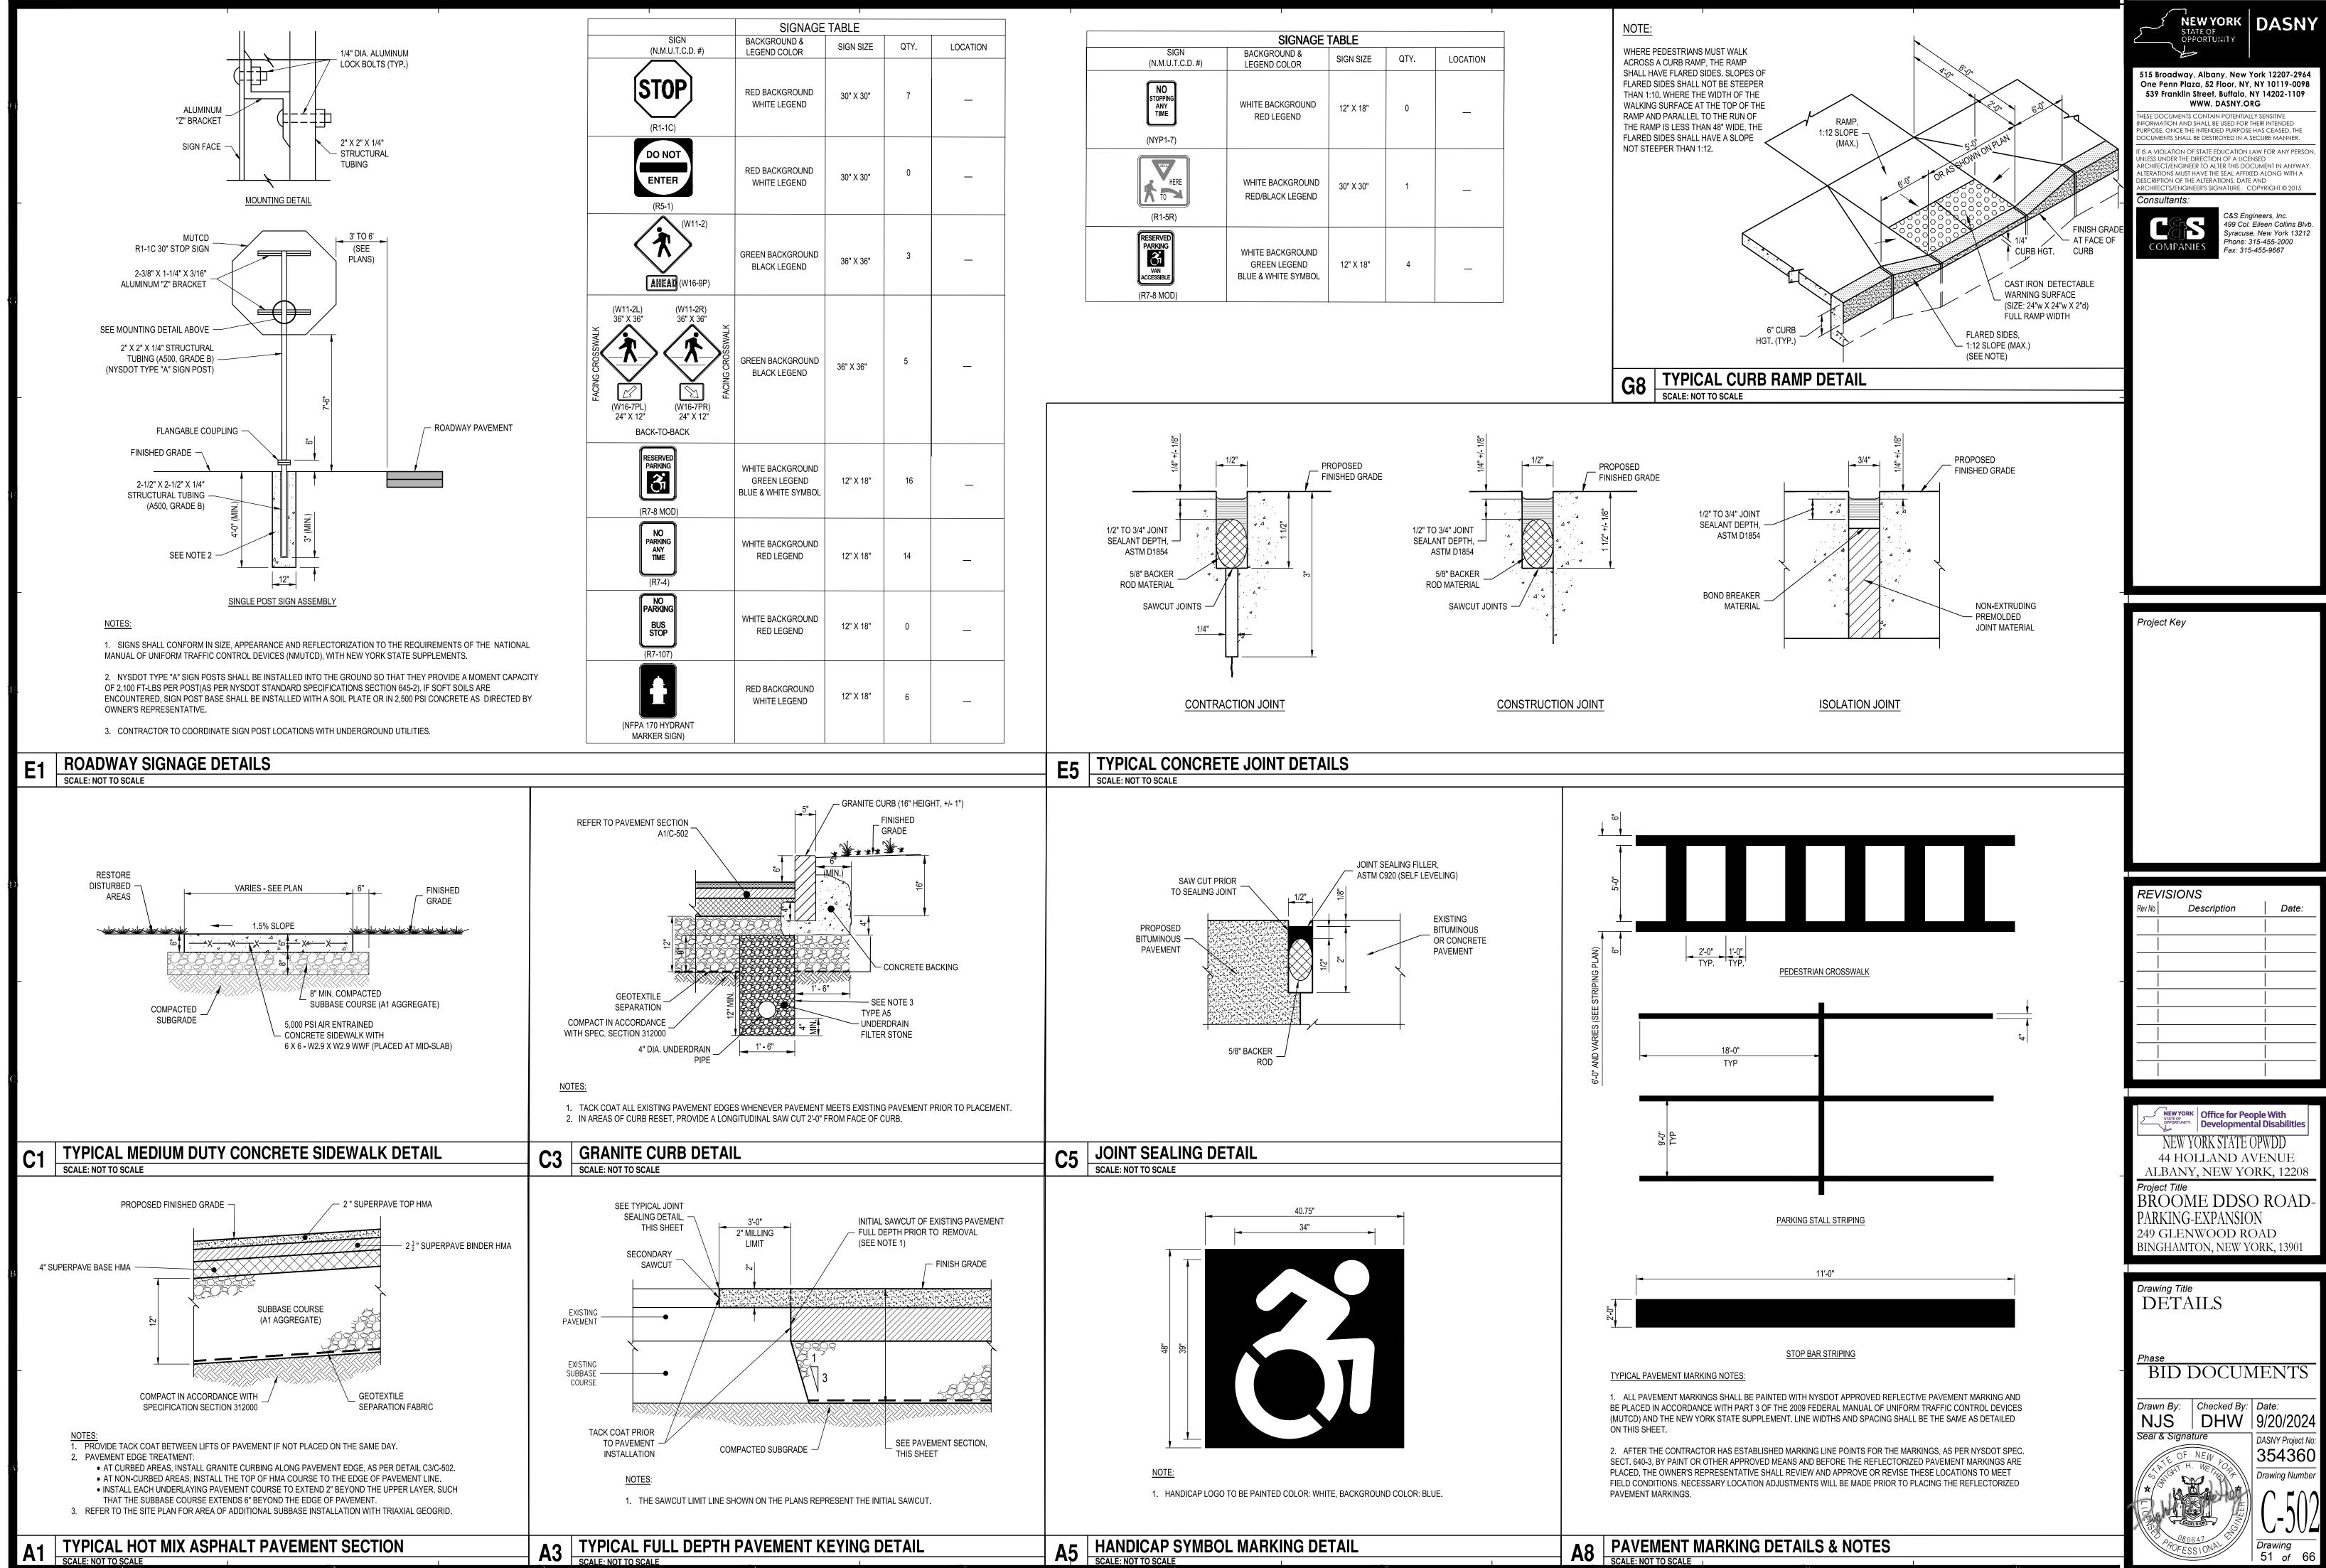


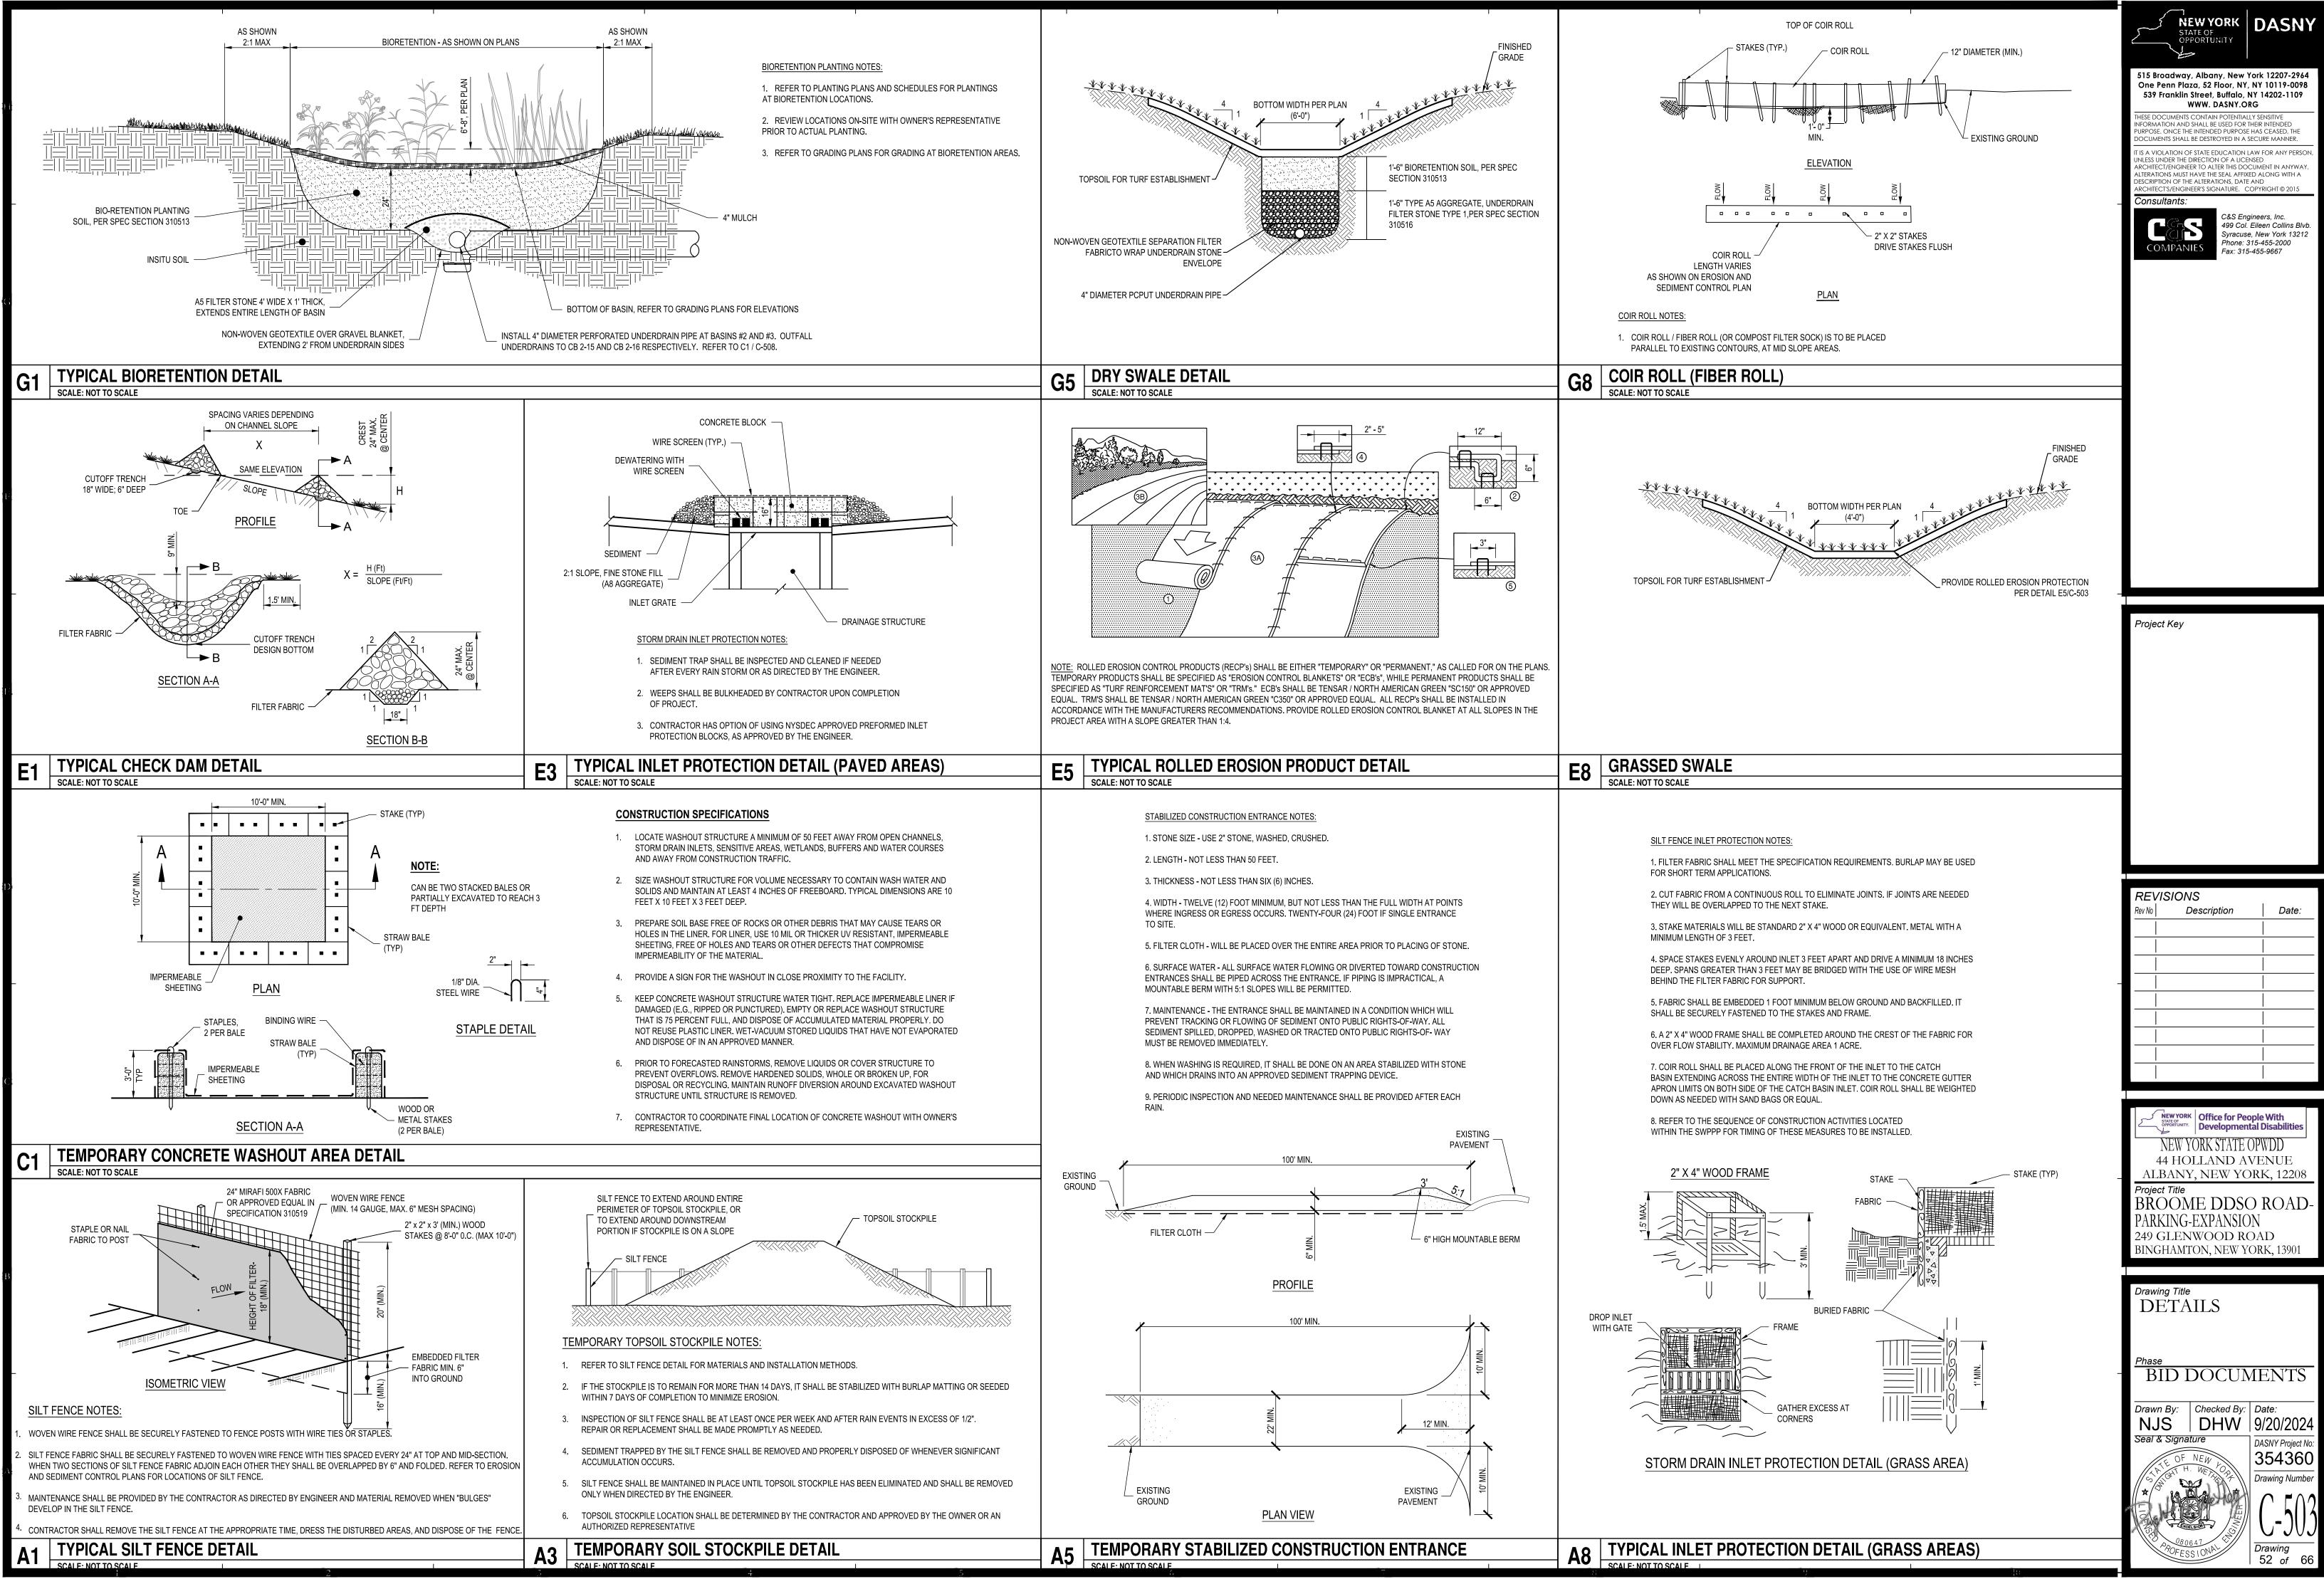
EXISTING SAN MH 16849 TO NEW SAN MH 1 TO EXISTING SAN MH 17262

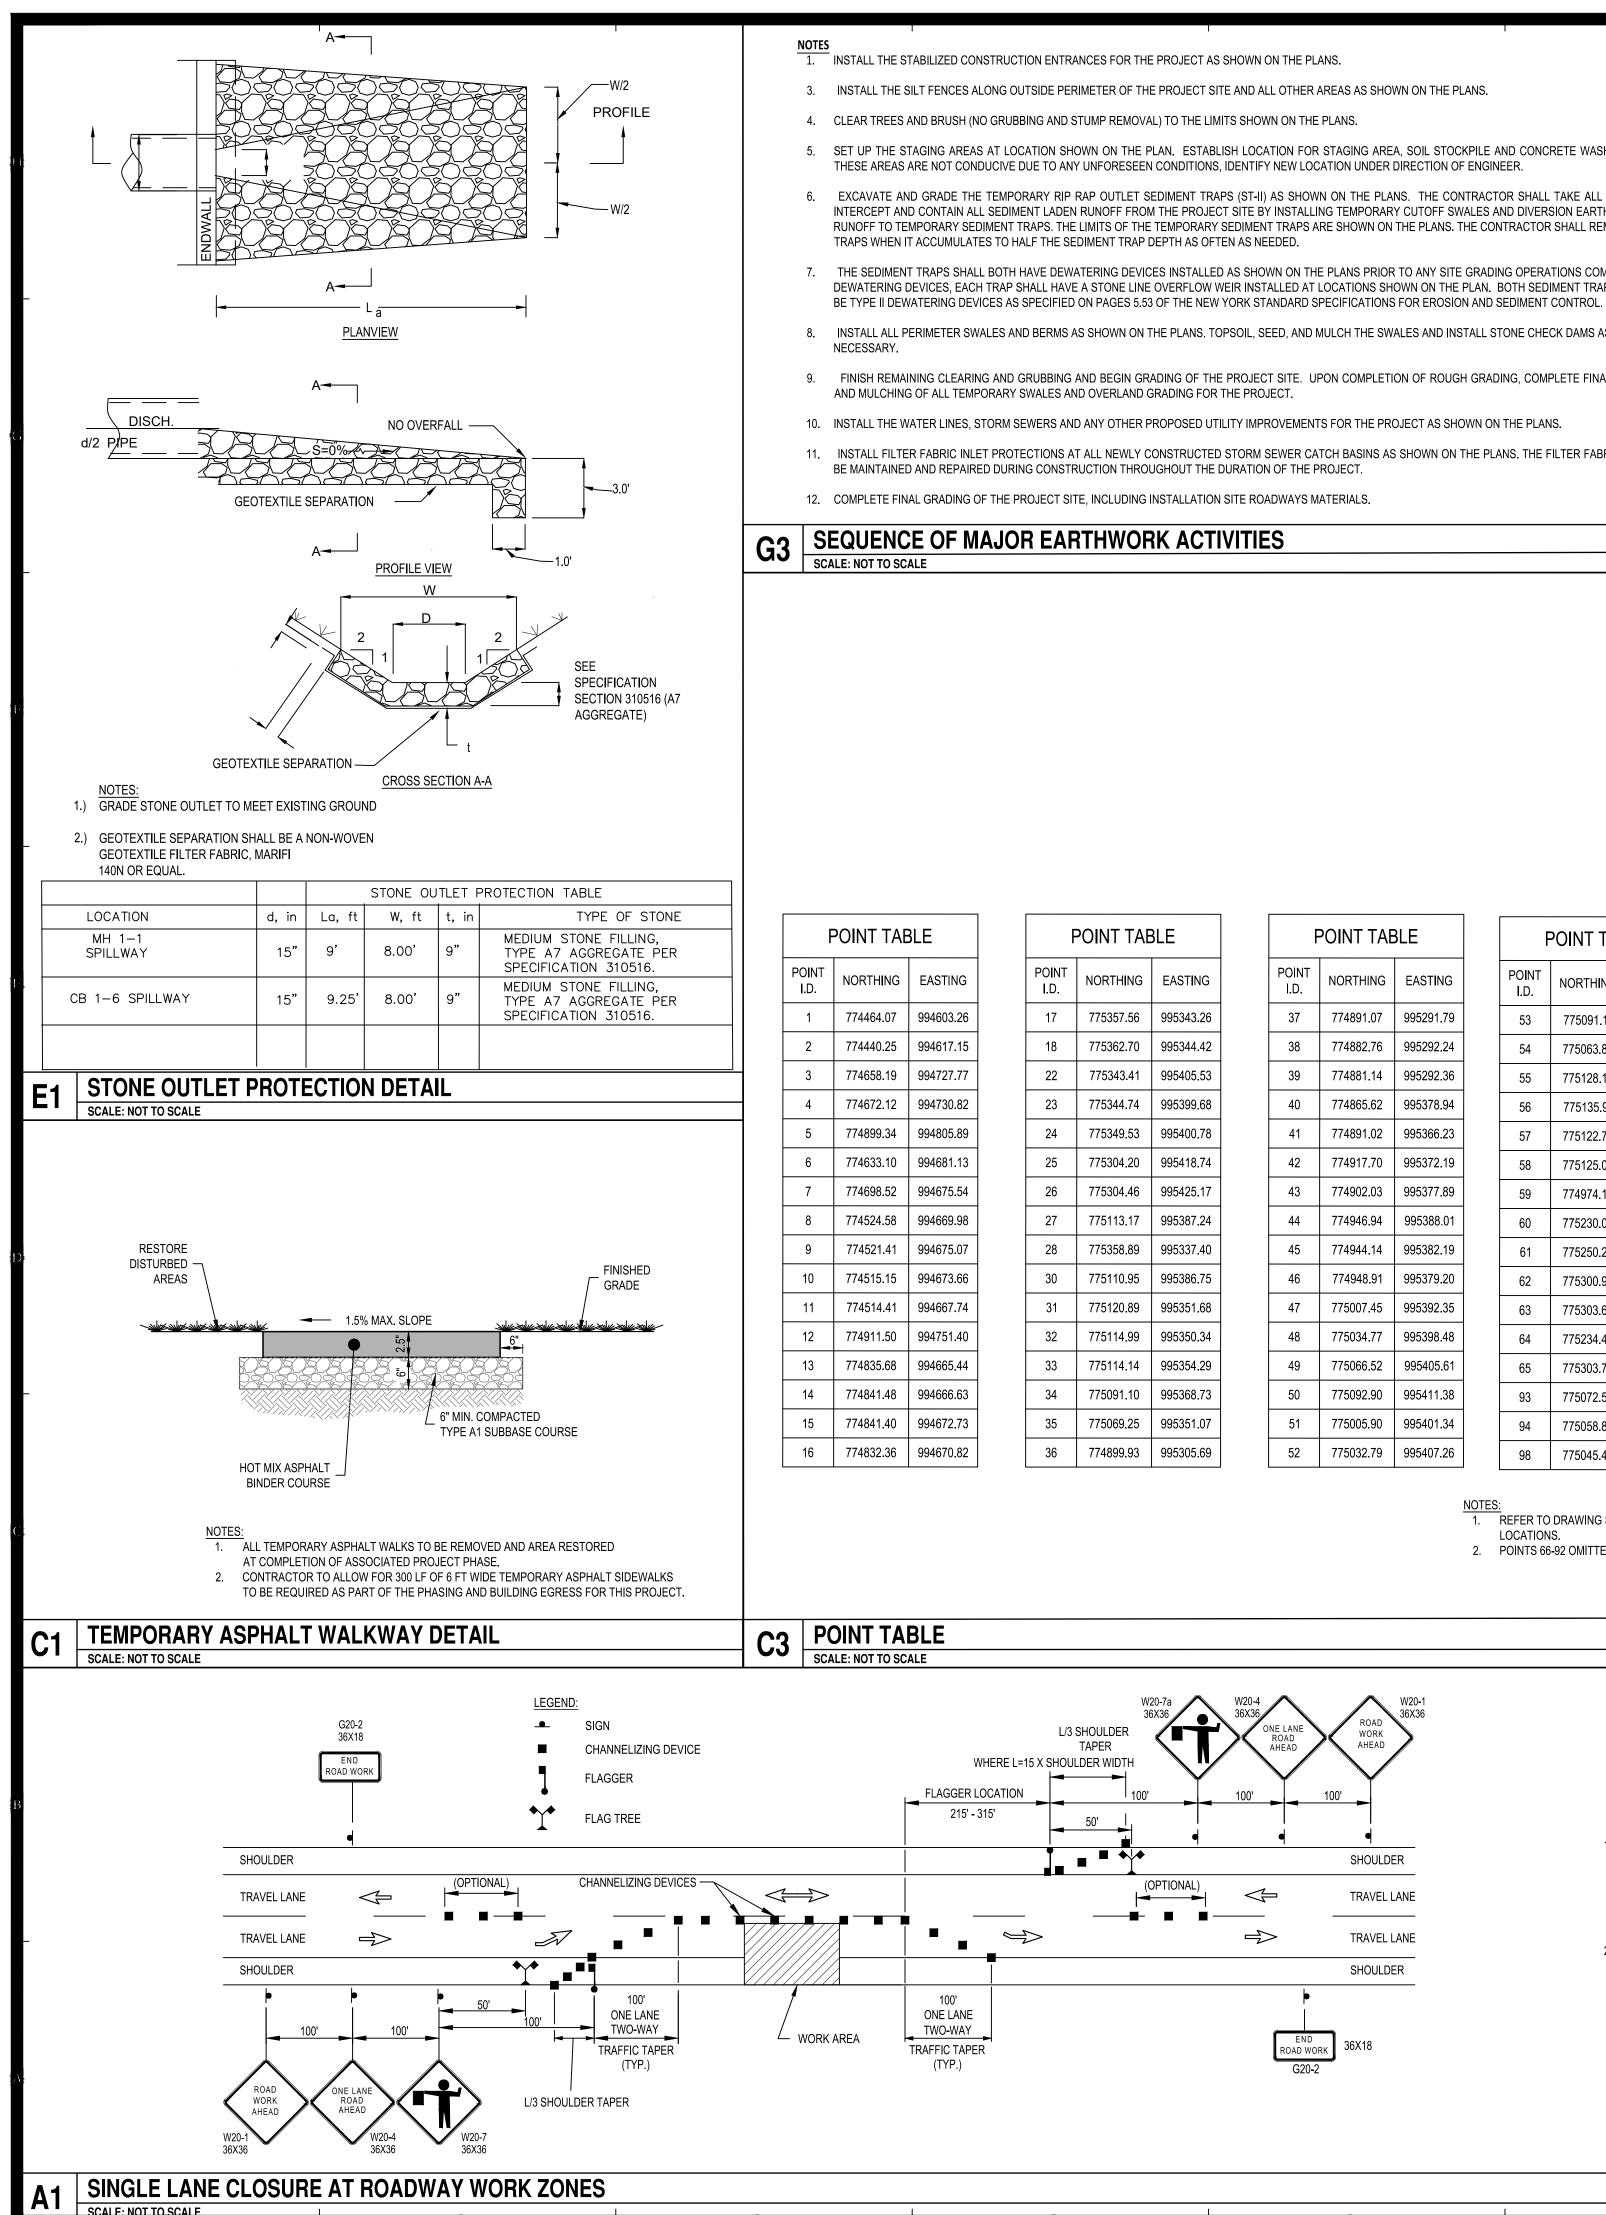


0 30' 60' 0 10' 20'









5. SET UP THE STAGING AREAS AT LOCATION SHOWN ON THE PLAN. ESTABLISH LOCATION FOR STAGING AREA, SOIL STOCKPILE AND CONCRETE WASHOUT AS SHOWN ON PLANS. IF

EXCAVATE AND GRADE THE TEMPORARY RIP RAP OUTLET SEDIMENT TRAPS (ST-II) AS SHOWN ON THE PLANS. THE CONTRACTOR SHALL TAKE ALL PRECAUTIONS NECESSARY TO INTERCEPT AND CONTAIN ALL SEDIMENT LADEN RUNOFF FROM THE PROJECT SITE BY INSTALLING TEMPORARY CUTOFF SWALES AND DIVERSION EARTH DIKES AS NEEDED TO DIRECT RUNOFF TO TEMPORARY SEDIMENT TRAPS. THE LIMITS OF THE TEMPORARY SEDIMENT TRAPS ARE SHOWN ON THE PLANS. THE CONTRACTOR SHALL REMOVE ALL SEDIMENT FROM THE

7. THE SEDIMENT TRAPS SHALL BOTH HAVE DEWATERING DEVICES INSTALLED AS SHOWN ON THE PLANS PRIOR TO ANY SITE GRADING OPERATIONS COMMENCING. IN ADDITION TO THE DEWATERING DEVICES. EACH TRAP SHALL HAVE A STONE LINE OVERFLOW WEIR INSTALLED AT LOCATIONS SHOWN ON THE PLAN. BOTH SEDIMENT TRAP DEWATERING DEVICES SHALL

8. INSTALL ALL PERIMETER SWALES AND BERMS AS SHOWN ON THE PLANS. TOPSOIL, SEED, AND MULCH THE SWALES AND INSTALL STONE CHECK DAMS AS SHOWN ON THE PLANS OR AS

FINISH REMAINING CLEARING AND GRUBBING AND BEGIN GRADING OF THE PROJECT SITE. UPON COMPLETION OF ROUGH GRADING, COMPLETE FINAL GRADING, TOPSOIL, SEEDING

11. INSTALL FILTER FABRIC INLET PROTECTIONS AT ALL NEWLY CONSTRUCTED STORM SEWER CATCH BASINS AS SHOWN ON THE PLANS. THE FILTER FABRIC INLET PROTECTIONS SHALL

- 13. TEMPORARILY SEED AND MULCH INACTIVE ROUGH GRADED AREAS TO ESTABLISH VEGETATION AND PREVENT EROSION.
- 14. INSTALL CONCRETE CURBING AND COMPLETE PAVING OPERATIONS OF ALL PARKING AREAS AND THE SITE ACCESS DRIVEWAY AS SHOWN ON THE PLANS.
- CATCH BASIN INLETS AS SHOWN ON THE DETAIL SHEET. MAINTAIN ALL EROSION AND SEDIMENT CONTROLS FOR THE DURATION OF THE PROJECT.
- SHALL SCARIFY THE BASIN FOOTPRINT PRIOR TO PLACEMENT OF TOPSOIL.
- 17. AS CONSTRUCTION PROGRESSES, MAINTAIN ALL EROSION CONTROL FEATURES ONSITE IN ACCORDANCE WITH THIS SWPPP AND THE CONTRACT DRAWINGS.
- AREAS (RESULTING FROM TEMPORARY EROSION CONTROL MEASURE REMOVAL).
- INSPECTIONS, THE OWNER WILL FILE THE NOTICE OF TERMINATION (NOT) WITH THE NYSDEC.

NORTHING	EASTING
775357.56	995343.26
775362.70	995344.42
775343.41	995405.53
775344.74	995399.68
775349.53	995400.78
775304.20	995418.74
775304.46	995425.17
775113.17	995387.24
775358.89	995337.40
775110.95	995386.75
775120.89	995351.68
775114.99	995350.34
775114.14	995354.29
775091.10	995368.73
775069.25	995351.07
774899.93	995305.69

F	POINT TAE	BLE
POINT I.D.	NORTHING	EASTING
37	774891.07	995291.79
38	774882.76	995292.24
39	774881.14	995292.36
40	774865.62	995378.94
41	774891.02	995366.23
42	774917.70	995372.19
43	774902.03	995377.89
44	774946.94	995388.01
45	774944.14	995382.19
46	774948.91	995379.20
47	775007.45	995392.35
48	775034.77	995398.48
49	775066.52	995405.61
50	775092.90	995411.38
51	775005.90	995401.34
52	775032.79	995407.26

	POINT TAE	BLE
POINT I.D.	NORTHING	EASTING
53	775091.11	995421.22
54	775063.85	995414.86
55	775128.12	995467.22
56	775135.91	995431.69
57	775122.76	995428.62
58	775125.03	995418.61
59	774974.16	995394.36
60	775230.06	995391.88
61	775250.22	995417.19
62	775300.96	995407.09
63	775303.69	995428.87
64	775234.42	995400.62
65	775303.76	995410.05
93	775072.50	995703.39
94	775058.86	995700.20
98	775045.48	995713.50

F	POINT TAE	BLE
POINT I.D.	NORTHING	EASTING
99	775042.10	995727.98
100	774849.29	995682.98
101	774853.90	995663.14
102	774850.86	995658.62
103	774837.23	995655.44
104	774865.87	995532.73
105	775064.52	995535.16
106	775037.25	995528.80
107	775032.45	995531.79
108	775032.02	995533.60
109	775035.01	995538.40
110	775059.77	995544.19
111	775062.27	995544.78
112	775067.50	995539.97
113	775067.08	995541.79
114	775006.09	995521.53

F	POINT TAE	BLE
POINT I.D.	NORTHING	EASTING
115	774978.82	995515.16
116	774974.02	995518.15
117	774973.60	995519.93
118	774976.58	995524.74
119	775003.85	995531.11
120	775008.66	995528.13
121	775009.07	995526.33
122	774947.56	995508.30
123	774920.29	995501.94
124	774915.58	995504.58
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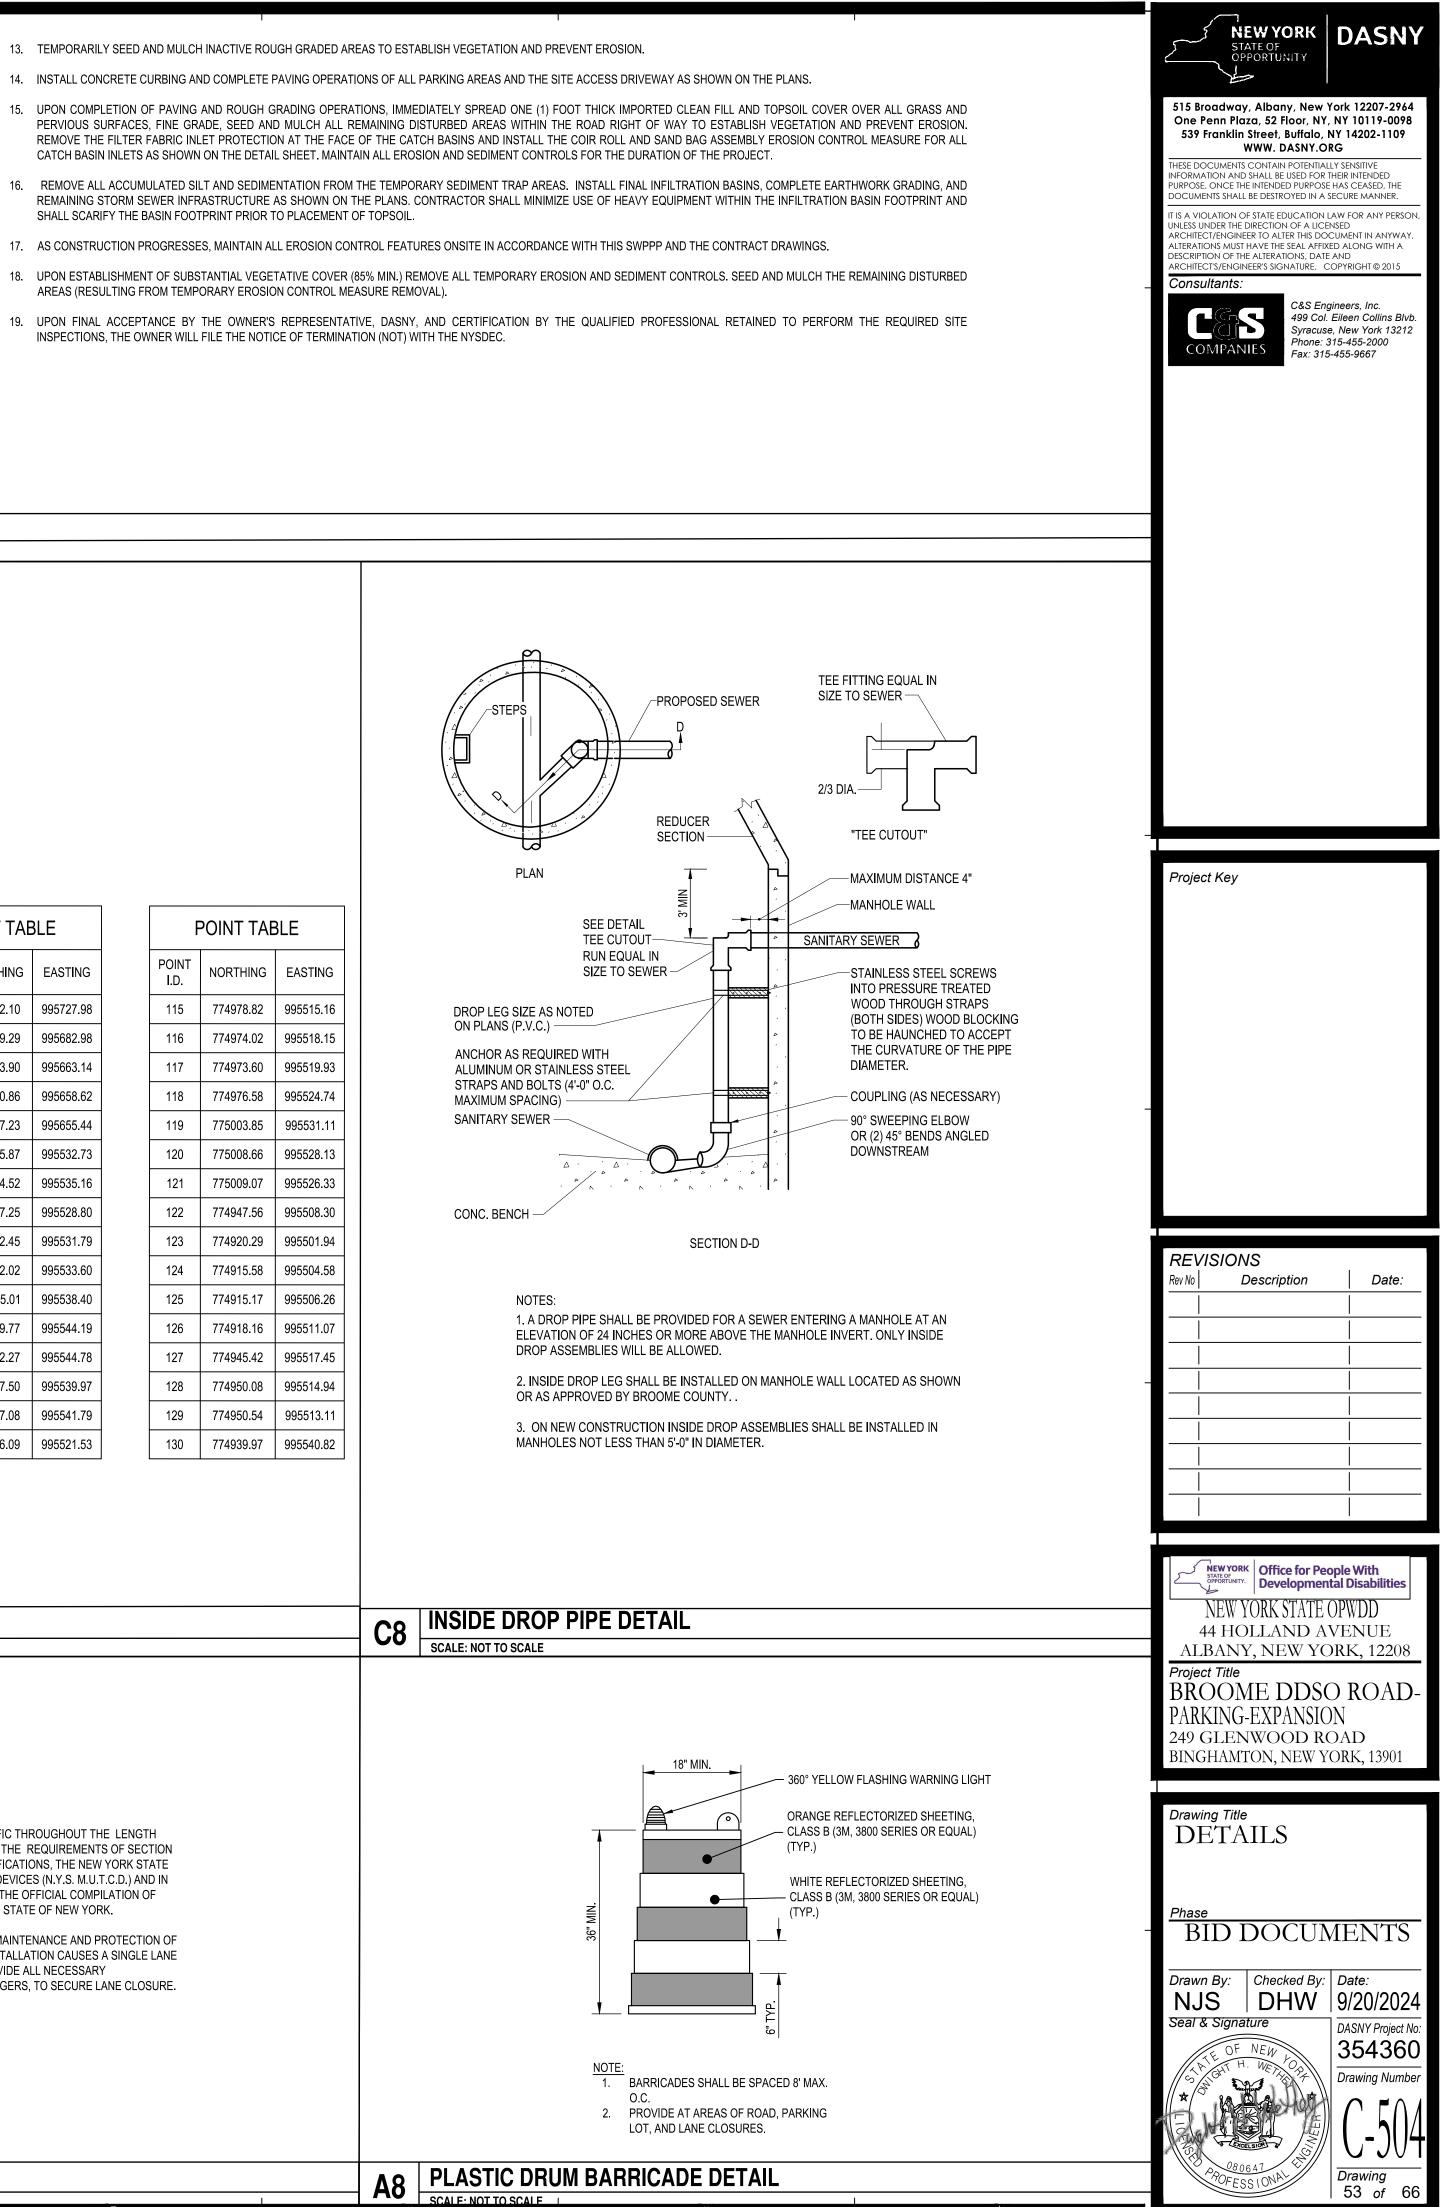
NOTES: REFER TO DRAWING SITE PLAN FOR POINT

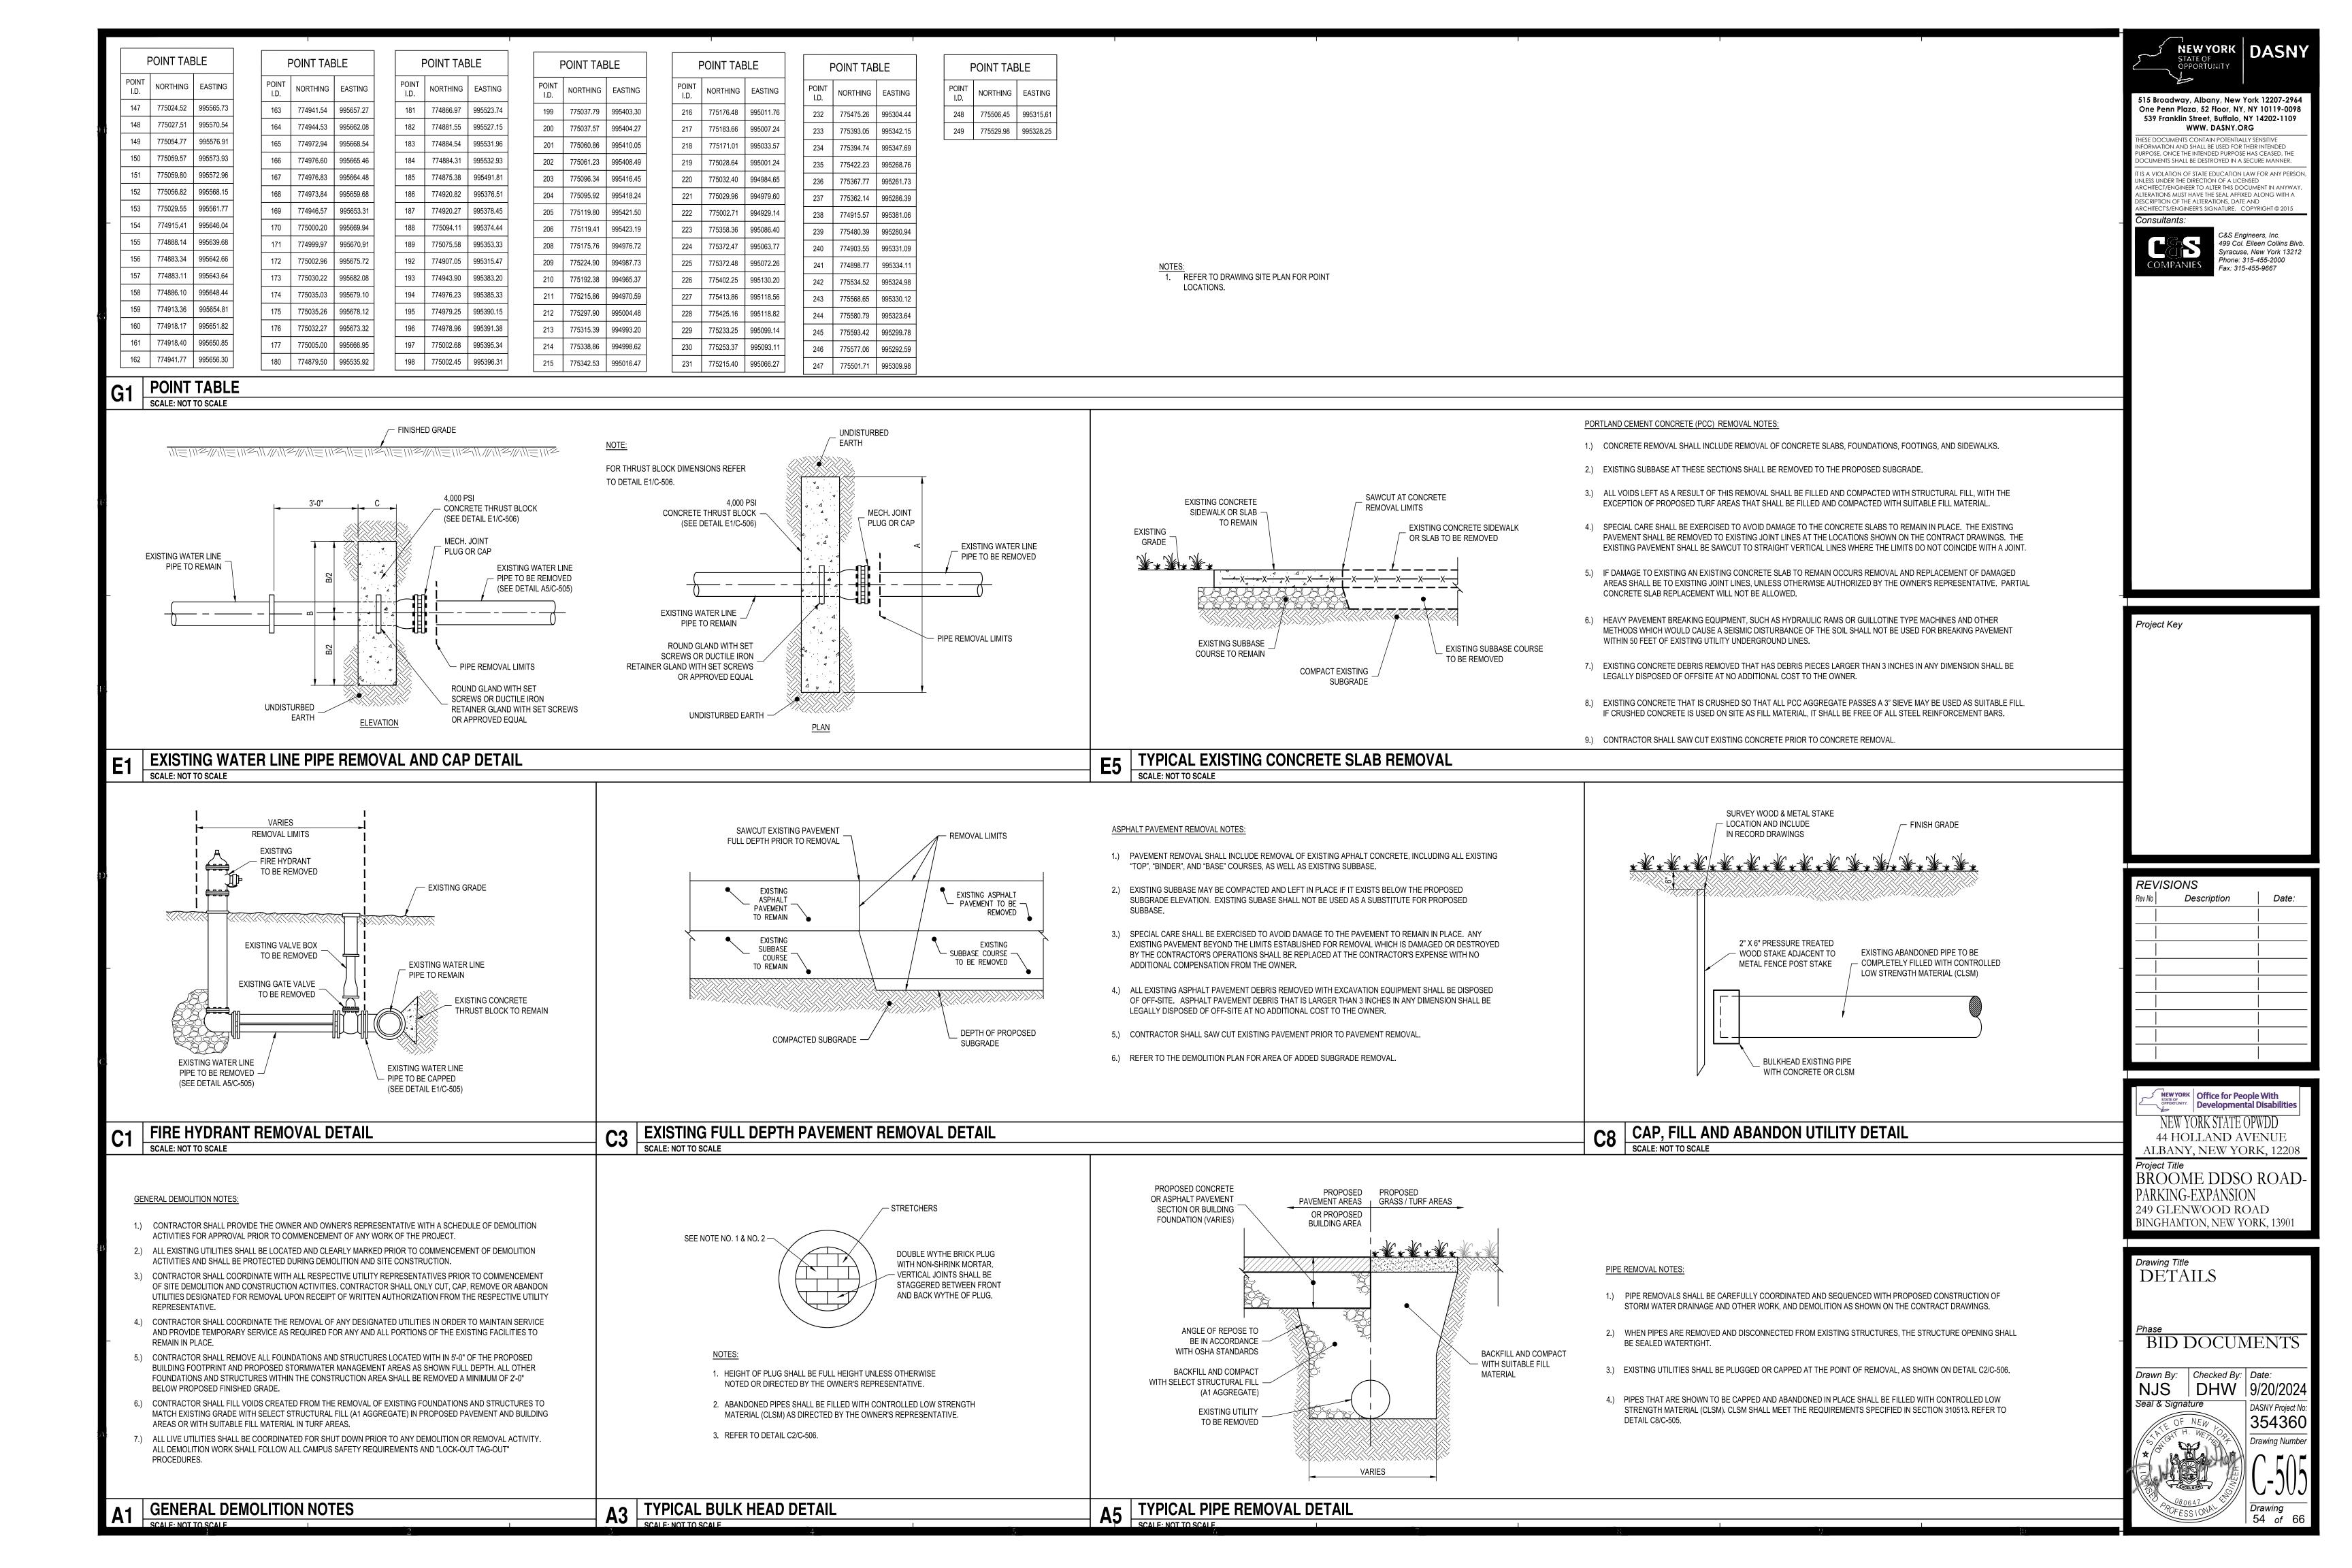
LOCATIONS. 2. POINTS 66-92 OMITTED.

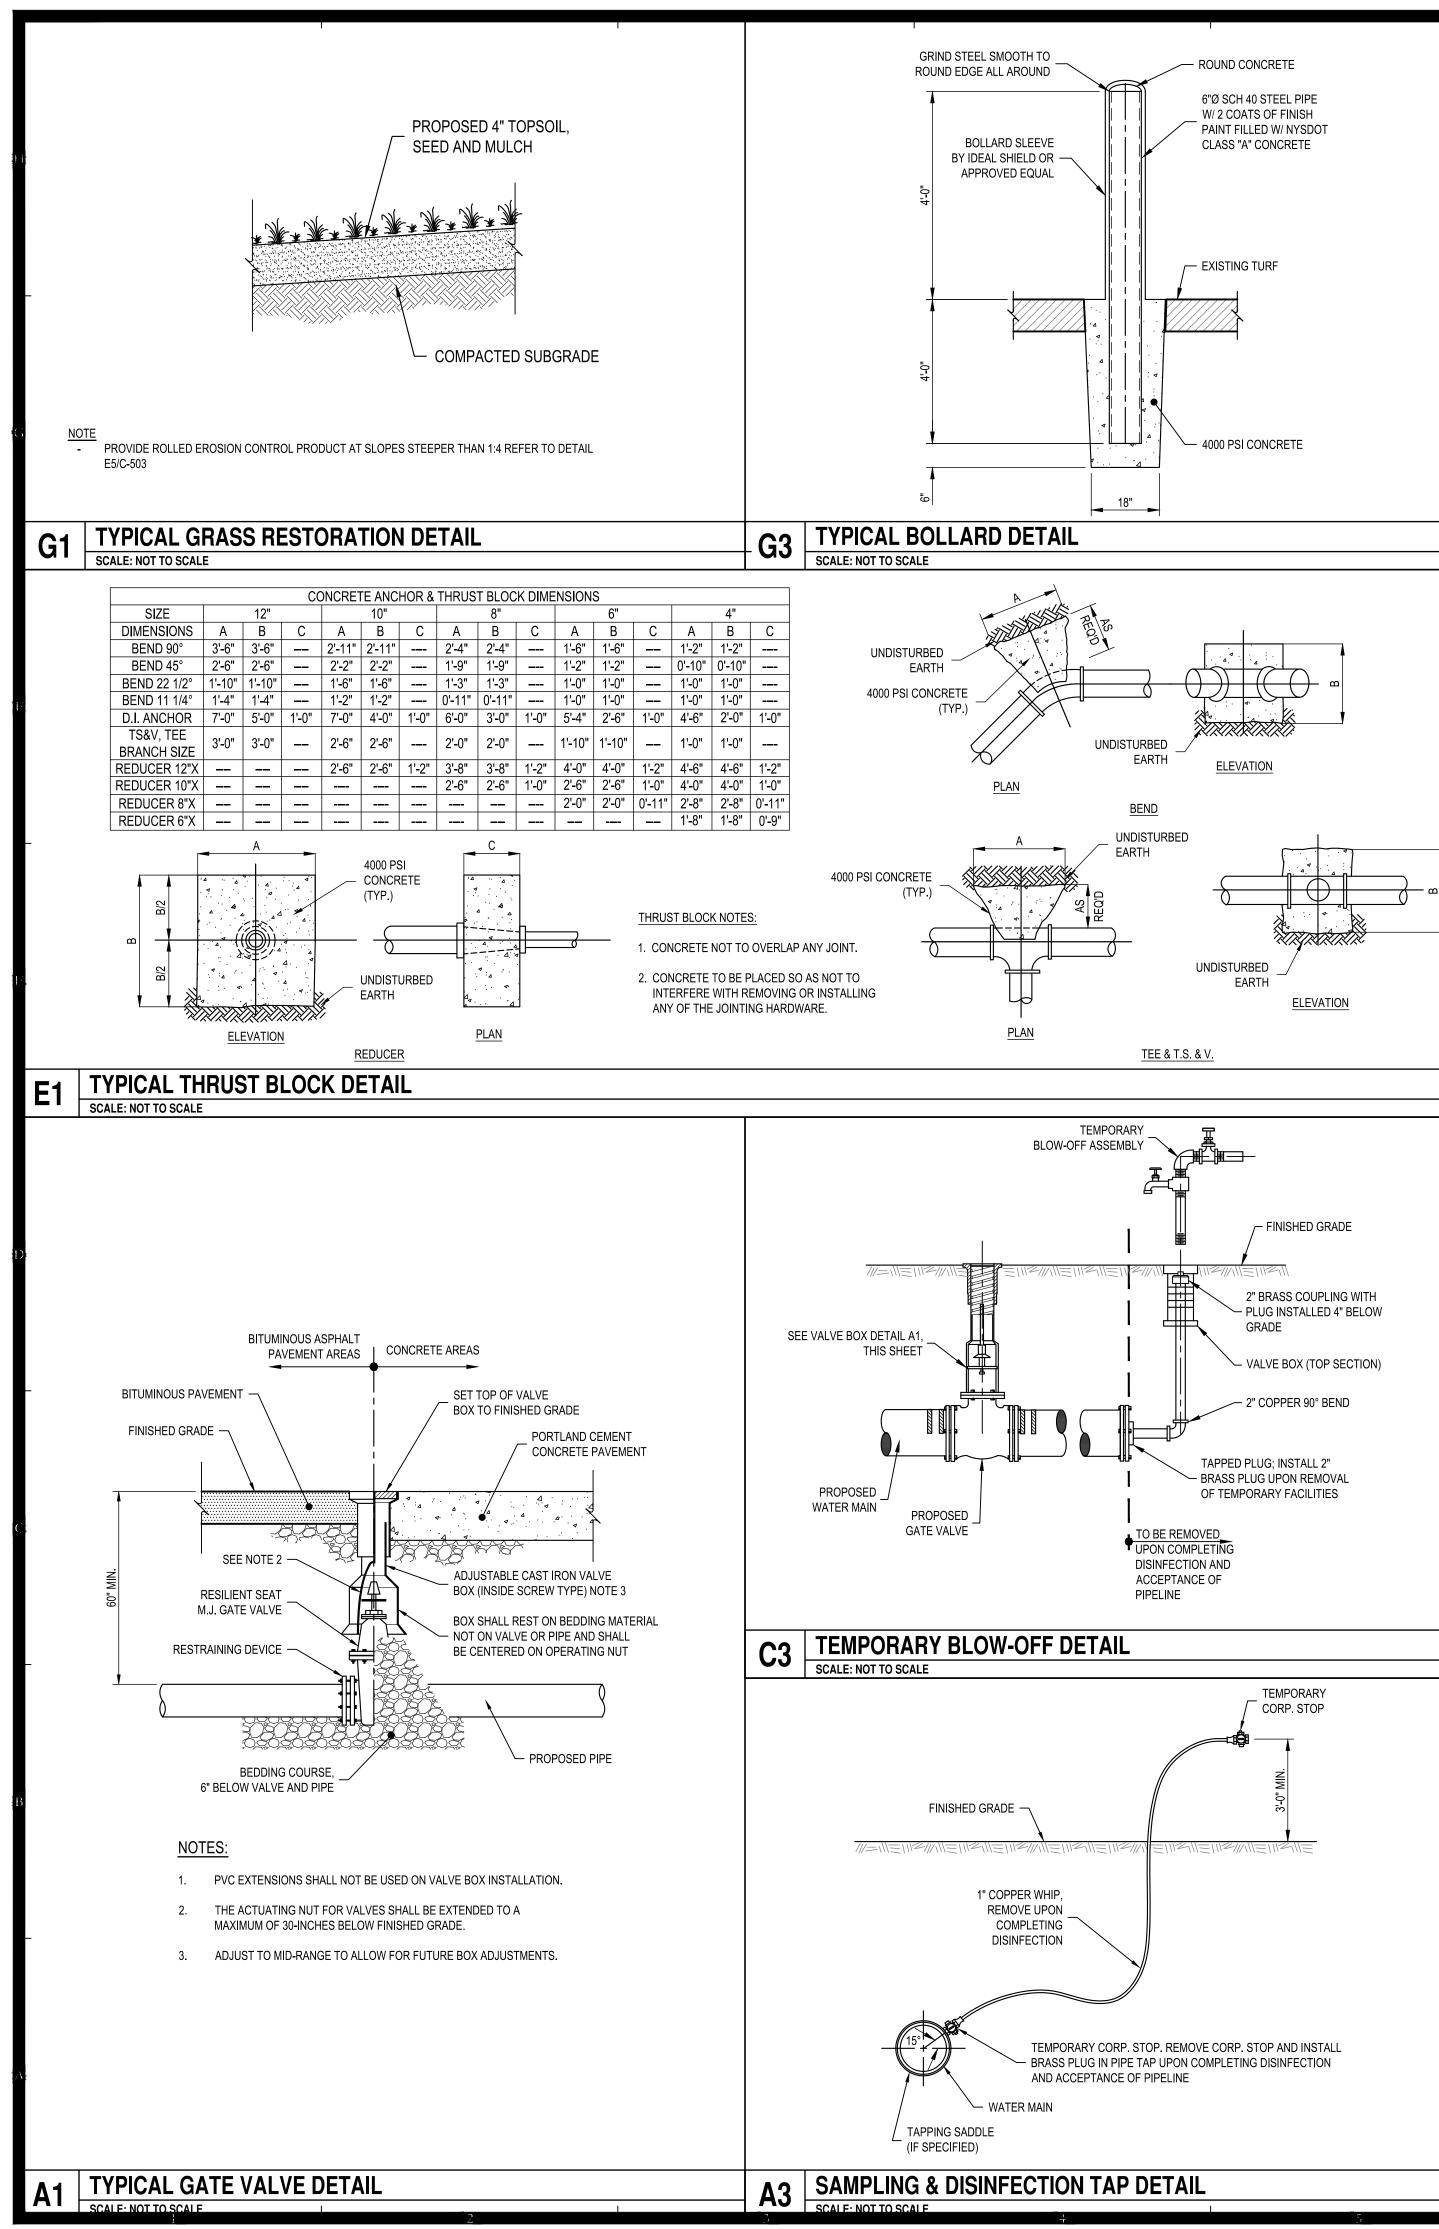
NOTE:

- 1. THE CONTRACTOR SHALL MAINTAIN TRAFFIC THROUGHOUT THE LENGTH OF THE CONTRACT IN ACCORDANCE WITH THE REQUIREMENTS OF SECTION 619 OF THE N.Y.S.D.O.T. STANDARD SPECIFICATIONS, THE NEW YORK STATE MANUAL OF UNIFORM TRAFFIC CONTROL DEVICES (N.Y.S. M.U.T.C.D.) AND IN ACCORDANCE TO TITLE 17 CHAPTER 5 OF THE OFFICIAL COMPILATION OF CODES, RULES AND REGULATIONS OF THE STATE OF NEW YORK.
- 2. THE CONTRACTOR IS RESPONSIBLE FOR MAINTENANCE AND PROTECTION OF TRAFFIC AT ALL TIMES. IF AT ANY TIME INSTALLATION CAUSES A SINGLE LANE SHUTDOWN, THE CONTRACTOR WILL PROVIDE ALL NECESSARY MEANS PER THIS DETAIL, INCLUDING FLAGGERS, TO SECURE LANE CLOSURE.

C8







ALL GRADING WITHIN CRZ AREAS SHALL BE DONE BY HAND OR WITH SMALL EQUIPMENT TO MINIMIZE ROOT DAMAGE. PRIOR TO GRADING, RELOCATE PROTECTIVE FENCING TO 2 FEET BEHIND THE GRADE CHANGE AREA. ANY ROOTS EXPOSED BY CONSTRUCTION ACTIVITY SHALL BE PRUNED FLUSH WITH THE SOIL AND BACKFILLED WITHIN TWO DAYS. IF EXPOSED ROOT AREAS CANNOT BE BACKFILLED WITHIN 2 DAYS. AN ORGANIC MATERIAL WHICH REDUCES SOIL TEMPERATURE AND MINIMIZES WATER LOSS DUE TO EVAPORATION SHALL BE PLACED TO COVER THE ROOTS UNTIL BACKFILL CAN OCCUR. PRIOR TO EXCAVATION OR GRADE CUTTING WITHIN TREE DRIPLINES, A CLEAN CUT SHALL BE MADE WITH A ROCK SAW OR SIMILAR EQUIPMENT. 10. TREES MOST HEAVILY IMPACTED BY CONSTRUCTION ACTIVITIES WILL BE WATERED DEEPLY ONCE A WEEK DURING PERIODS OF HOT, DRY WEATHER. TREE CROWNS ARE TO BE SPRAYED WITH WATER PERIODICALLY TO REDUCE DUST ACCUMULATION ON LEAVES. 11. WHEN INSTALLING CONCRETE ADJACENT TO THE ROOT ZONE OF A TREE, A PLASTIC VAPOR BARRIER SHALL BE PLACED BEHIND THE CONCRETE TO PROHIBIT LEACHING OF LIME INTO THE CRZ. 12. PRUNING TO PROVIDE CLEARANCE FOR STRUCTURES, VEHICULAR TRAFFIC, AND CONSTRUCTION EQUIPMENT SHALL TAKE PLACE BEFORE CONSTRUCTION 13. FENCES SHALL COMPLETELY SURROUND THE TREE OR CLUSTERS OF TREES, LOCATED AT THE OUTERMOST LIMITS OF THE TREE BRANCHES (DRIPLINE) OR CRITICAL ROOT ZONE (CRZ), WHICHEVER IS GREATER; AND SHALL BE MAINTAINED THROUGHOUT THE CONSTRUCTION PROJECT IN ORDER TO PREVENT THE FOLLOWING: A) SOIL COMPACTION IN CRZ AREA RESULTING FROM VEHICULAR TRAFFIC OR STORAGE OF EQUIPMENT OR MATERIAL. B) CRZ DISTURBANCES DUE TO GRADE CHANGES OR TRENCHING C) WOUNDS TO EXPOSED ROOTS, TRUNK, OR LIMBS BY MECHANICAL EQUIPMENT D) OTHER ACTIVITIES DETRIMENTAL TO TREES SUCH AS CHEMICAL STORAGE, CONCRETE TRUCK CLEANING AND FIRES. 14. NO TOPSOIL DRESSING GREATER THAN FOUR (4) INCHES SHALL BE PERMITTED WITHIN THE DRIPLINE OR CRZ OF TREES, WHICHEVER IS GREATER. NO TOPSOIL IS PERMITTED ON ROOT FLARES OF ANY TREE

FINISHED GRADE

3'-0'

ELEVATION

VARIES

NOTE: HYDRANT TO HAVE

BREAK AWAY TOP

6"Ø CONNECTING

3/4" TIE RODS

W/ DUC LUGS

NOTE 1)

ON EACH SIDE

OR EQUAL (SEE

PIECE DUCTILE -

IRON TH. C52

M.J.

RETAINER -

GLAND

M.J. SWIVEL TEE

RESTRAINED

— NEW PIPE

SLEEVE

M.J. TAPPING

RESTRAINED

MECHANICAL JOINT

A4 TAPPING SLEEVE AND VALVE DETAIL

MECHANICAL JOINT

PLAN

SECTION A - A

1.) CONTRACTOR HAS OPTION TO USE FULLY RESTRAINED JOINTS IN LIEU OF TIE RODS.

' EXISTING

PIPE

RESILIENT SEAT

TAPPING GATE

VALVE W/ VALVE BOX

E5 DUCTILE IRON PIPE ANCHOR AND PLUG DETAIL

∽∎∄⊾

NOTE

1.

4000 PSI

(TYP.)

- CONCRETE

MECH. JOINT

PLUG OR CAP

ROUND GLAND WITH SET

SCREWS MANUFACTURED

BY J.B. CLOW & SONS OR

DUCTILE IRON RETAINER

GLAND WITH SET SCREWS

MANUFACTURED BY

OR APPROVED EQUAL

UNDISTURBED

EARTH

- FINISHED GRADE

/ 6" M.J. GATE VALVE

BASE OF HYDRANT TO BEAR ONTO A 12"X12"X4" THICK CONCRETE SLAB (4,000 PSI)

- ADJUSTABLE VALVE BOX

4000 PSI CONCRETE

- UNDISTURBED EARTH

THRUST BLOCK

U.S. PIPE & FOUNDRY CO

REDUCED FENCING PROVIDED. WHERE ANY OF THE ABOVE EXCEPTIONS RESULT IN AREAS OF UNPROTECTED ROOT ZONES UNDER THE DRIPLINE OR CRZ, WHICHEVER IS GREATER, THOSE AREAS SHOULD BE COVERED WITH 4 INCHES OF ORGANIC MULCH TO MINIMIZE SOIL COMPACTION.

WHERE ANY OF THE ABOVE EXCEPTIONS RESULT IN A FENCE THAT IS CLOSER THAN 5 FEET TO A TREE TRUNK, THE TRUNK SHALL BE PROTECTED BY STRAPPED-ON PLANKING TO A HEIGHT OF 8 FEET (OR TO THE LIMITS OF LOWER BRANCHING) IN ADDITION TO THE

B) WHERE PERMEABLE PAVING IS TO BE INSTALLED, ERECT THE FENCE AT THE OUTER LIMITS OF THE PERMEABLE PAVING AREA. C) WHERE TREES ARE CLOSE TO PROPOSED BUILDINGS, ERECT THE FENCE NO CLOSER THAN 6 FEET TO THE BUILDING.

A) WHERE THERE IS TO BE AN APPROVED GRADE CHANGE, IMPERMEABLE PAVING SURFACE, OR TREE WELL:

EXCEPTIONS TO INSTALLING TREE FENCES AT THE TREE DRIPLINES OR CRZ, WHICHEVER IS GREATER, MAY BE PERMITTED IN THE FOLLOWING CASES:

TREE PROTECTION NOTES

G5 TREE PROTECTION NOTES

SCALE: NOT TO SCALE

GATE VALVE -

SCALE: NOT TO SCALE

MUELLER SUPER -

EQUAL

CENTURION 250 FIRE

HYDRANT OR APPROVED

4000 PSI CONCRETE

C5

THRUST BLOCK

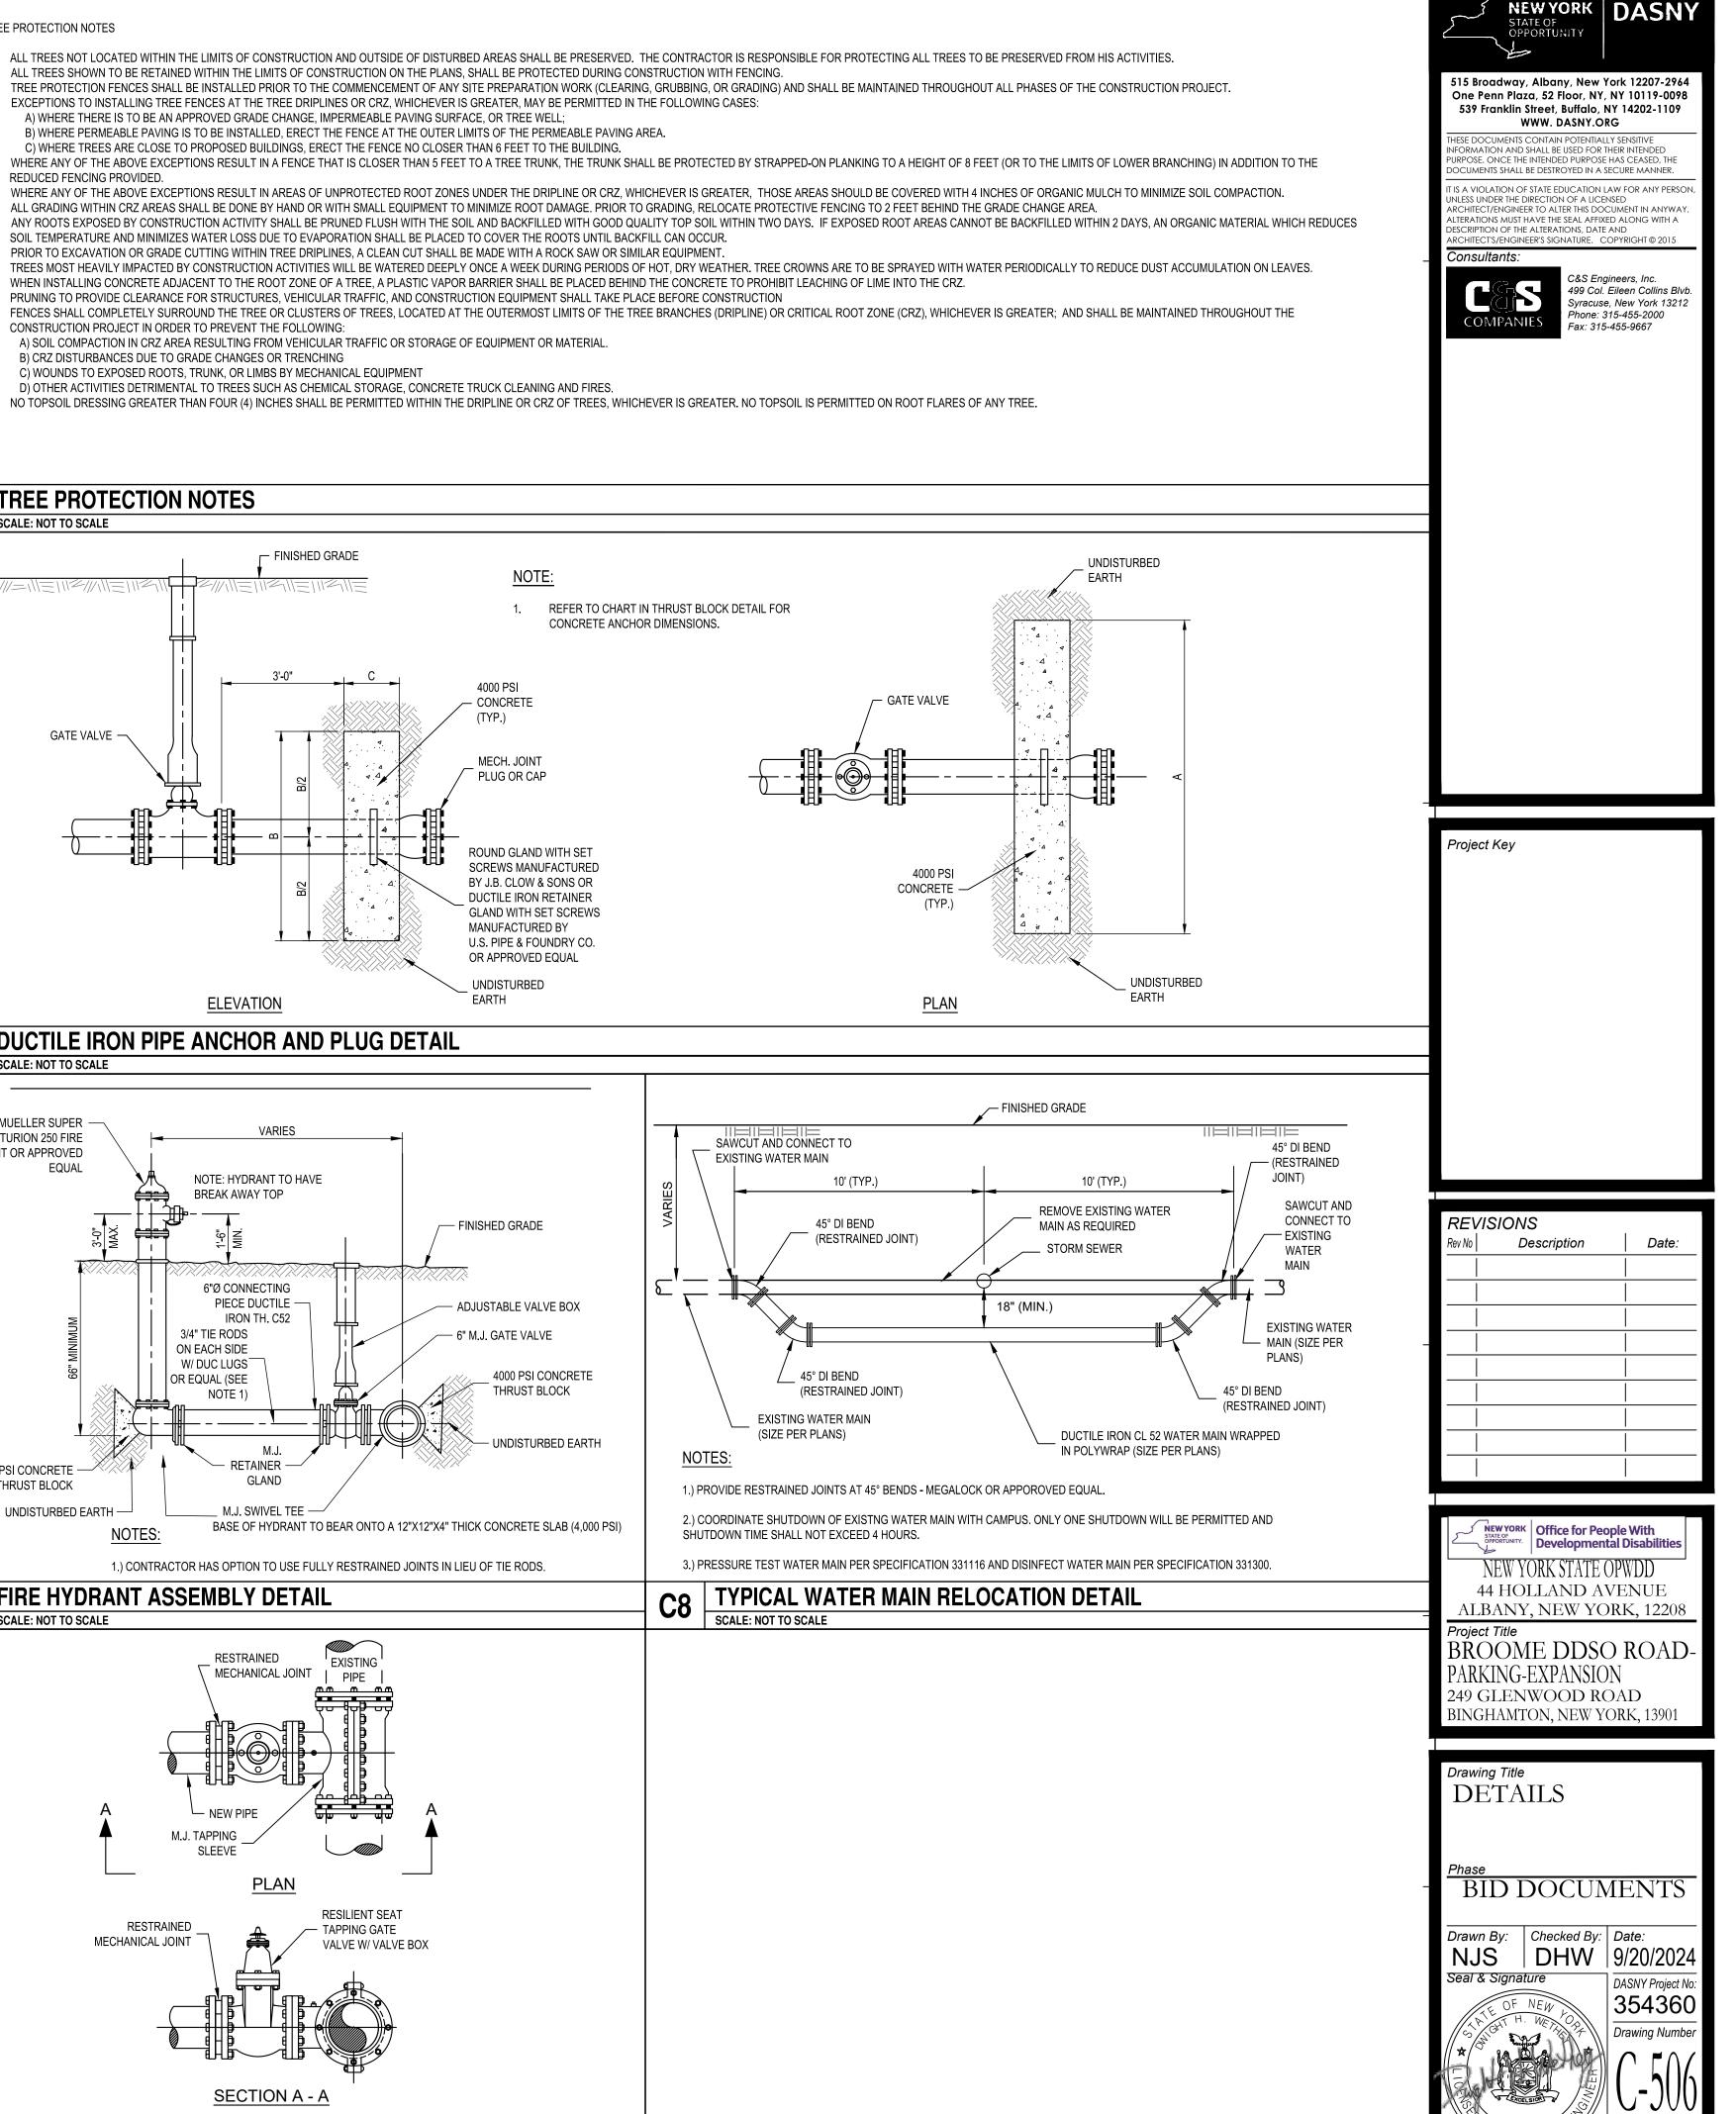
UNDISTURBED EARTH -

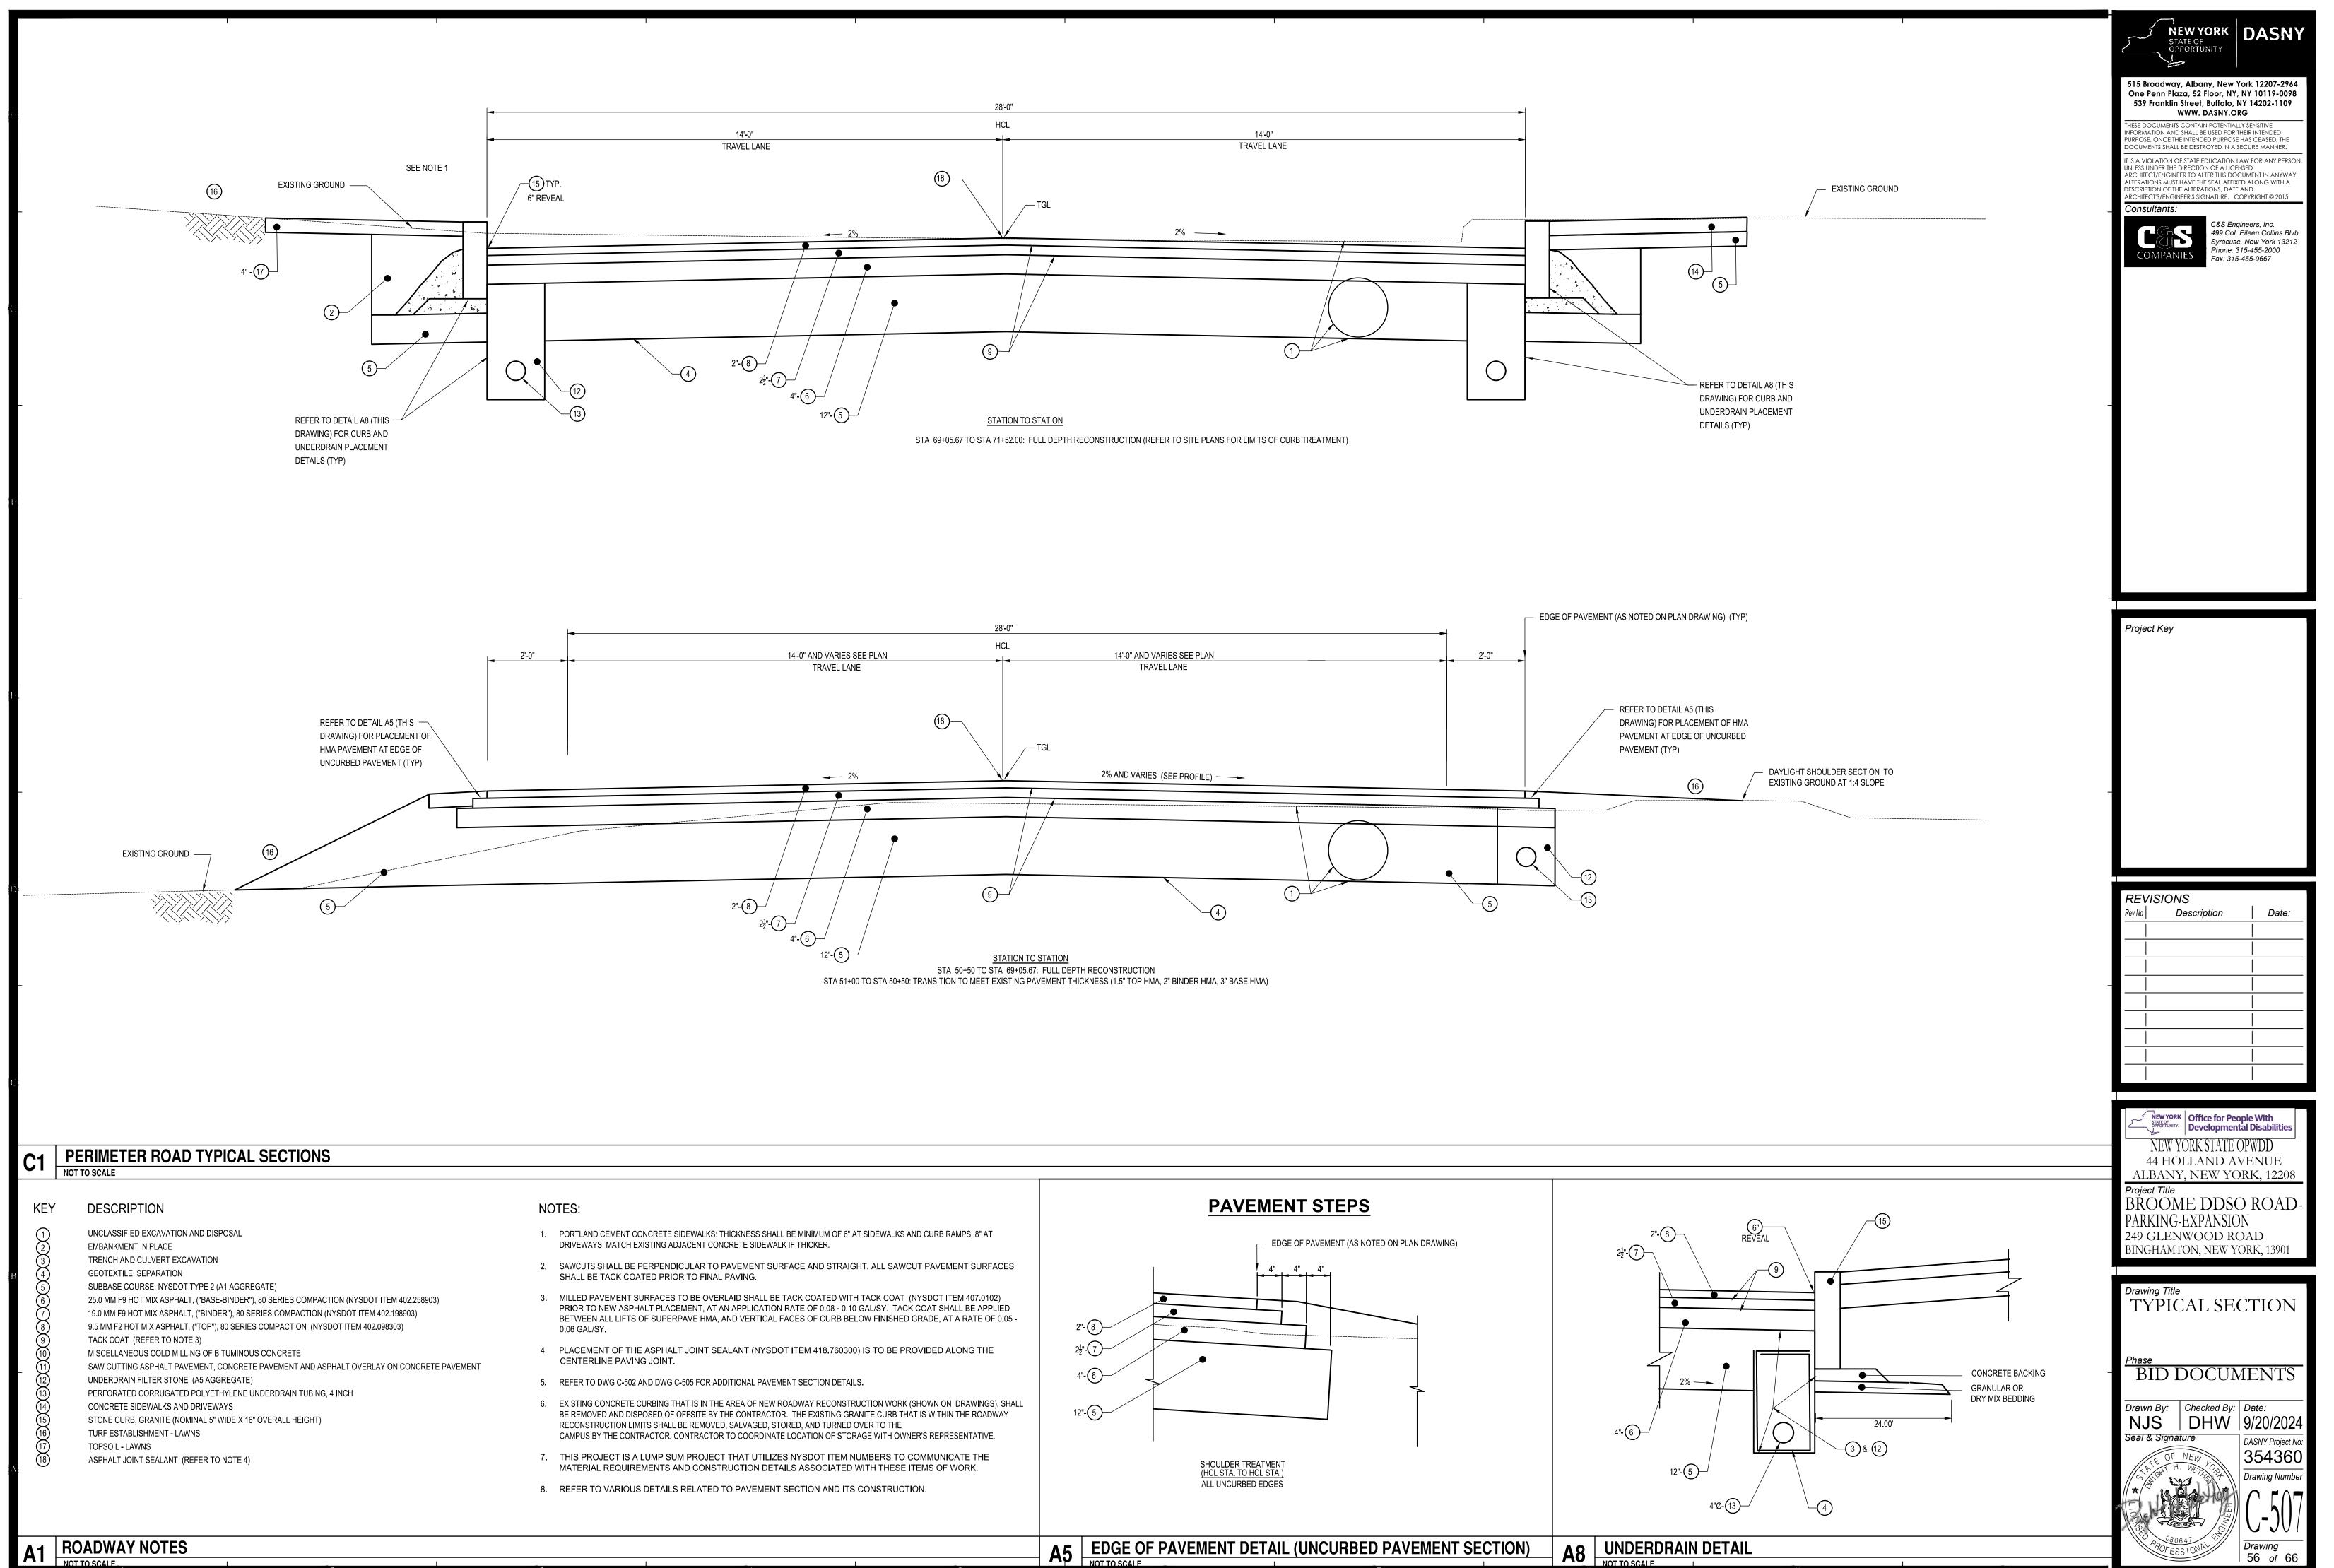
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NOTES

FIRE HYDRANT ASSEMBLY DETAIL

C8

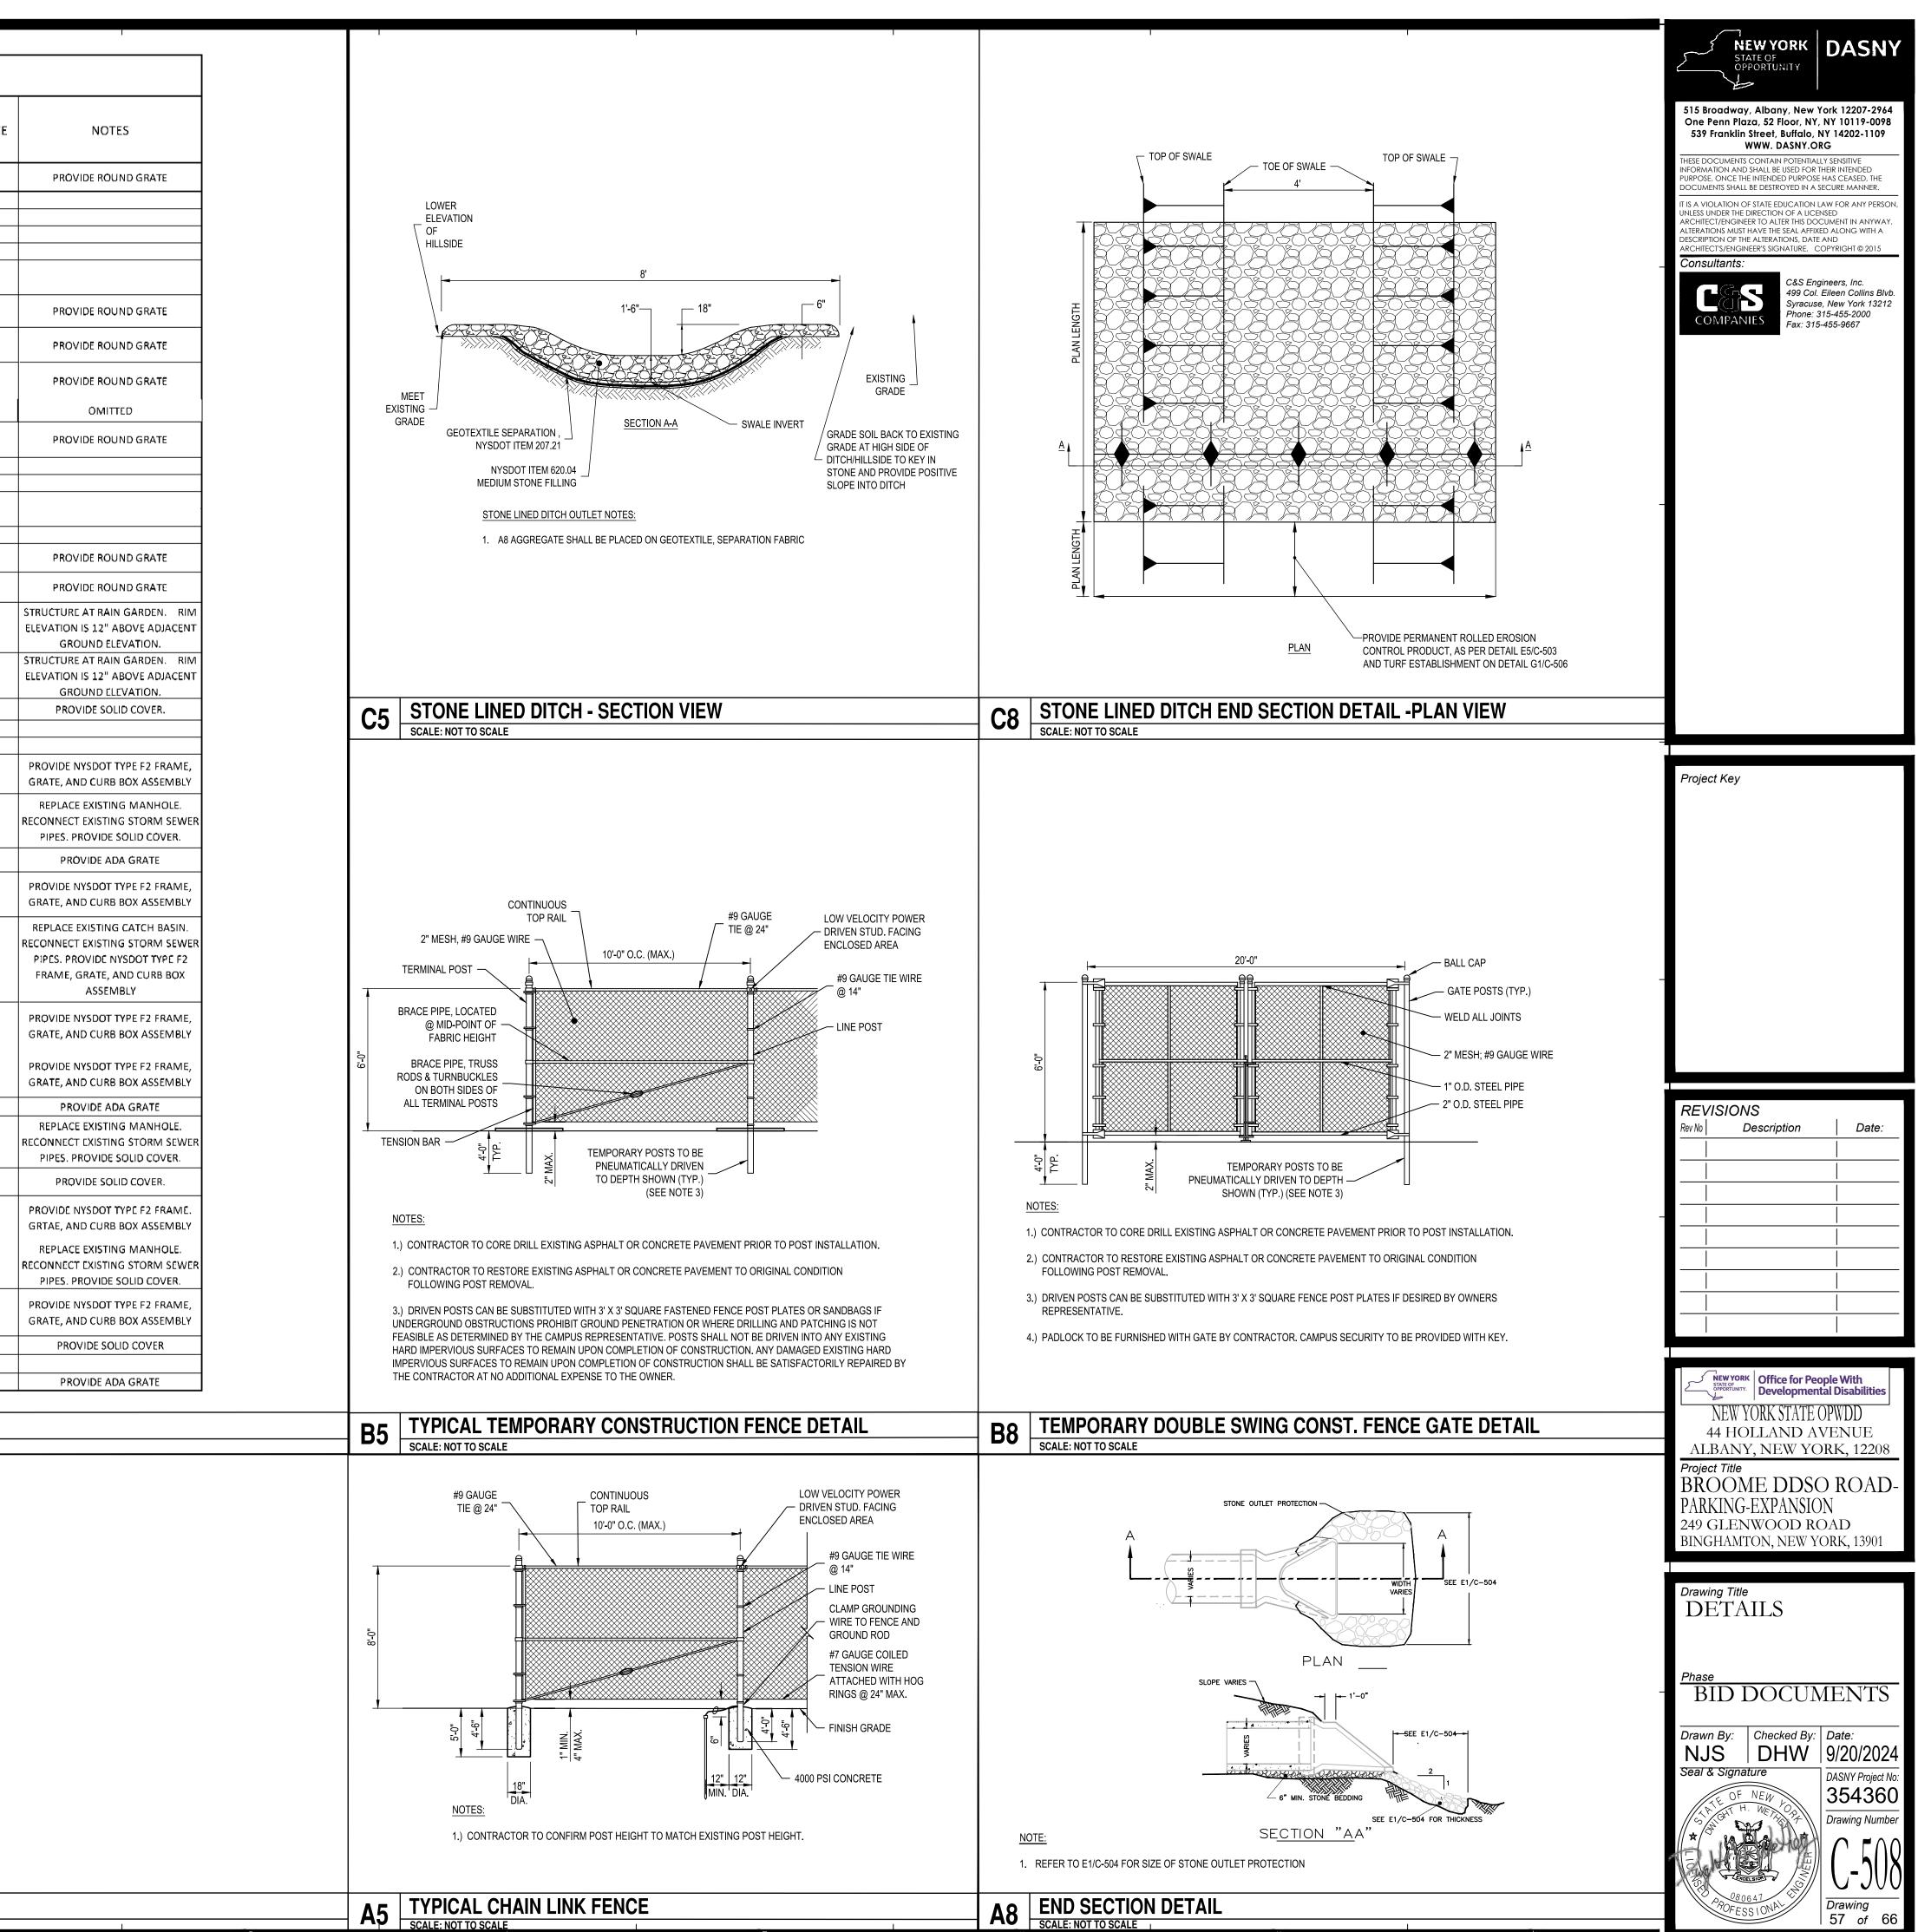




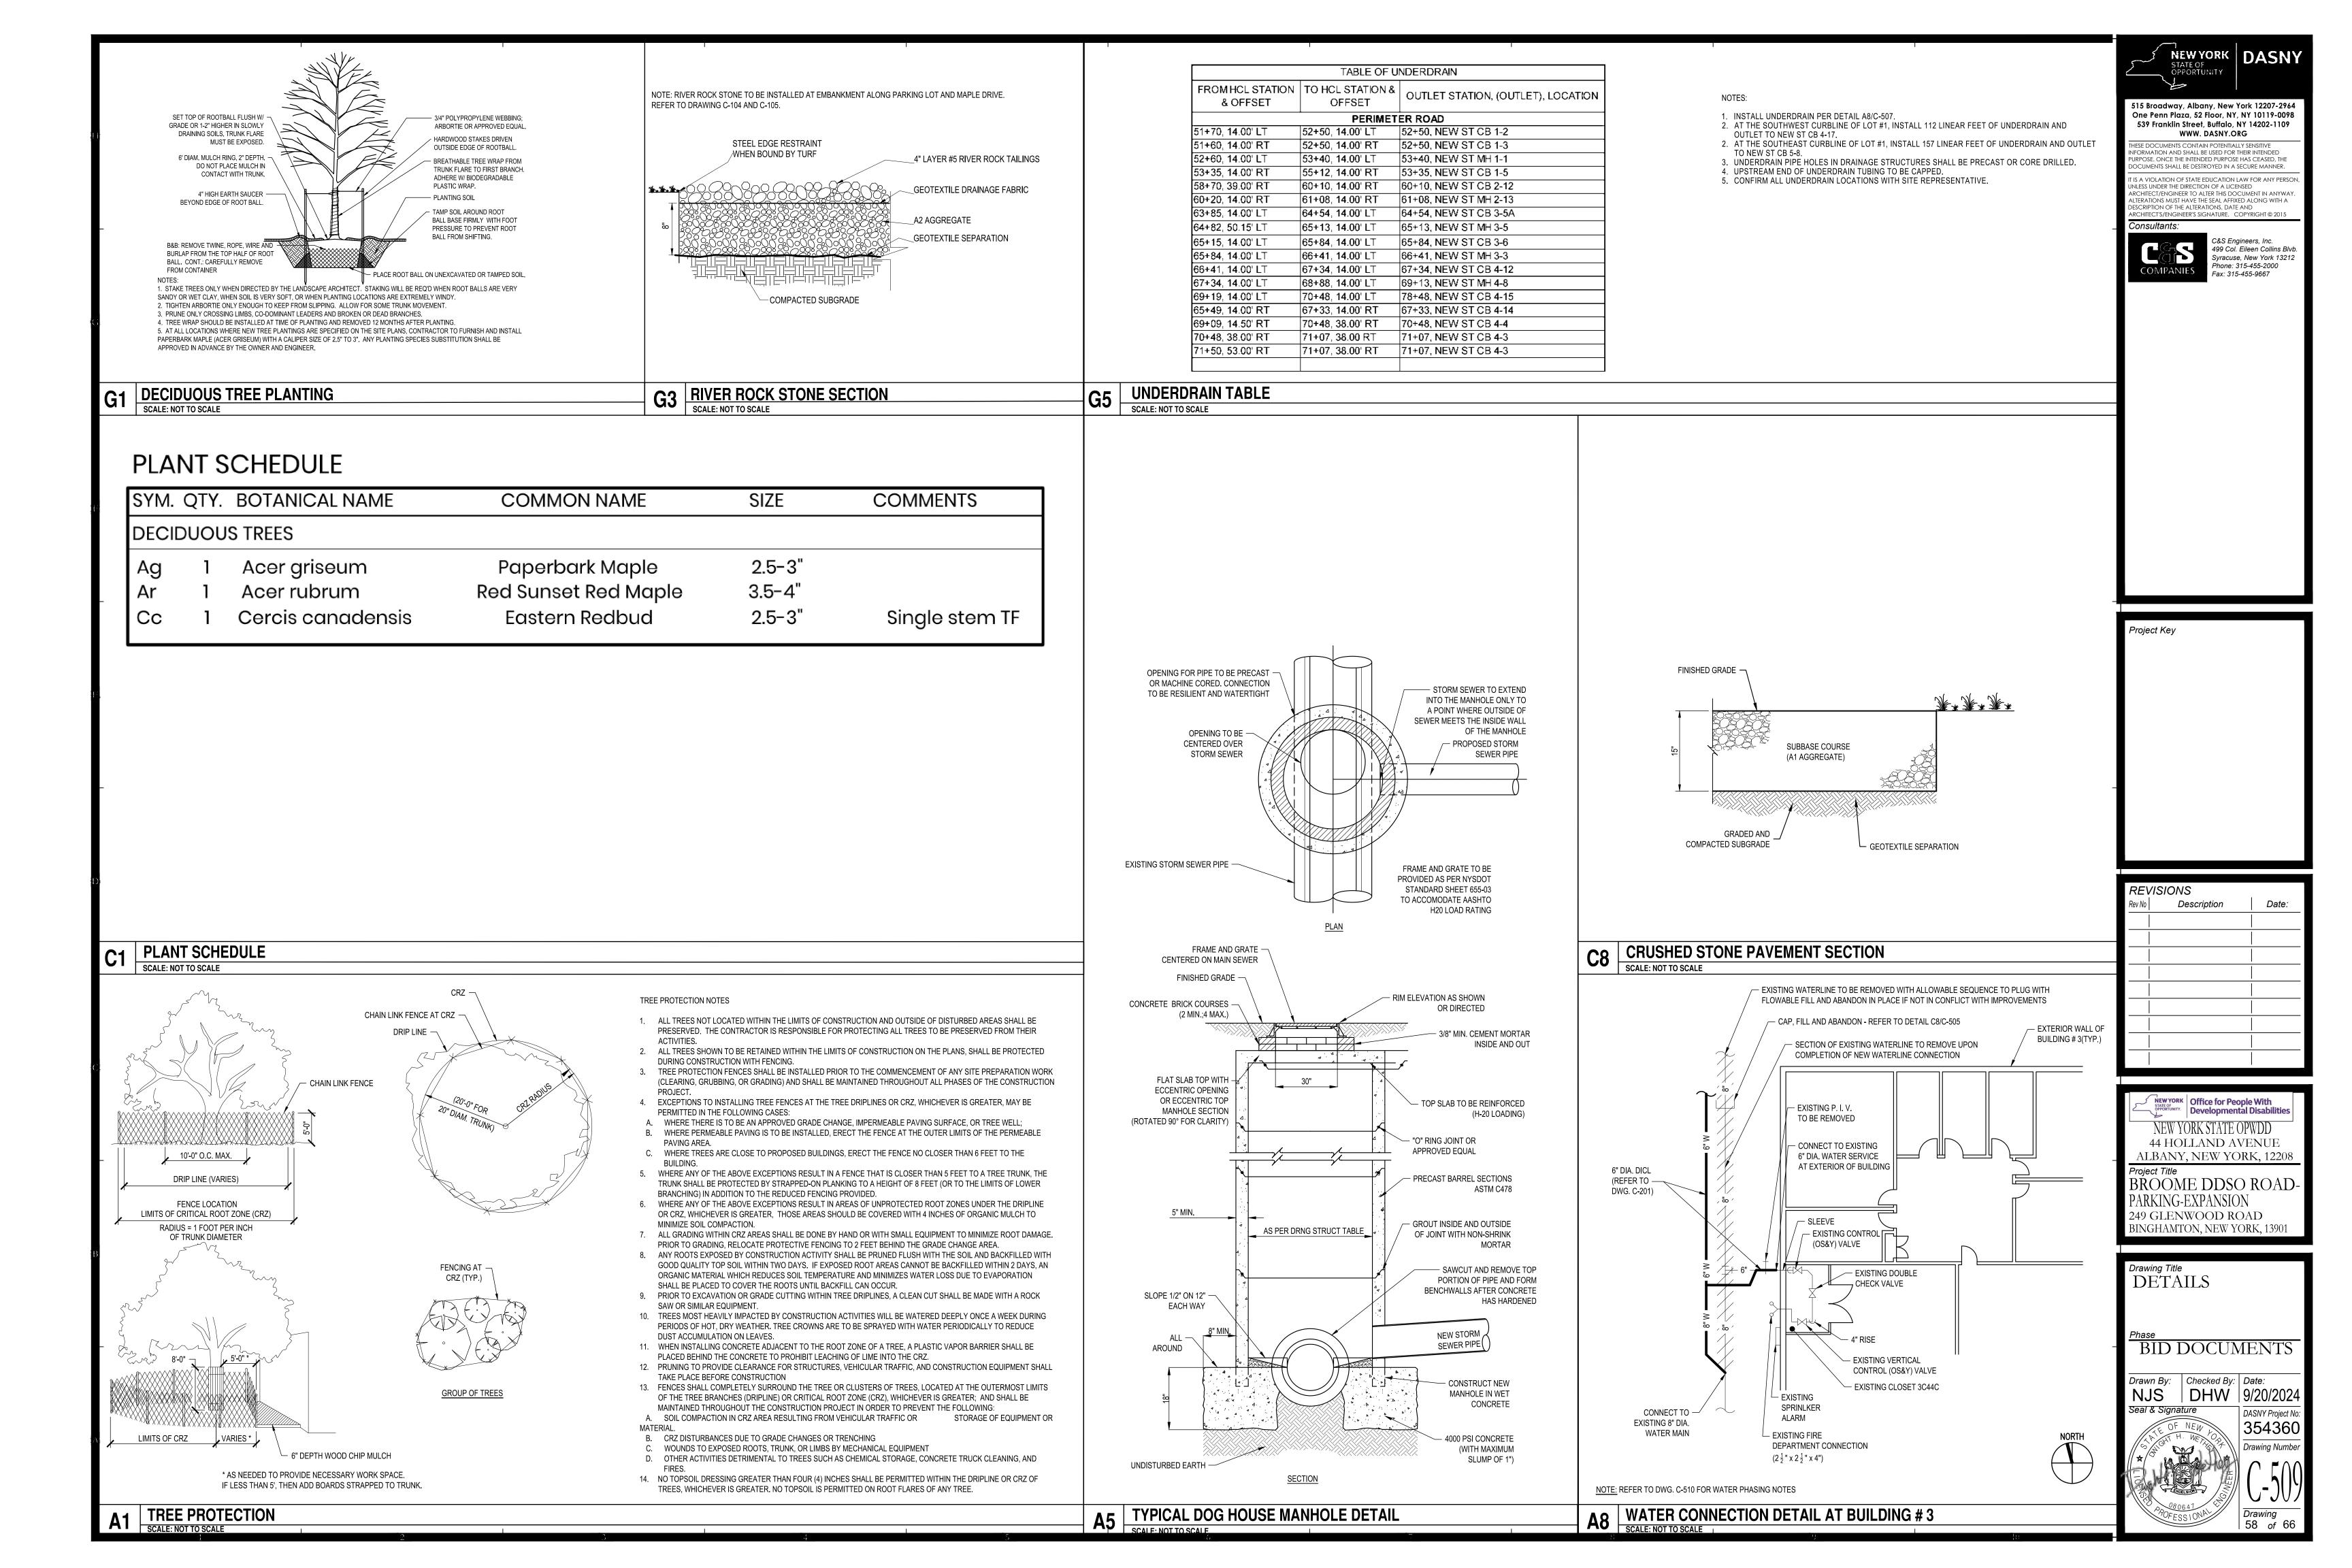
		ТА	BLE OF DRAINAGE S	TRUCTURES	
DRAINAGE STRUCTURE NUMBER	STRUCTURE TYPE	NORTHING	EASTING	SUMP	DETAIL REFE
MH 1-1	60" DIAMETER MANHOLE / CATCHBASIN	774712.158	994645.319	1193.88	DETAIL A1/
CB 1-2	3'X3' CATCH BASIN	774630.035	994650.748	1197.06	DETAIL A3/
CB 1-3	3'X3' CATCH BASIN	774632.245	994681.934	1198.86	DETAIL A3/
CB 1-4	3'X3' CATCH BASIN	774707.815	994676.057	1196.39	DETAIL A3/
CB 1-5	3'X3' CATCH BASIN	774886.696	994713.373	1192.54	DETAIL A3/
ĊB 2-1	3'X3' CATCH BASIN	775008.282	994768.951	1190.94	DETAIL A3/
CB 2-2 MH 2-3	3'X3' CATCH BASIN 48" DIAMETER MANHOLE	774990.875	994750.153 994727.389	1190.58 1186.45	DETAIL A3/
MH 2-4	/ CATCH BASIN 48" DIAMETER MANHOLE / CATCH BASIN	775092.748	994772.795	1183.29	DETAIL A1/
MH 2-5	60" DIAMETER MANHOLE / CATCHBASIN	775339.187	994825.334	1180.68	DETAIL A1/
OMITTED CB 2-6	OMITTED	OMITTED	OMITTED	ÔMITTED	ÖMITTI
MH 2-7	48" DIAMETER MANHOLE / CATCHBASIN	775328.077	994855.427	1180.25	DETAIL A1/
CB 2-8	3'X3' CATCH BASIN	775287.287	995004.266	1186.49	DETAIL A3/
CB 2-9	3'X3' CATCH BASIN	775033.892	994981.105	1193.49	DETAIL A3/
CB 2-10	3'X3' CATCH BASIN	775099.09	994962.325	1193.53	DETAIL A3/
CB 2-11	3'X3' CATCH BASIN	775091.625	994993.339	1192.80	DETAIL A3/
CB 2-12	3'X3' CATCH BASIN	775181.124	995012.379	1191.79	DETAIL A3/
MH 2-13	48" DIAMETER MANHOLE / CATCH BASIN 60" DIAMETER MANHOLE	775283.547	995034.217	1187.49	DETAIL A1/
MH 2-14	/ CATCHBASIN	775364.458	995069.3	1188.40	DETAIL A1/
CB 2-15	2'X2' CATCH BASIN	775309.046	995102.376	1189.50	DETAIL A5/
CB 2-16	2'X2' CATCH BASIN	775356.004	995111.582	1188.92	DETAIL A5/
MH 2-17	48" DIAMETER MANHOLE	775275.174	994843.705	1179.71	DETAIL A1/
CB 3-1	3'X3' CATCH BASIN	775470.005	995137.046	1191.20	DETAIL A3/
CB 3-2	3'X3' CATCH BASIN	775439.954	995154.773	1190.73	DETAIL A3/
MH 3-3	48" DIAMETER MANHOLE / CATCH BASIN	775372.674	995437.927	1191.91	DETAIL A1/
MH 4-1	60" DIAMETER DOG HOUSE MANHOLE	774856.2	995348.558	1177.00	DETAIL A5/
ĊB 4-2	3'X3' CATCH BASIN	774912.971	995356.43	1177.91	DETAIL A3/
CB 4-3	2'-10"X3' CURB INLET CATCH BASIN	774920.833	995320.434	1180.00	DETAIL E1/
СВ 4-4	2'-10"X3' CURB INLET CATCH BASIN	774977.501	995332.915	1179.25	DETAIL E1/0
СВ 4-5	2'-10"X3' CURB INLET CATCH BASIN	774991.564	995336.082	1179.12	DETAIL E1/0
CB 4-6	2'-10"X3' CURB INLET CATCH BASIN	775032.33	995345.048	1179.64	DETAIL E1/0
СВ 4-7	3'X3' CATCH BASIN	774984.402	995371.417	1178.84	DETAIL A3/
MH 4-8	48" DIAMETER MANHOLE	775094.723	995421.361	1179.90	DETAIL A1/
MH 4-9	48" DIAMETER MANHOLE	775106.109	995400.029	1181.48	DETAIL A1/
СВ 4-10	2'-10"X3' CURB INLET CATCH BASIN	775108.009	995388.313	1182.63	DETAIL E1/
MH 4-11	48" DIAMETER MANHOLE	775229.418	995426.053	1187.92	DETAIL A1/
СВ 4-12	2'-10"X3' CURB INLET CATCH BASIN	775274.166	995450.974	1190.93	DETAIL E1/
MH 4-13	48'' DIAMETER MANHOLE	775278.446	995436.889	1190.86	DETAIL A1/
CB 4-14	3'X3' CATCH BASIN	775279.674	995425.789	1190.78	DETAIL A3/0

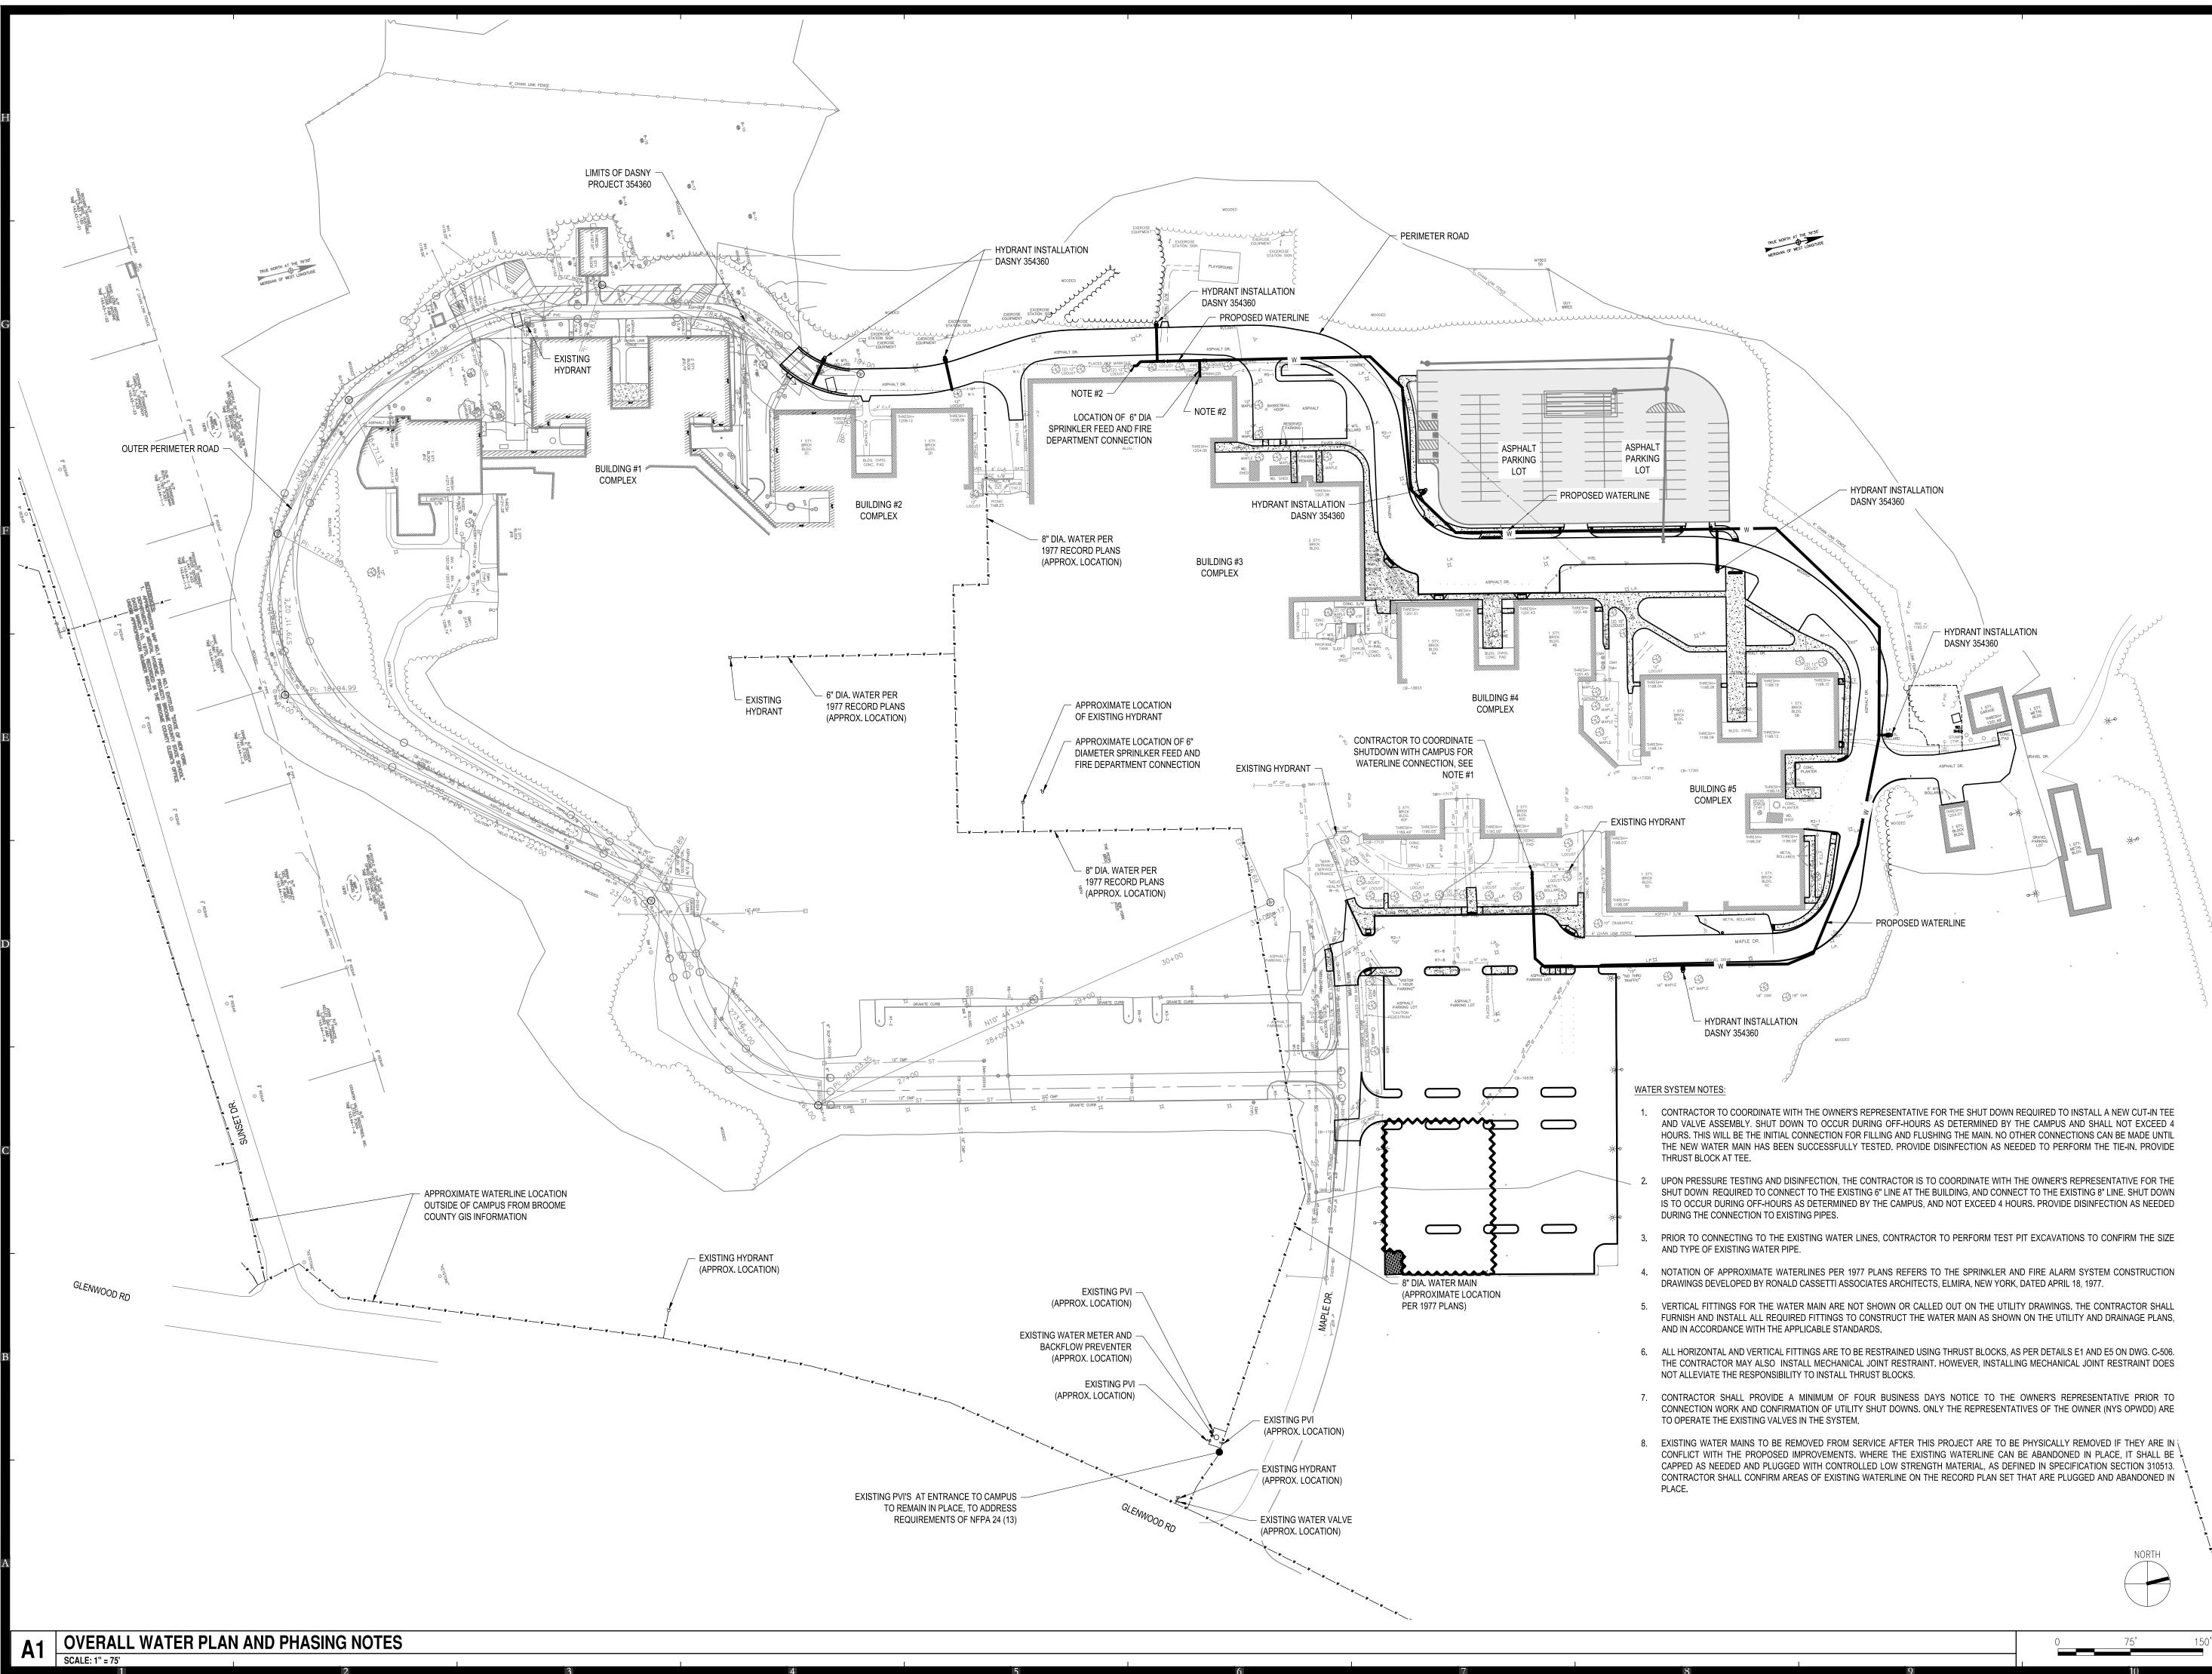
DRAINAGE STRUCTURE TABLE **B1**

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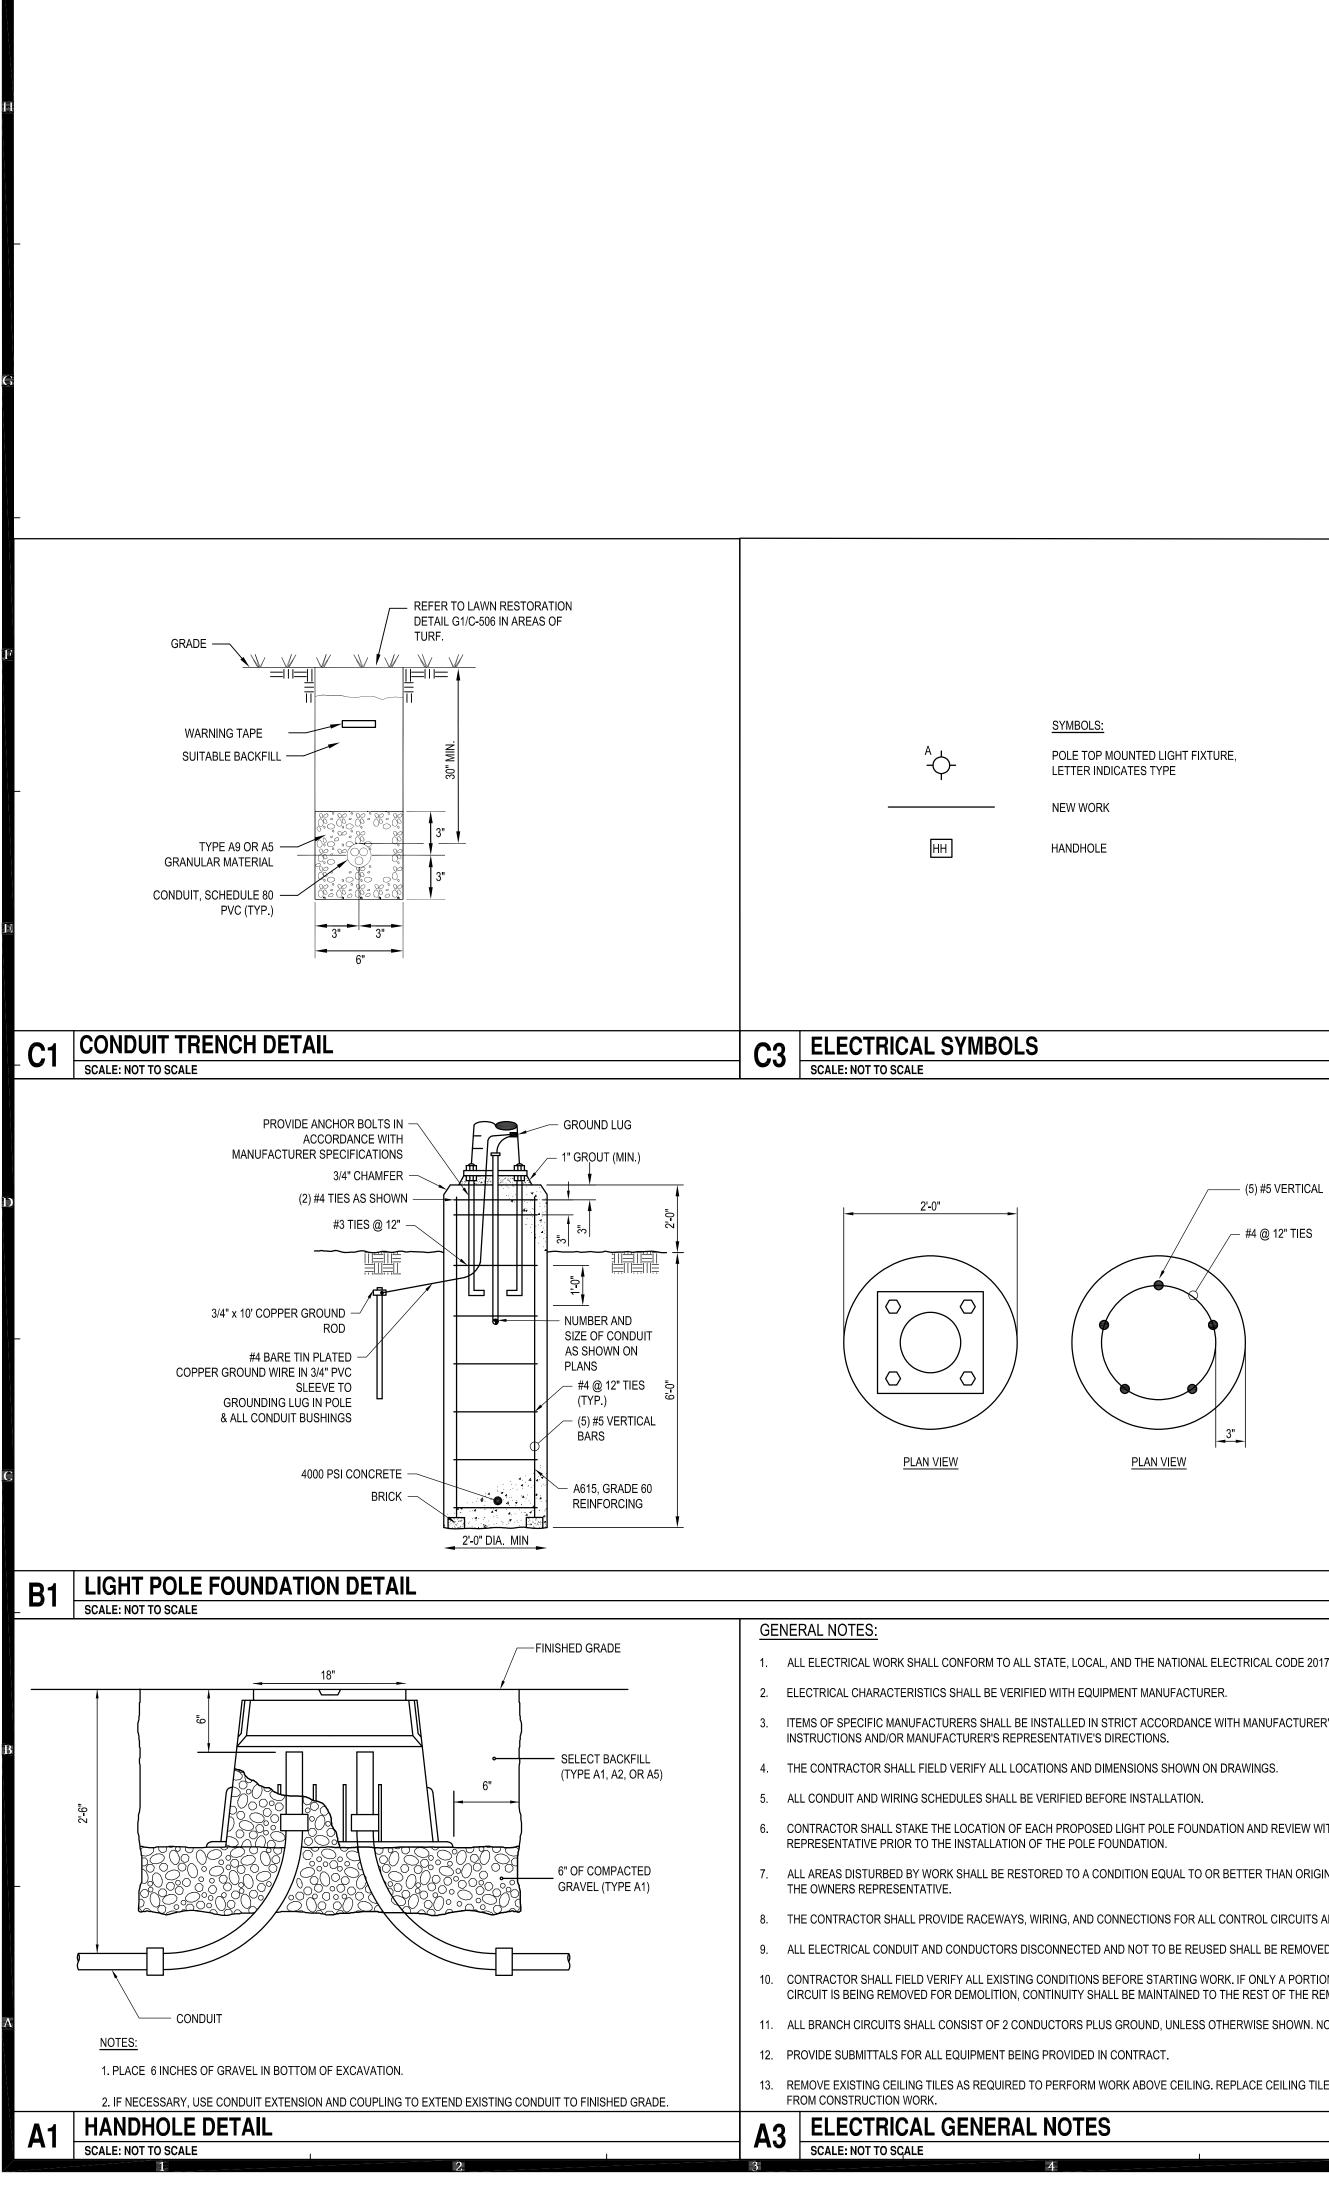
A5 TYPICAL CHAIN LINK FENCE





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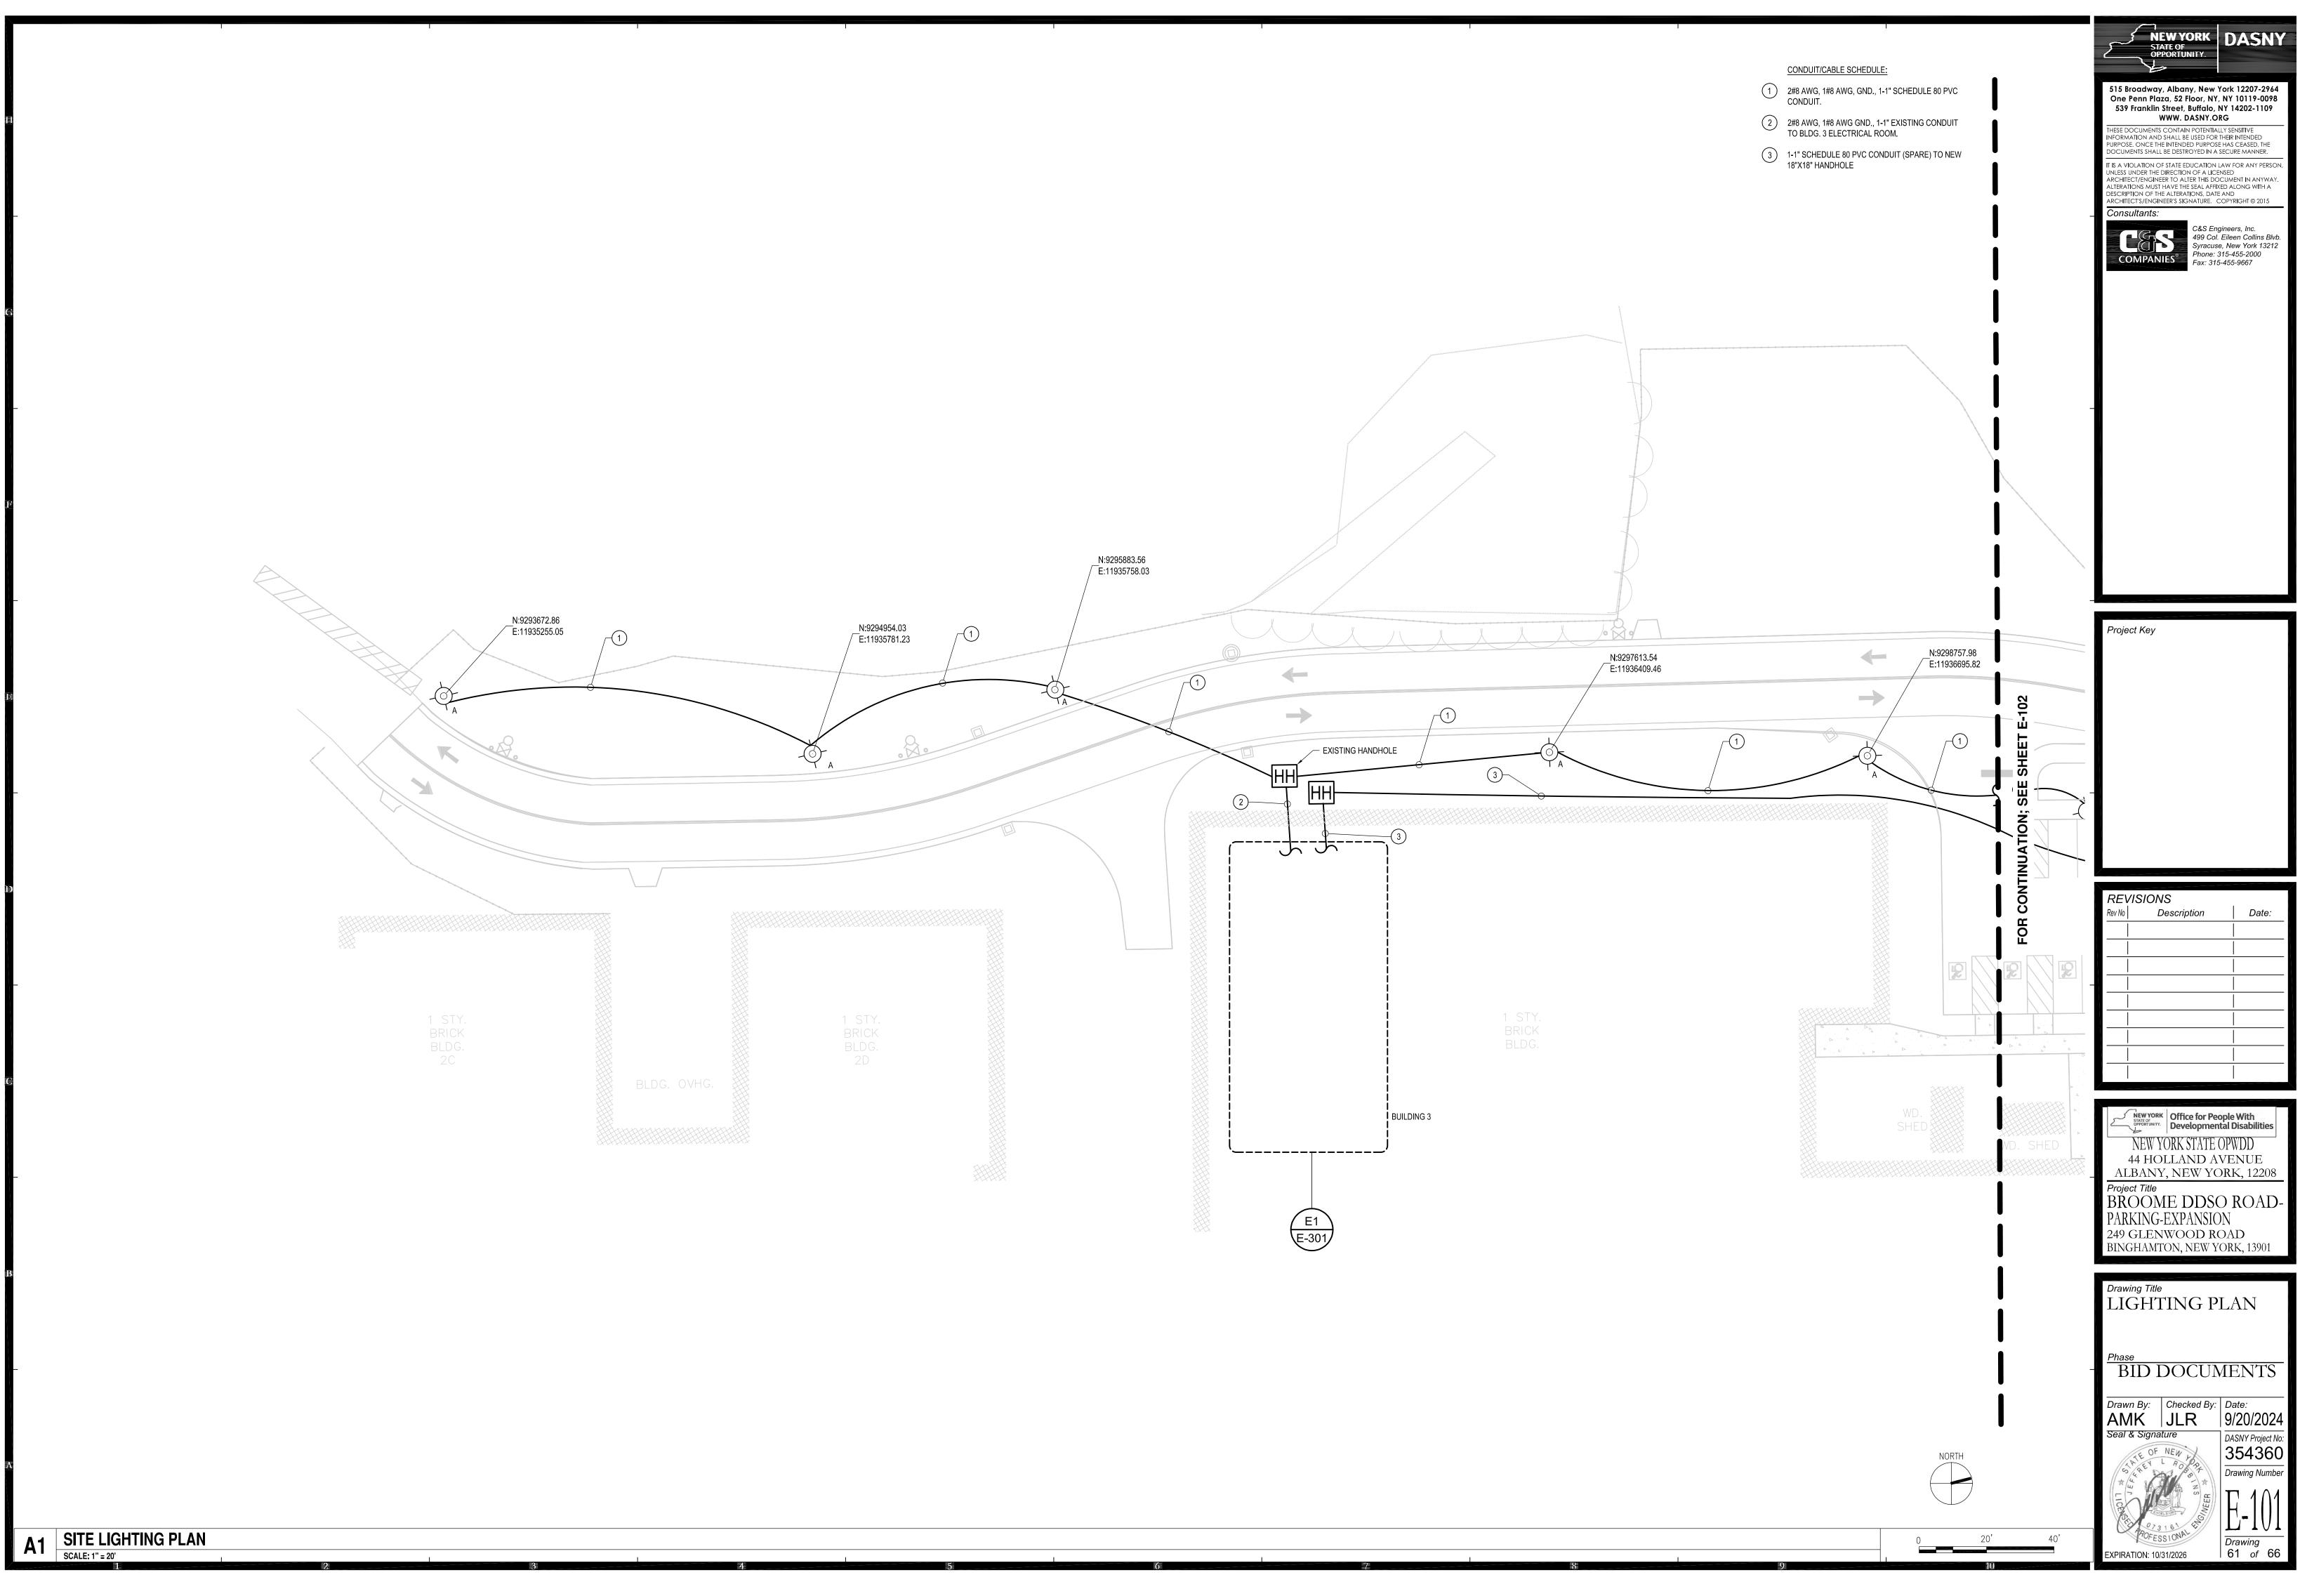
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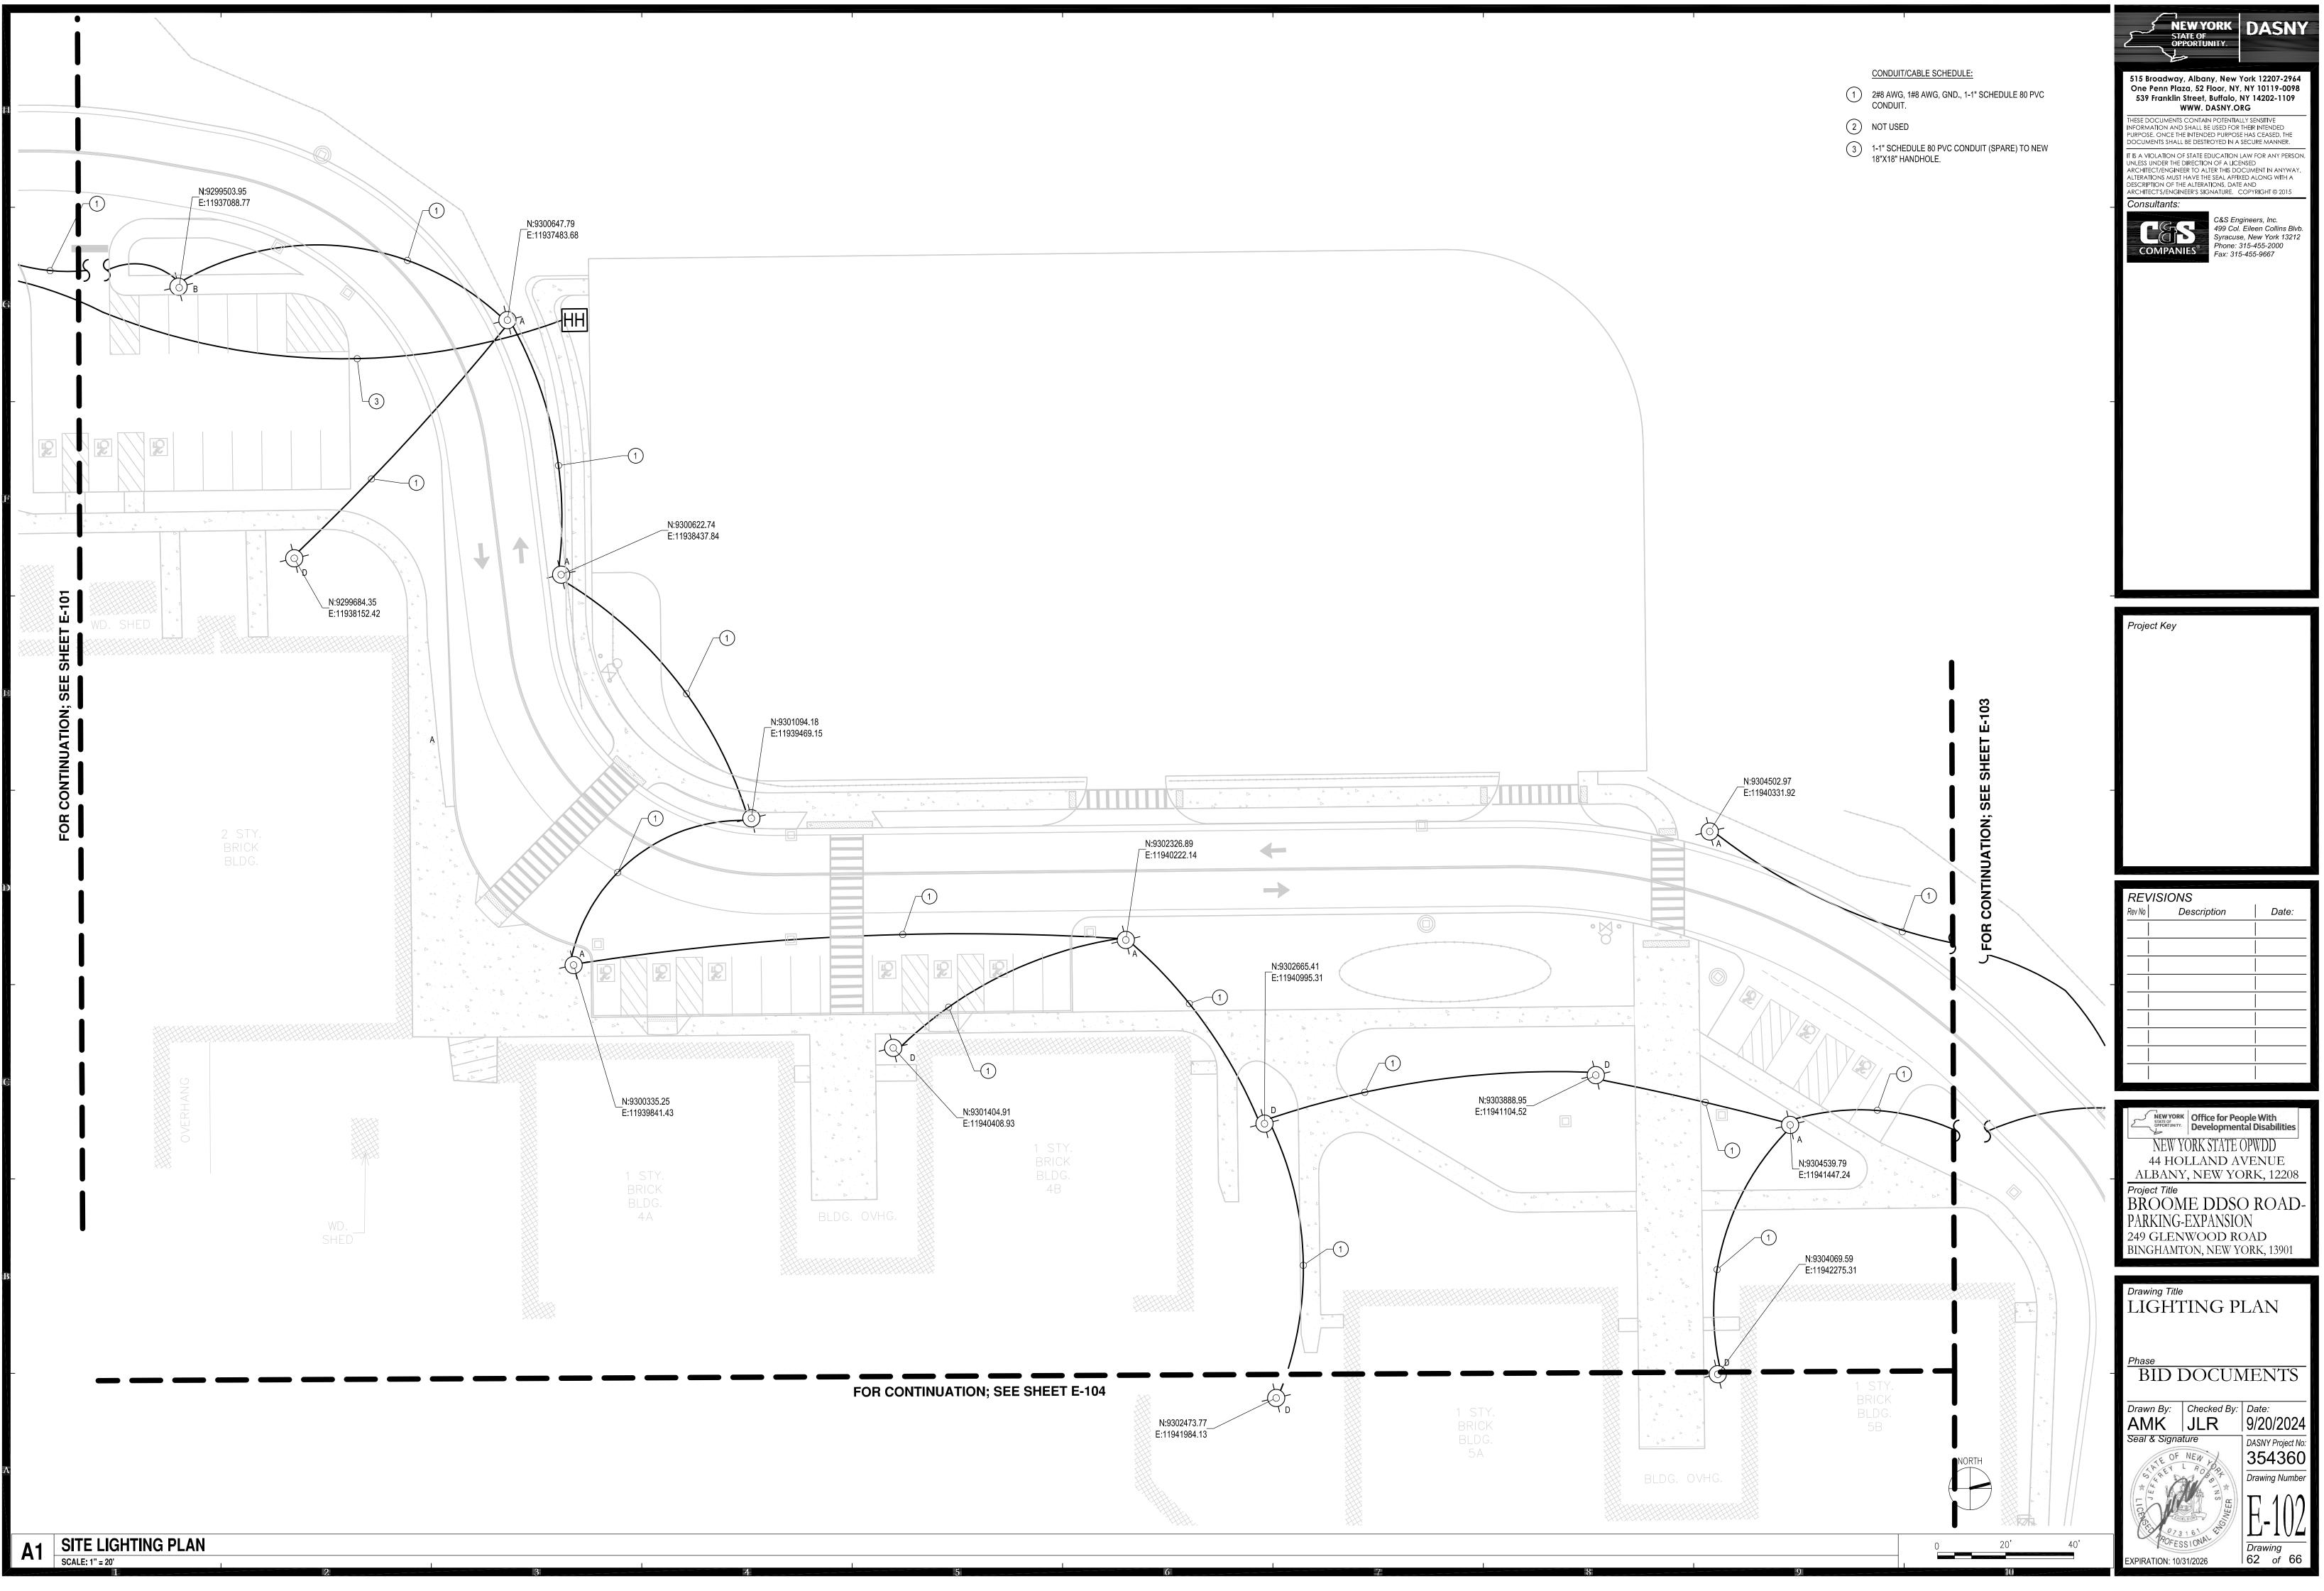


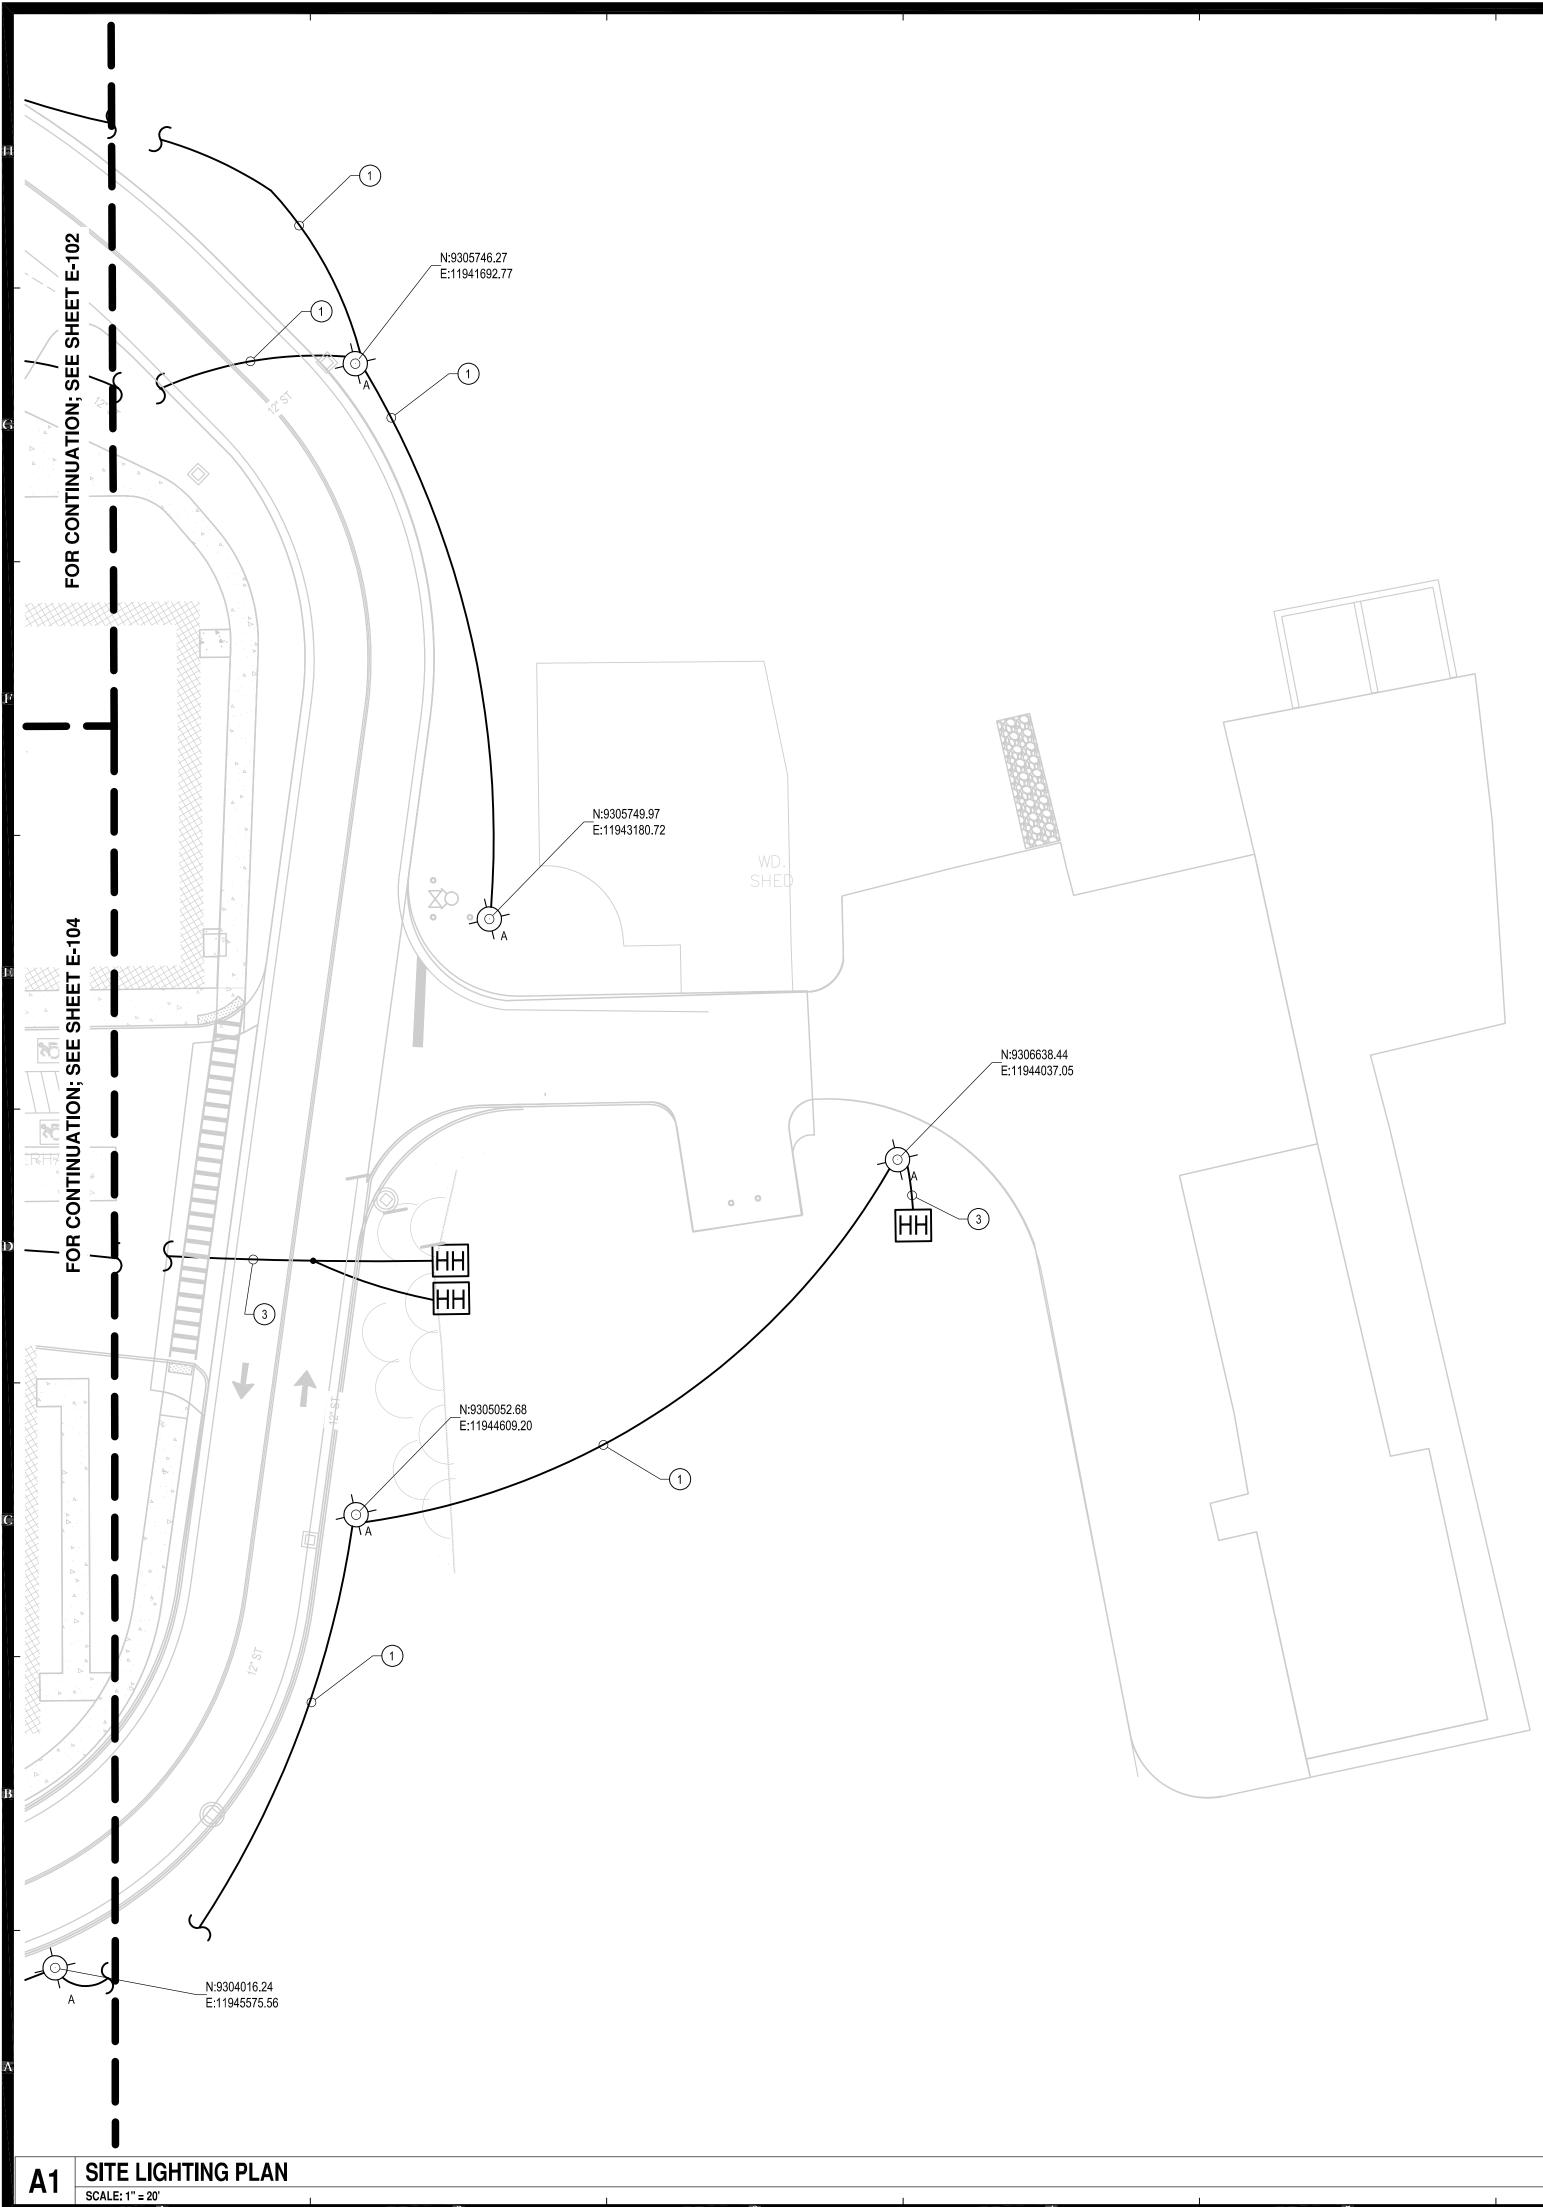
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PROPOSED LIGHT POLE FOUNDATION AND REVIEW WITH THE OWNERS HE POLE FOUNDATION.			A	C
ED TO A CONDITION EQUAL TO OR BETTER THAN ORIGINAL AS DETERMINED BY			В	C
NG, AND CONNECTIONS FOR ALL CONTROL CIRCUITS AND INTERLOCK.			С	Ε
NNECTED AND NOT TO BE REUSED SHALL BE REMOVED.			D	-
NDITIONS BEFORE STARTING WORK. IF ONLY A PORTION OF AN EXISTING NUITY SHALL BE MAINTAINED TO THE REST OF THE REMAINING CIRCUIT.			E	L
TORS PLUS GROUND, UNLESS OTHERWISE SHOWN. NO SHARED NEUTRALS.		l		L
ROVIDED IN CONTRACT.				
ERFORM WORK ABOVE CEILING. REPLACE CEILING TILES THAT ARE DAMAGED				
IOTES	A6	LUMI	NAIRE SCH	EDULE
		SCALE: NO	DT TO SCALE	

MASTER LUMINAIRE SCHEDULE						
FIXTURE DESCRIPTION	MANUFACTURER & MODEL NO.	NUMBER AND TYPE OF LAMP	VOLTS	BALLAST	MOUNTING	REMARKS
A	LITHONIA DSX1 SERIES / DSX1-LED-P2-40K-T2M-208-DF	70 WATT / LED	208V	NA	SQUARE POLE 21'	COLOR: BLACK
В	LITHONIA DSX1 SERIES / DSX1-LED-P2-40K-T2M-208-DF	54 WATT / LED	208V	NA	SQUARE POLE 21'	COLOR: BLACK
С	LITHONIA DSX1 SERIES / DSX1-LED-P1-40K-BLC-208-DF	54 WATT / LED	208V	NA	SQUARE POLE 21'	COLOR: BLACK
D	LITHONIA DSX1 SERIES / DSX0-LED-P1-40K-T5W-208-DF	38 WATT / LED	208V	NA	SQUARE POLE 16'	COLOR: BLACK
E	LITHONIA DSX1 SERIES / DSX1-LED-P1-40K-T5M-208-DF	54 WATT / LED	208V	NA	SQUARE POLE 21'	COLOR: BLACK

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	Seal & Signature	DASNY Project No: 354360 Drawing Number E-001 Drawing 0 of 66	







CONDUIT/CABLE SCHEDULE:

1 NOT USED

2 NOT USED

3 1-2" SCHEDULE 80 PVC CONDUIT (SPARE) TO 18"x18" HANDHOLE. 1-3" SCHEDULE 80 PVC CONDUIT (SPARE) TO 24"X24" HANDHOLE.

515 Broadway, Albany, New York 12207-2964 One Penn Plaza, 52 Floor, NY, NY 10119-0098 539 Franklin Street, Buffalo, NY 14202-1109 WWW. DASNY.ORG THESE DOCUMENTS CONTAIN POTENTIALLY SENSITIVE INFORMATION AND SHALL BE USED FOR THEIR INTENDED PURPOSE. ONCE THE INTENDED PURPOSE HAS CEASED, THE DOCUMENTS SHALL BE DESTROYED IN A SECURE MANNER. IT IS A VIOLATION OF STATE EDUCATION LAW FOR ANY PERSON, UNLESS UNDER THE DIRECTION OF A LICENSED ARCHITECT/ENGINEER TO ALTER THIS DOCUMENT IN ANYWAY. ALTERATIONS MUST HAVE THE SEAL AFFIXED ALONG WITH A DESCRIPTION OF THE ALTERATIONS, DATE AND ARCHITECT'S/ENGINEER'S SIGNATURE. COPYRIGHT © 2015 Consultants: C&S Engineers, Inc. 499 Col. Eileen Collins Blvb. Syracuse, New York 13212 Phone: 315-455-2000 Fax: 315-455-9667 COMPANIES® Project Key REVISIONS Rev No Description Date: STATE OF OFFORTUNITY. OFFORTUNITY. OFFORTUNITY. OFFORTUNITY. NEW YORK STATE OPWDD 44 HOLLAND AVENUE ALBANY, NEW YORK, 12208 Project Title BROOME DDSO ROAD-PARKING-EXPANSION 249 GLENWOOD ROAD BINGHAMTON, NEW YORK, 13901 Drawing Title LIGHTING PLAN BID DOCUMENTS Drawn By: Checked By: Date: AMK JLR 9/20/2024 Seal & Signature DASNY Project No: 354360 OF NEW Drawing Number

POFESSIONA

XPIRATION: 10/31/2026

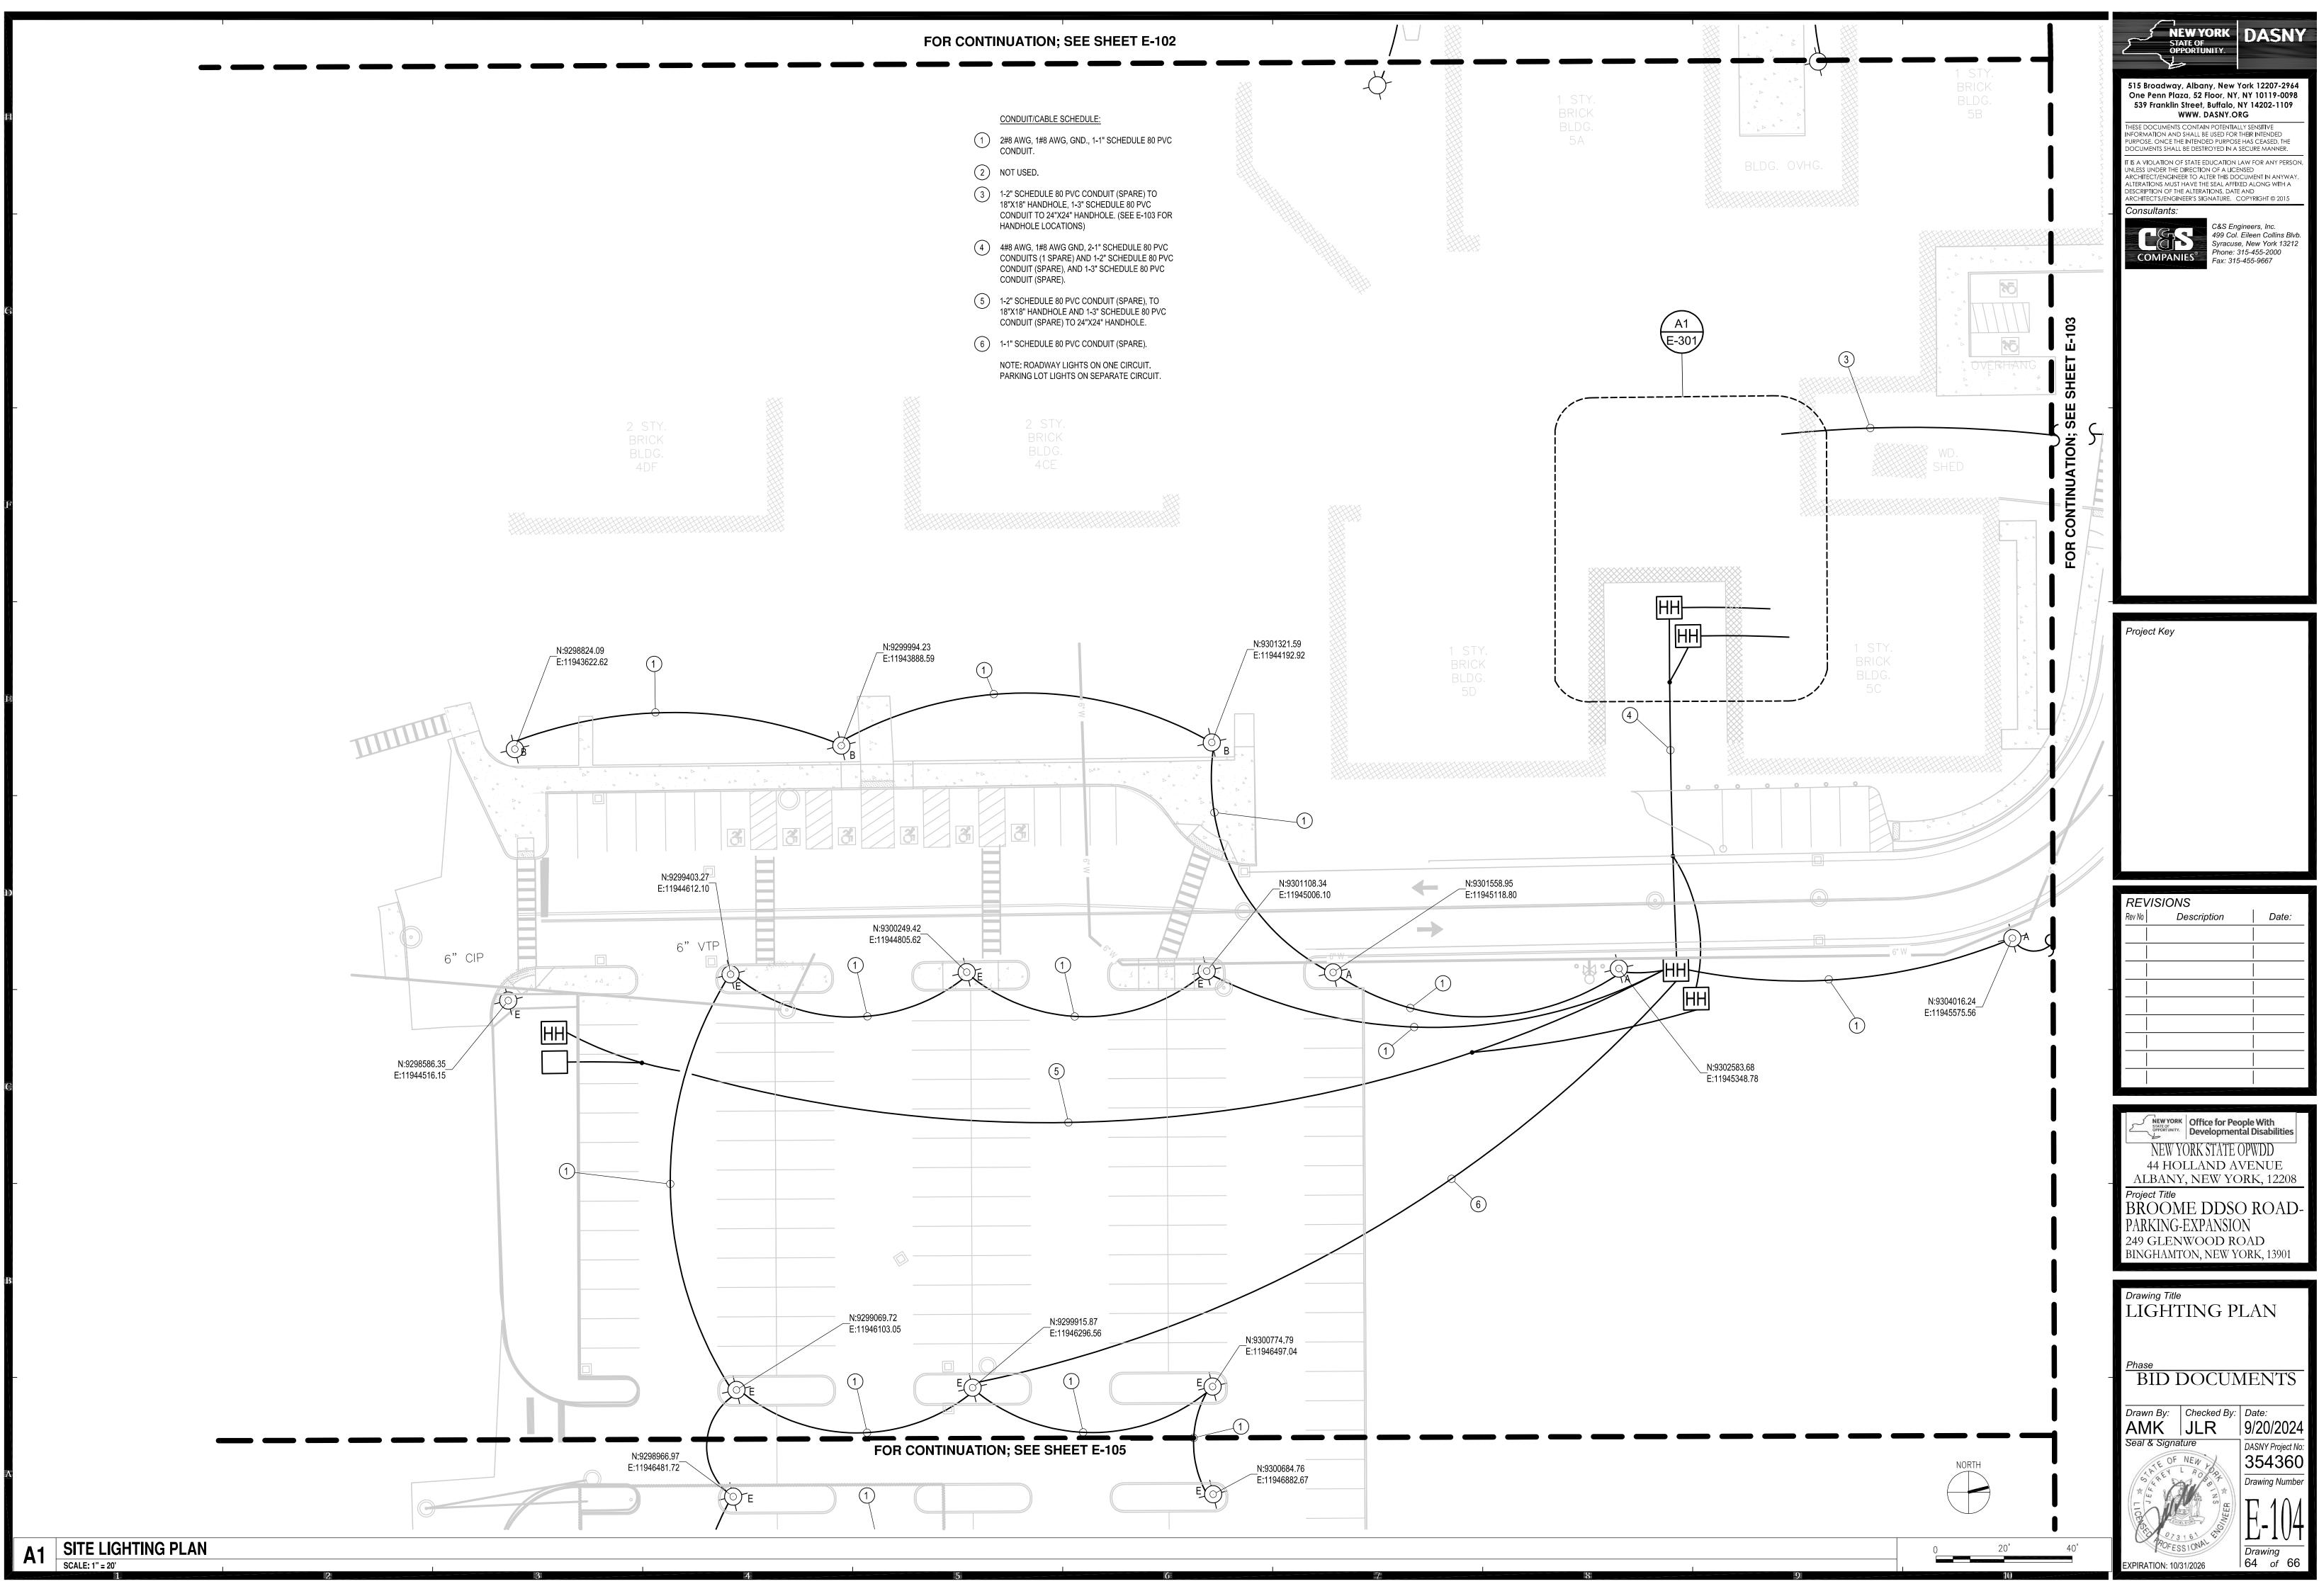
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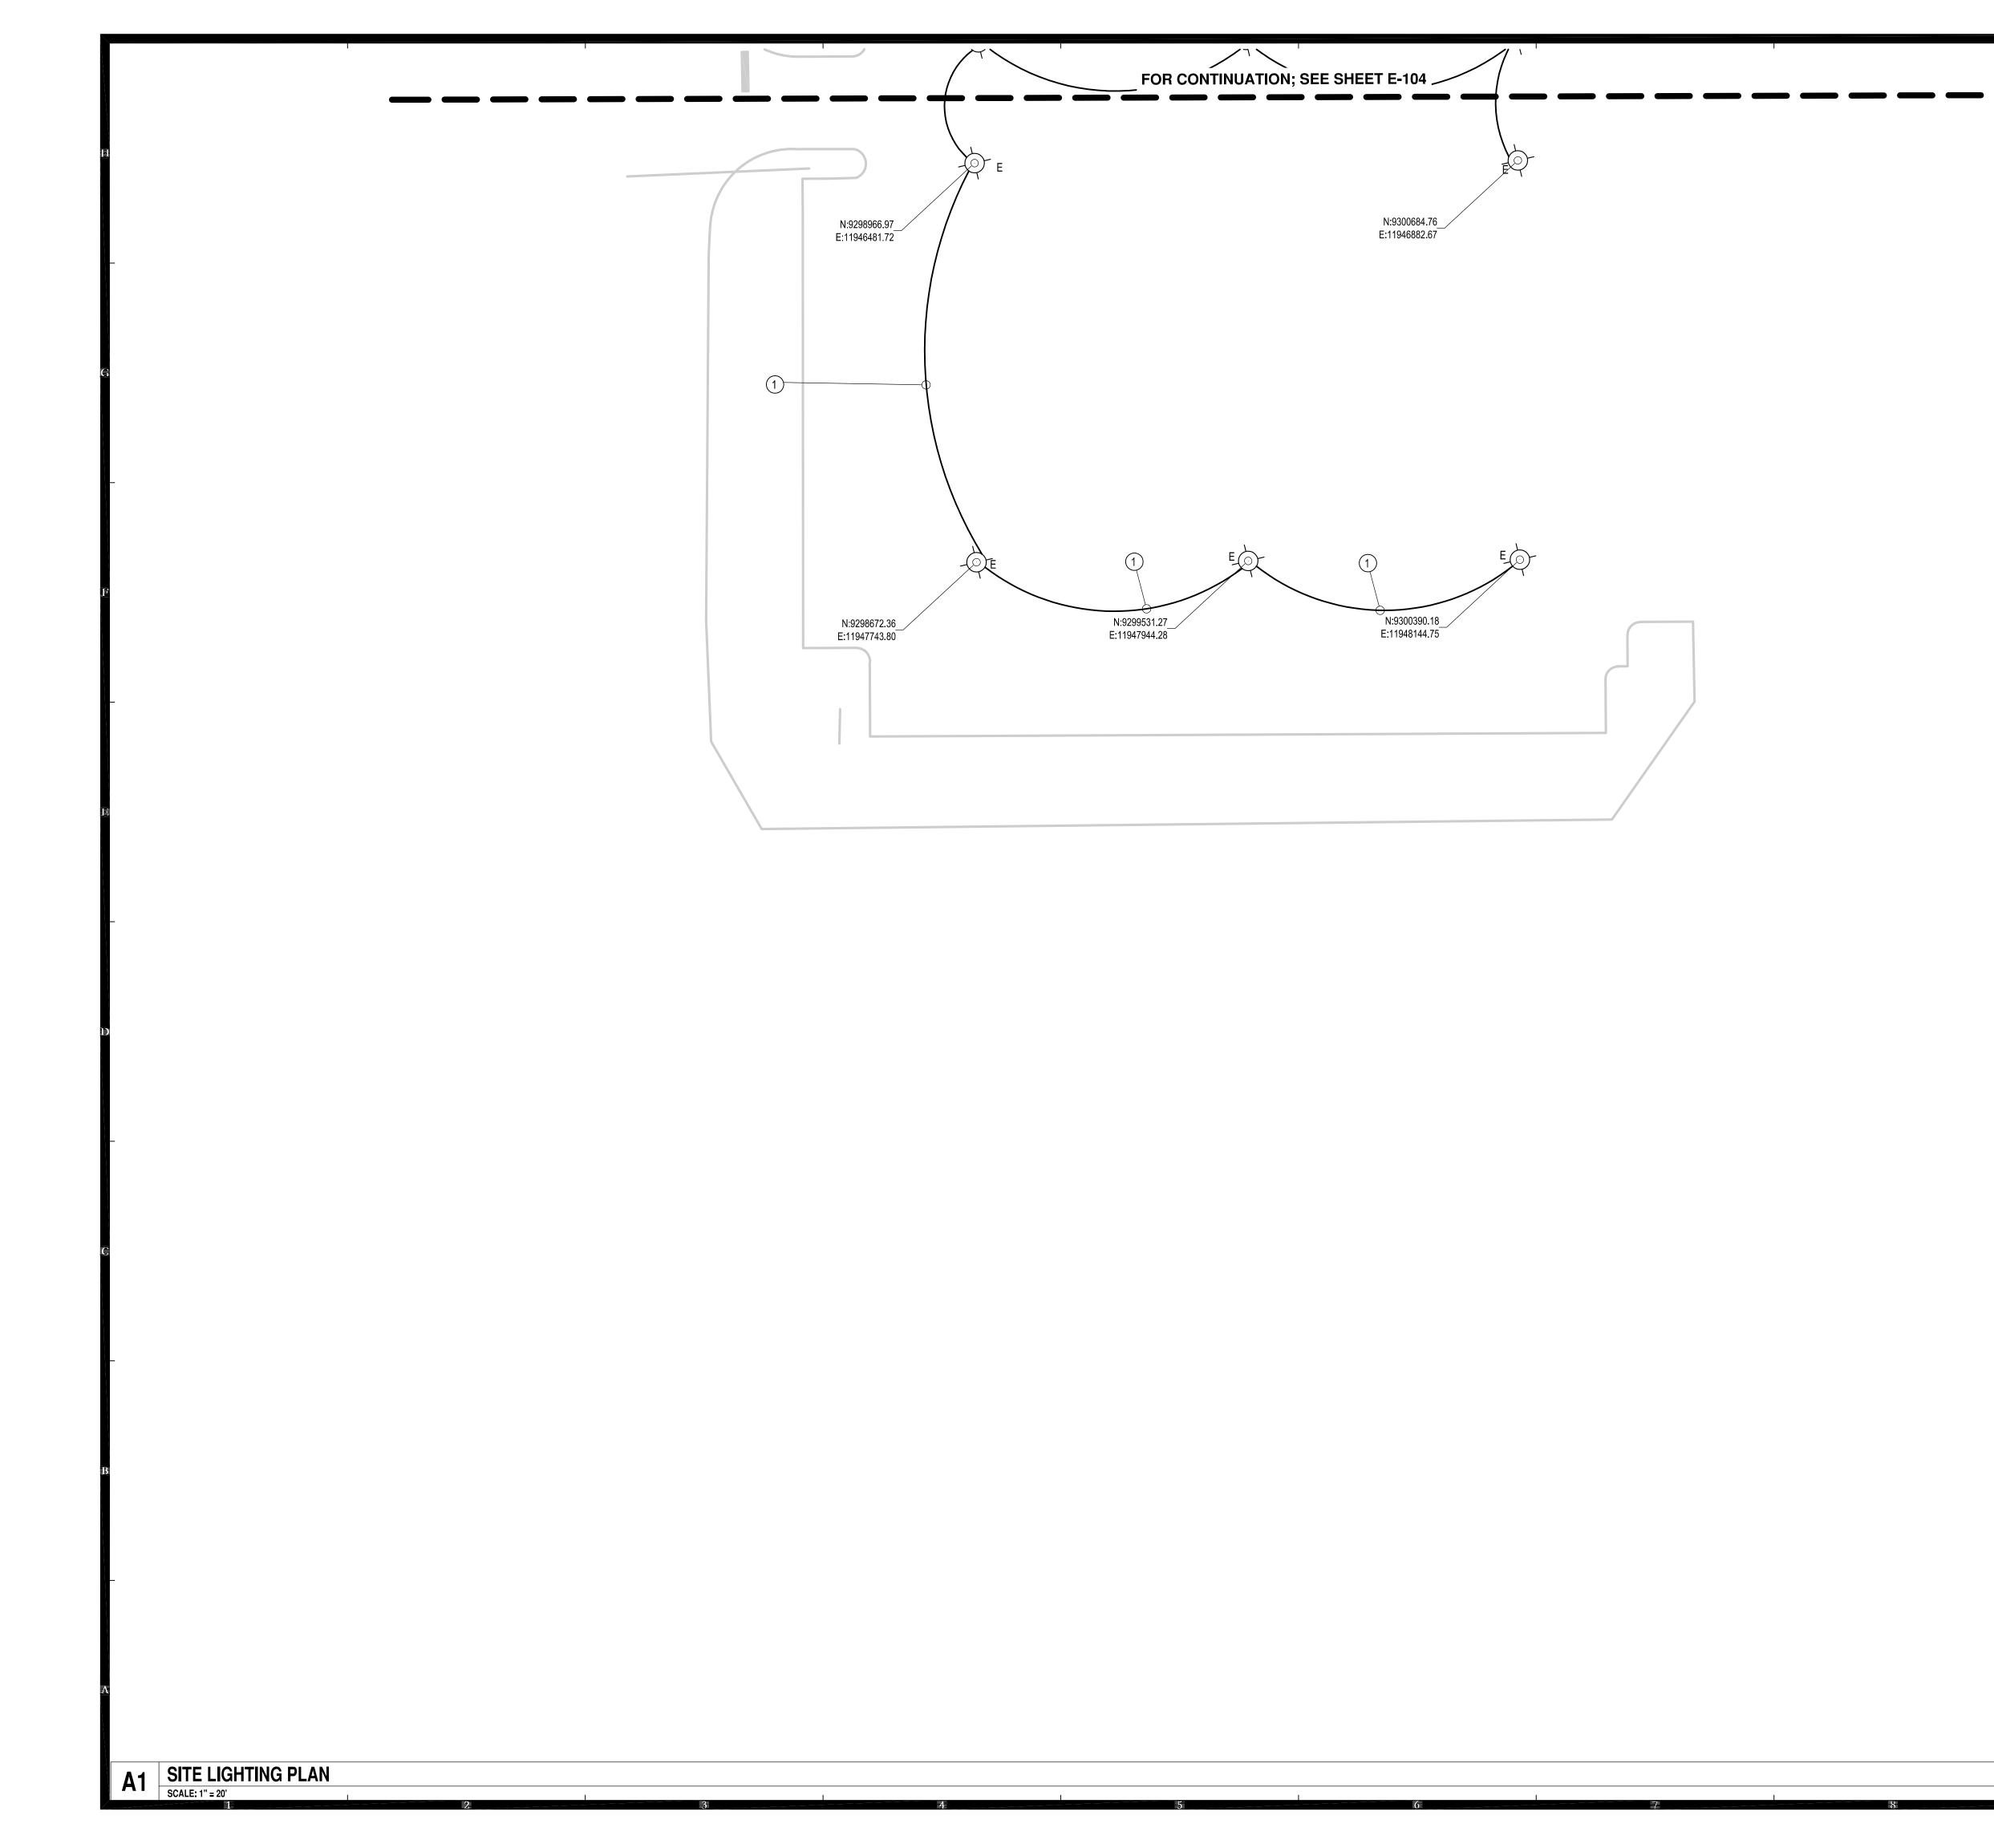
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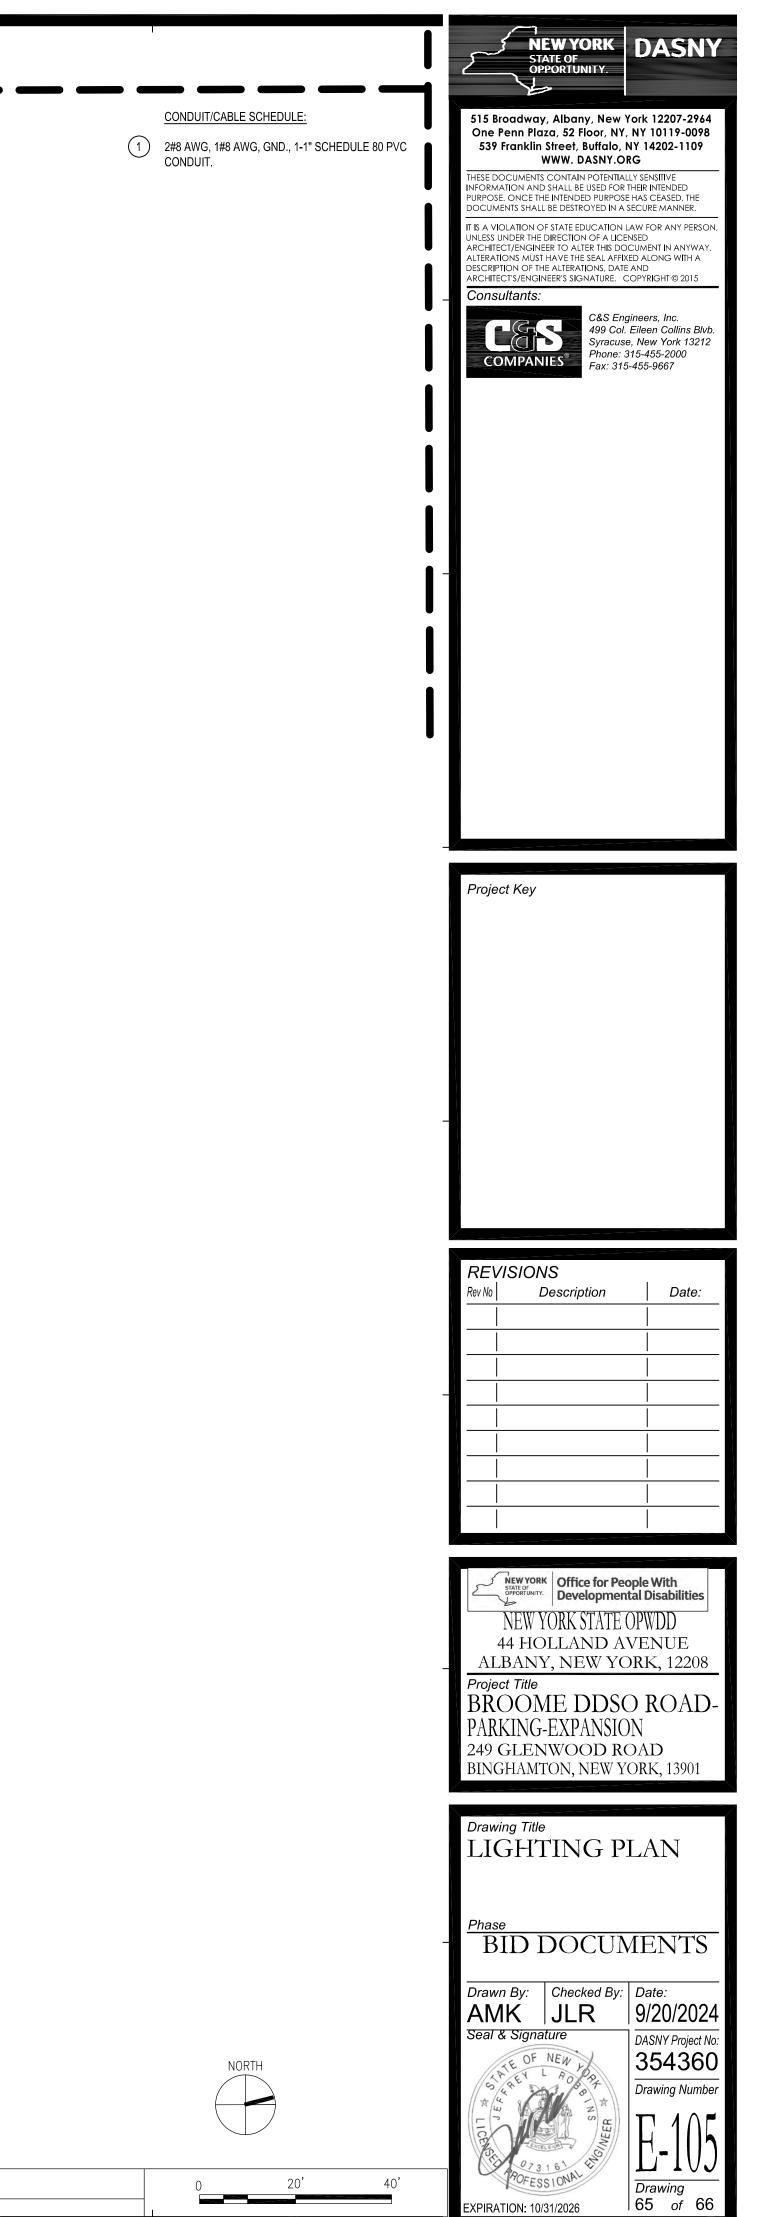
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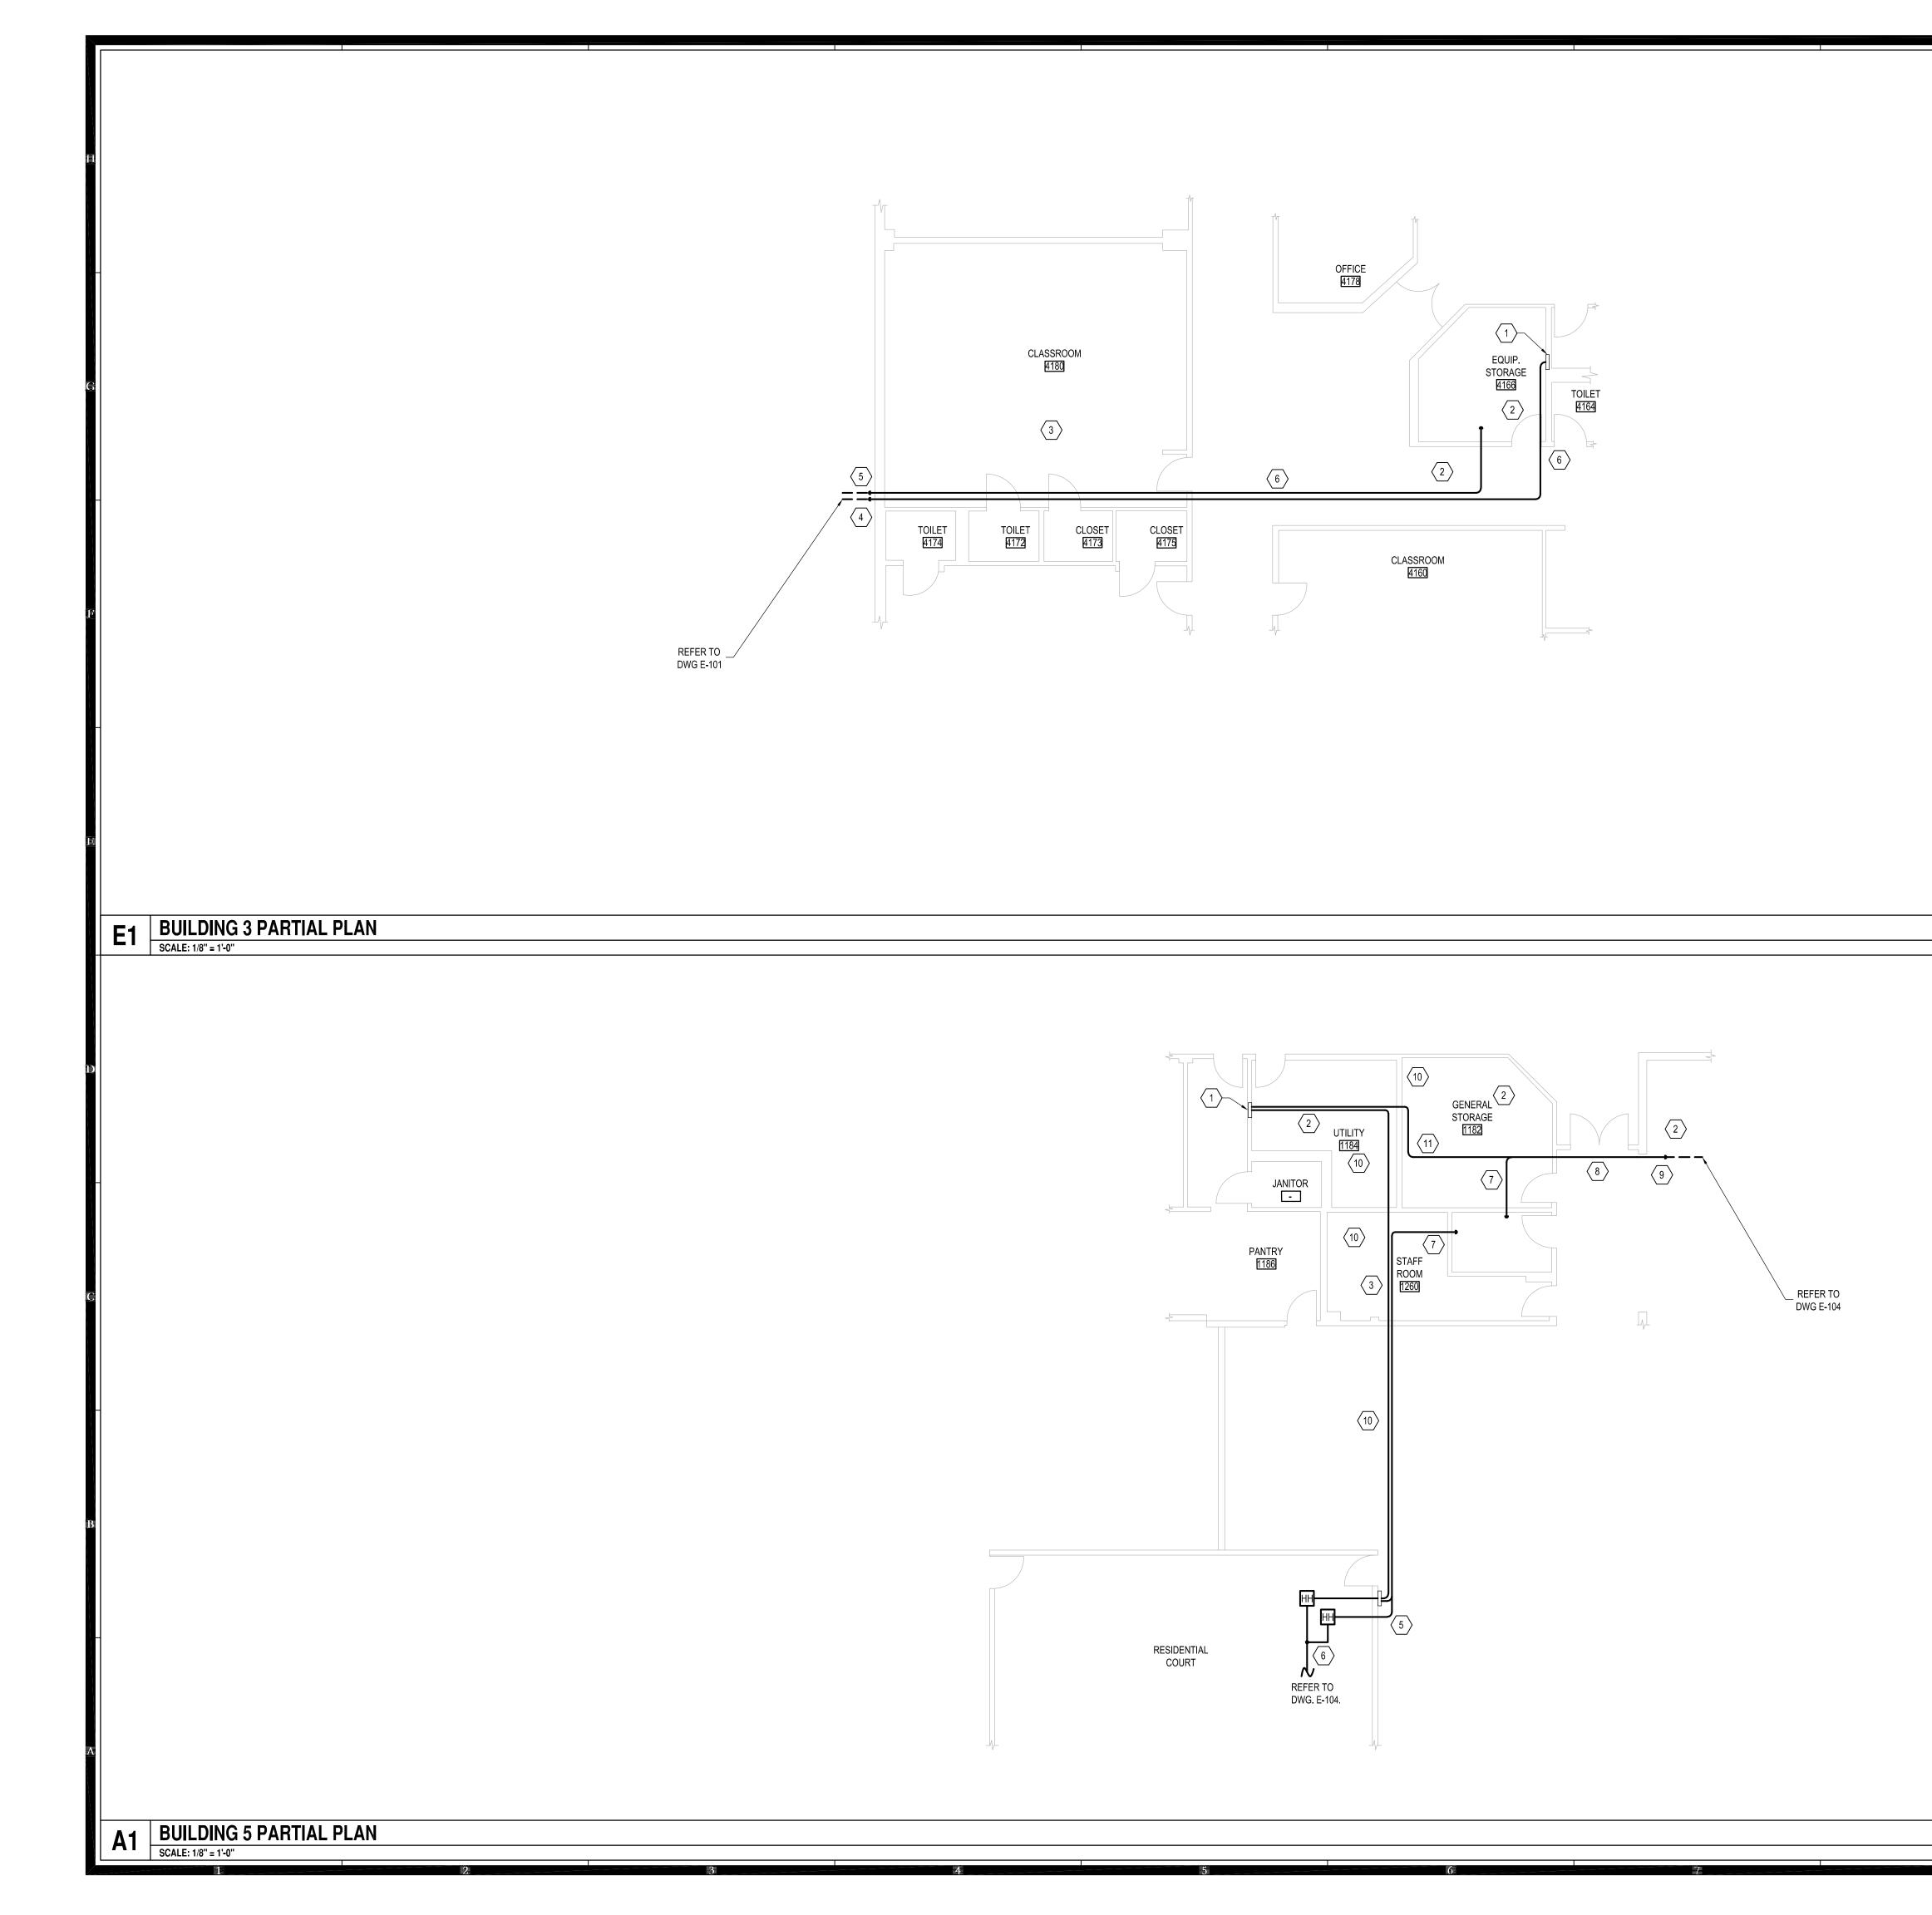
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		NEWYORK DASNY
KEYED NOTES: 1 EXISTING RECESSED SITE LIGHTING F 10KAIC CIRCUIT BREAKER FOR LIGHTI PANEL SQUARE D TYPE NQ. PROVIDE DIRECTORY. 2 EXISTING EMT CONDUIT ABOVE HARD SPARE) 2-#8 AWG, 1-#8 GND IN SPARE PANELS IN AREA TO ALLOW WORK. 3 EXISTING EMT CONDUITS ABOVE SPLINE 4 EXISTING 2-1" RGS CONDUITS BURIED 5 NEW 1-1" RGS CONDUIT BURIED TO NE ROOM TO ACCESSIBLE LOCATION.	NG CIRCUIT (1-208V CIRCUIT) UPDATED TYPED CIRCUIT CEILING. 2-1" CONDUITS. (1 CONDUIT. EXISTING ACCESS NE CEILING. 2-1" CONDUITS. TO HANDHOLE. EW 18"X18" HANDHOLE.	<text><text><text><text><text><text><text></text></text></text></text></text></text></text>
	NORTH	Project Key
	0 4' 8'	
 CONDUITS (SPARES). 4#8 AWG, 1#8 CONDUITS (SPARES). 4#8 AWG, 1#8 CONDUITS DOWN WALL, CORE IN EXIT BUILDING. CONDUITS OUTSIDE SCHEDULE 80, PVC, 2-1" CONDUITS (SPARES) 4#8 AWG, 1#8 AWG GND IN CONDUITS (SPARES) TO DATA 	ATING CIRCUITS (2-208V CIRCUITS). DIRECTORY. . 1-1" CONDUIT AND 1-3" CONDUIT VE CONDUIT. EXISTING ACCESS FERMINATE SPARE NEAR ACCESS 9, 2-1" CONDUITS (1 SPARE) AND 2-2" GND IN ACTIVE CONDUIT. ACCESS 6, 2-1" CONDUITS (1 SPARE) AND 2-2" GND IN ACTIVE CONDUIT. ORILL WALL 12" AFF AND USE LB'S TO TO HANDHOLES SHALL BE RGS. 1 SPARE) AND 2-2" CONDUITS ACTIVE CONDUIT. A CLOSET. IT TO EXISTING CONDUIT. CORE DRILL PENING WATER TIGHT. IED CONDUIT TO HANDHOLES. RE RATED. PROVIDE FIRE SEALANTS FICATIONS. , 1-3" CONDUIT (SPARE). TERMINATE ING.	REVISIONS Rev No Description Date: <
NORTH		Drawing Title PARTIAL ELECTRICAL PLANS Phase BID DOCUMENTS Drawn By: AMK JLR Date: 9/20/2024 Dasny Project No: 354360 Drawing Number Logic Signature Date: 9/20/2024 Dasny Project No: 354360 Drawing Number Logic Signature Date: 9/20/2024 Dasny Project No: 354360 Drawing Number Logic Signature Date: 9/20/2024 Dasny Project No: 354360 Drawing Number