
## GENERAL BROWN CSD

## JUNIOR SENIOR HIGH SCHOOL 17643 CEMETERY RD

ARCHITECT'S PROJECT NO.2023-105

SED NO.22-04-01-04-0-003-011

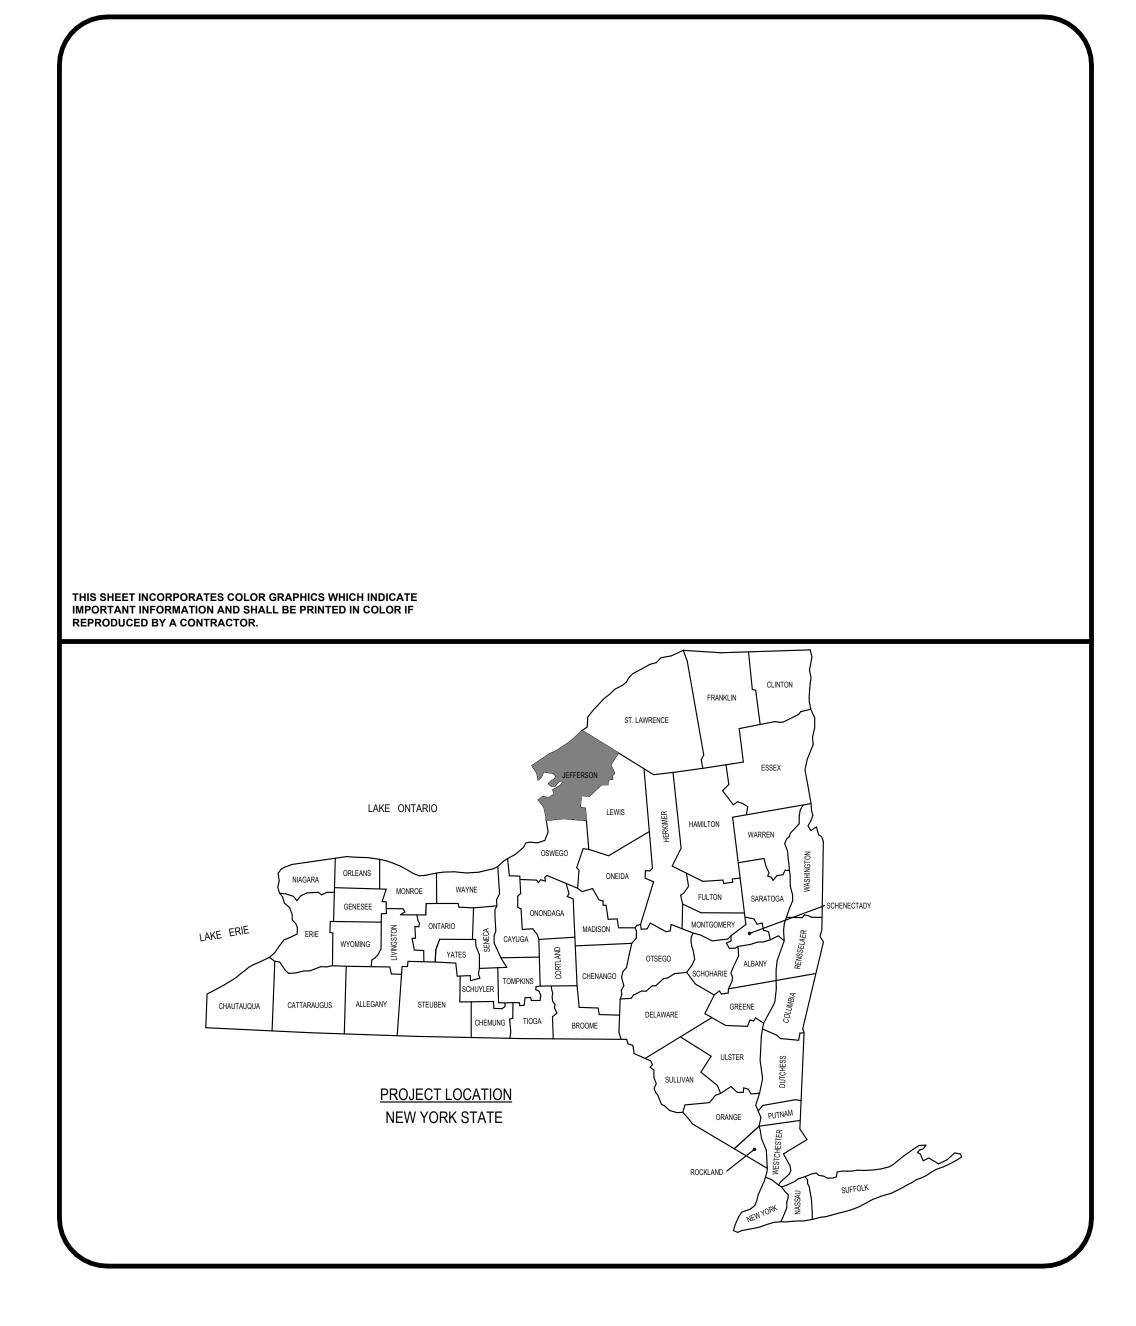

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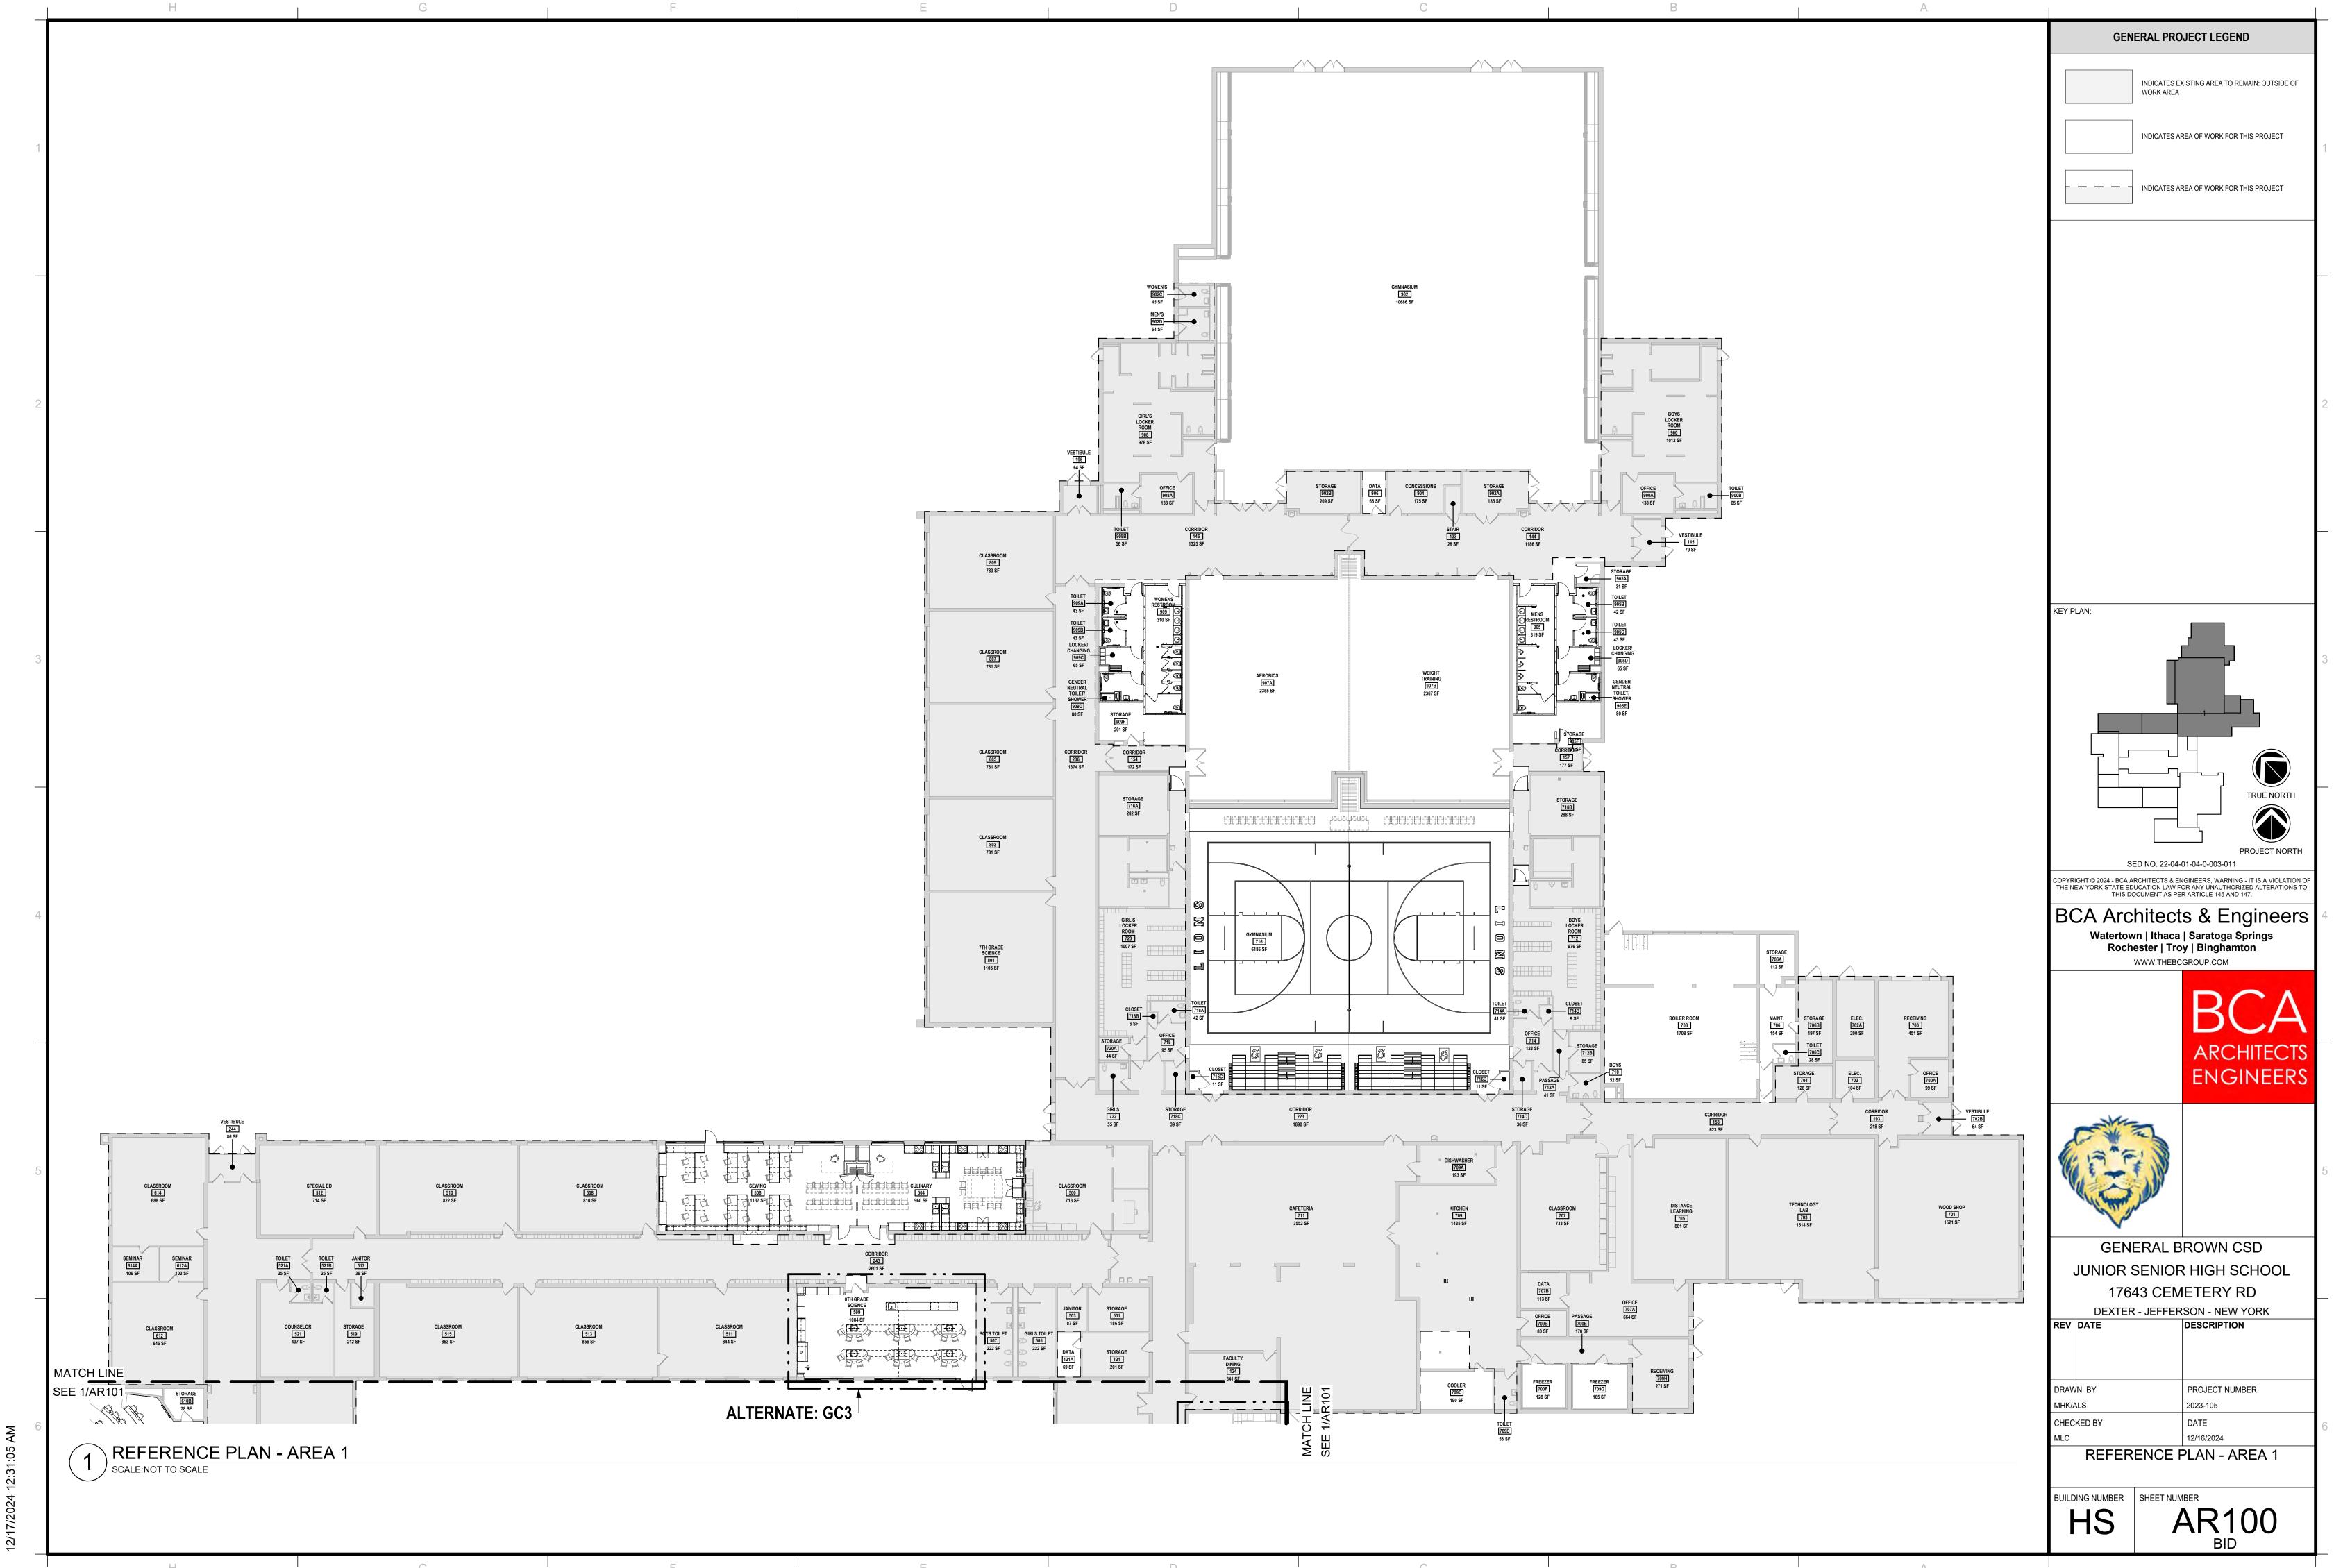
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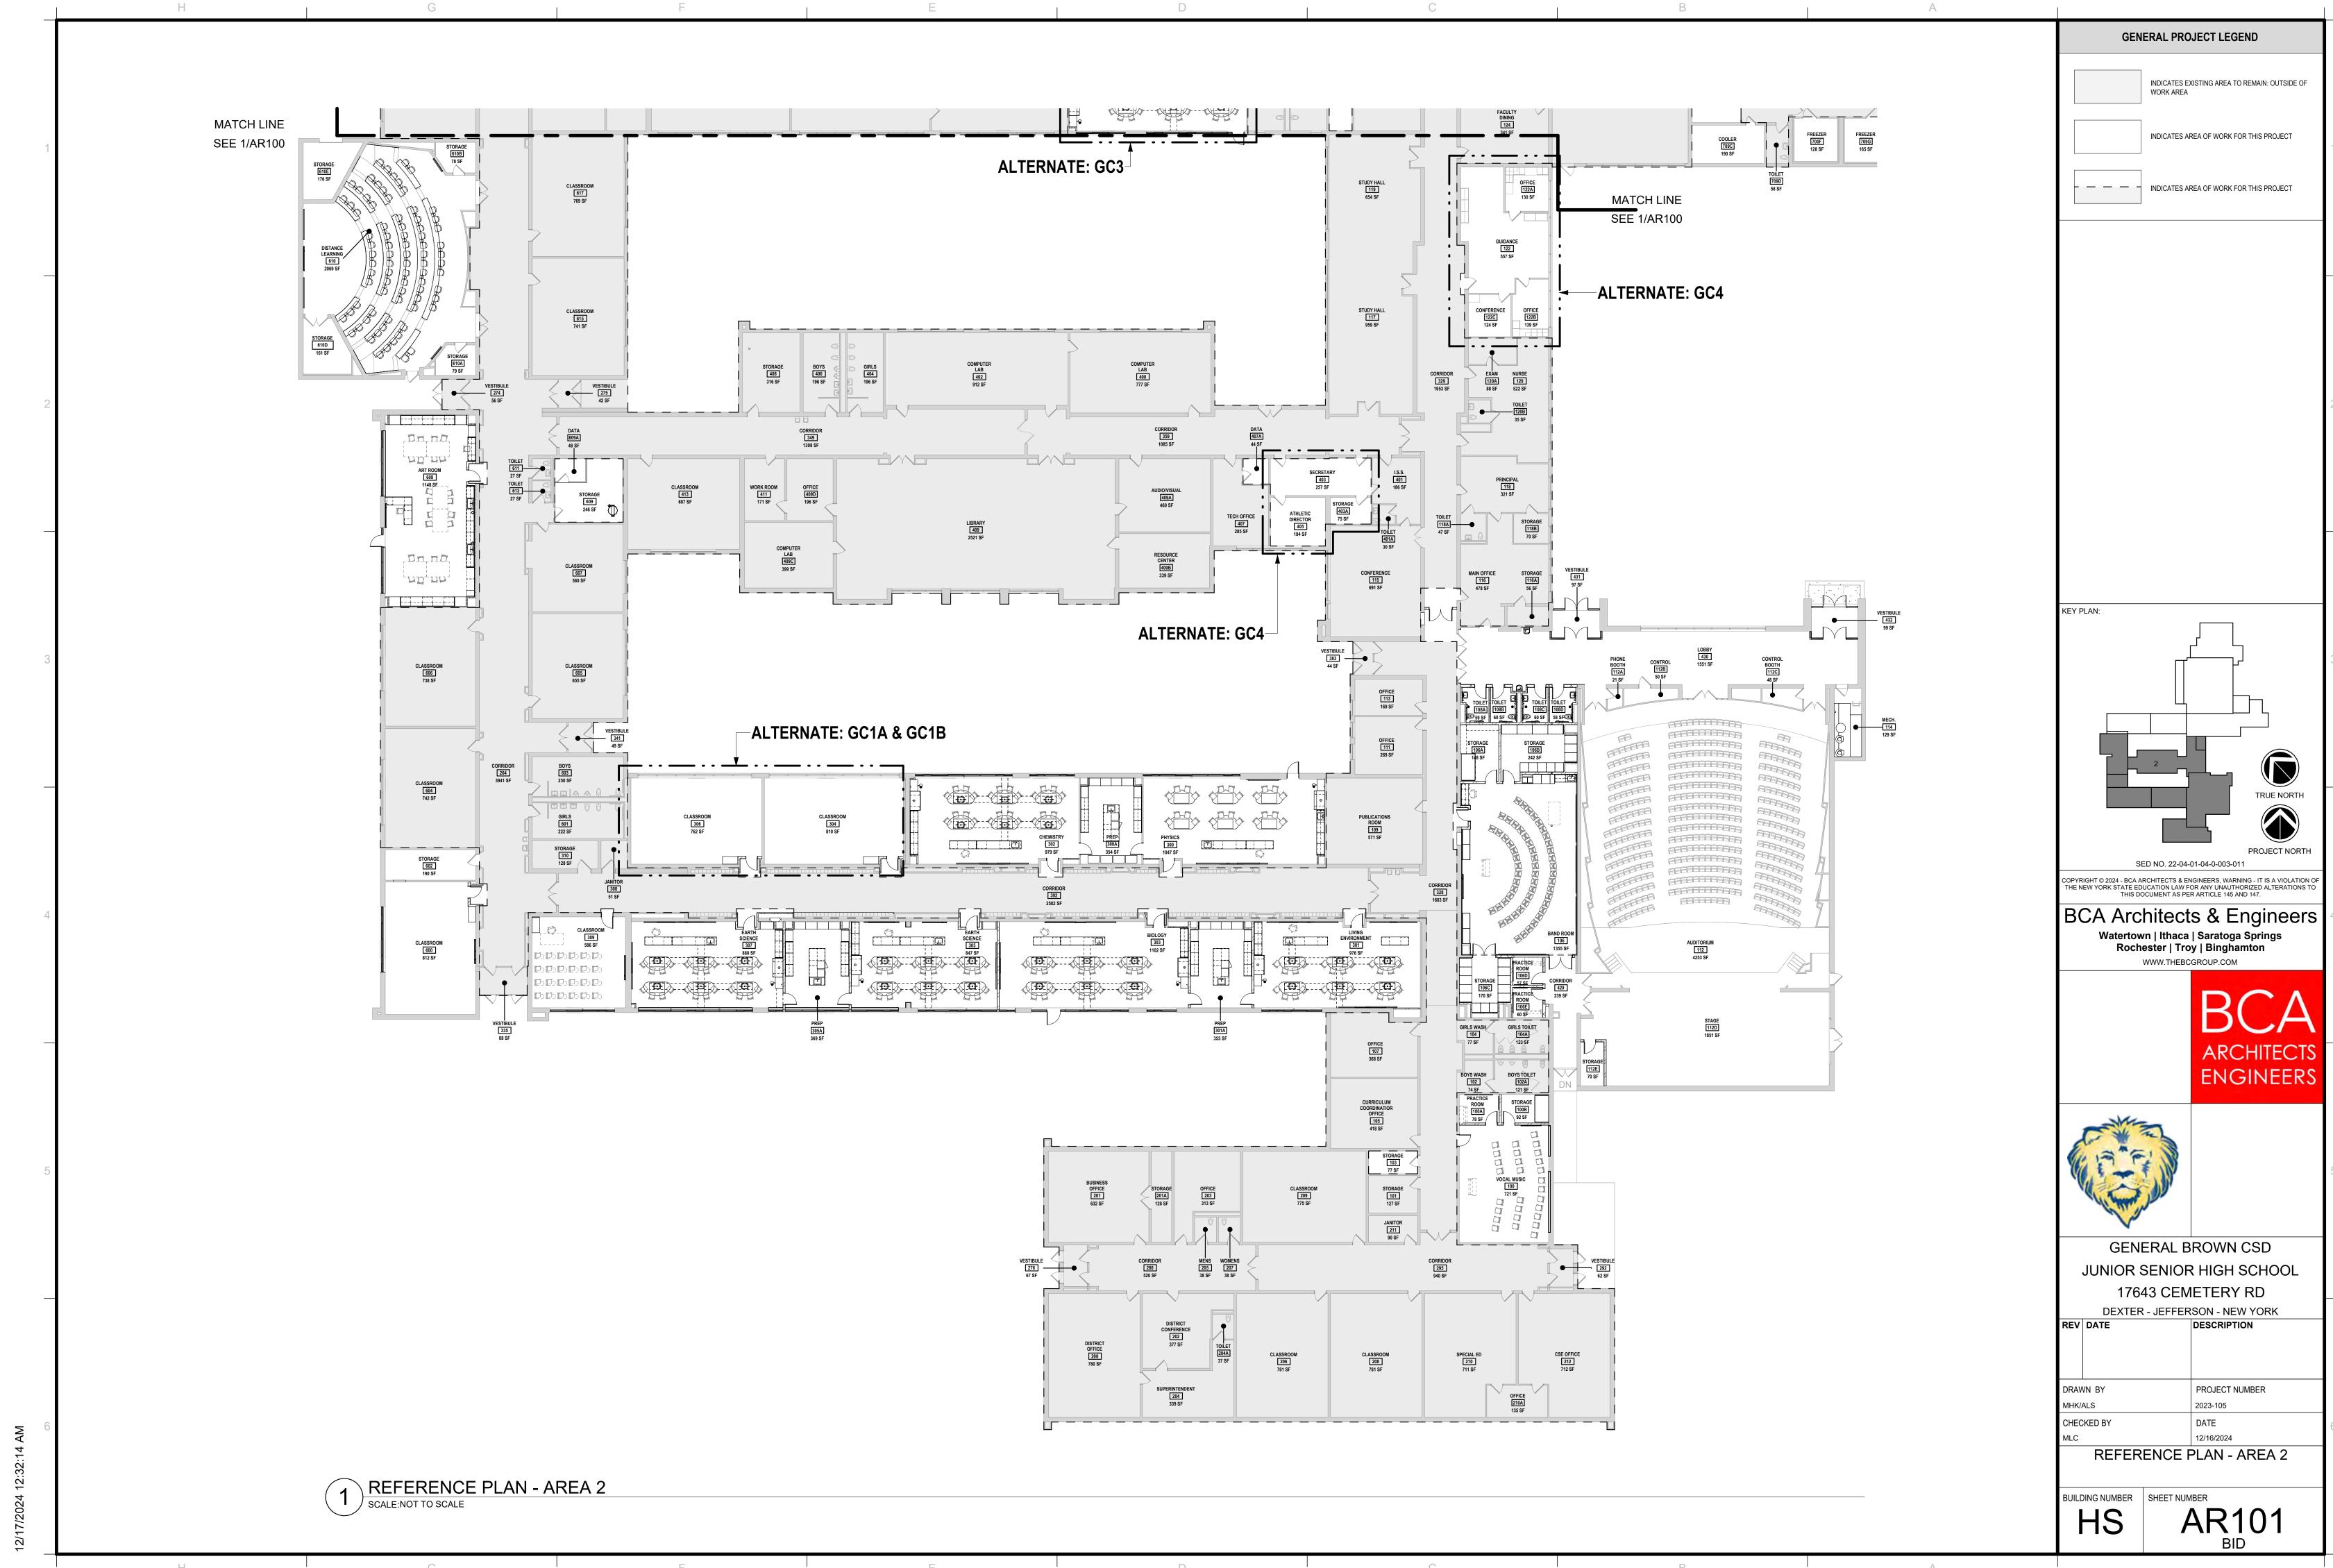
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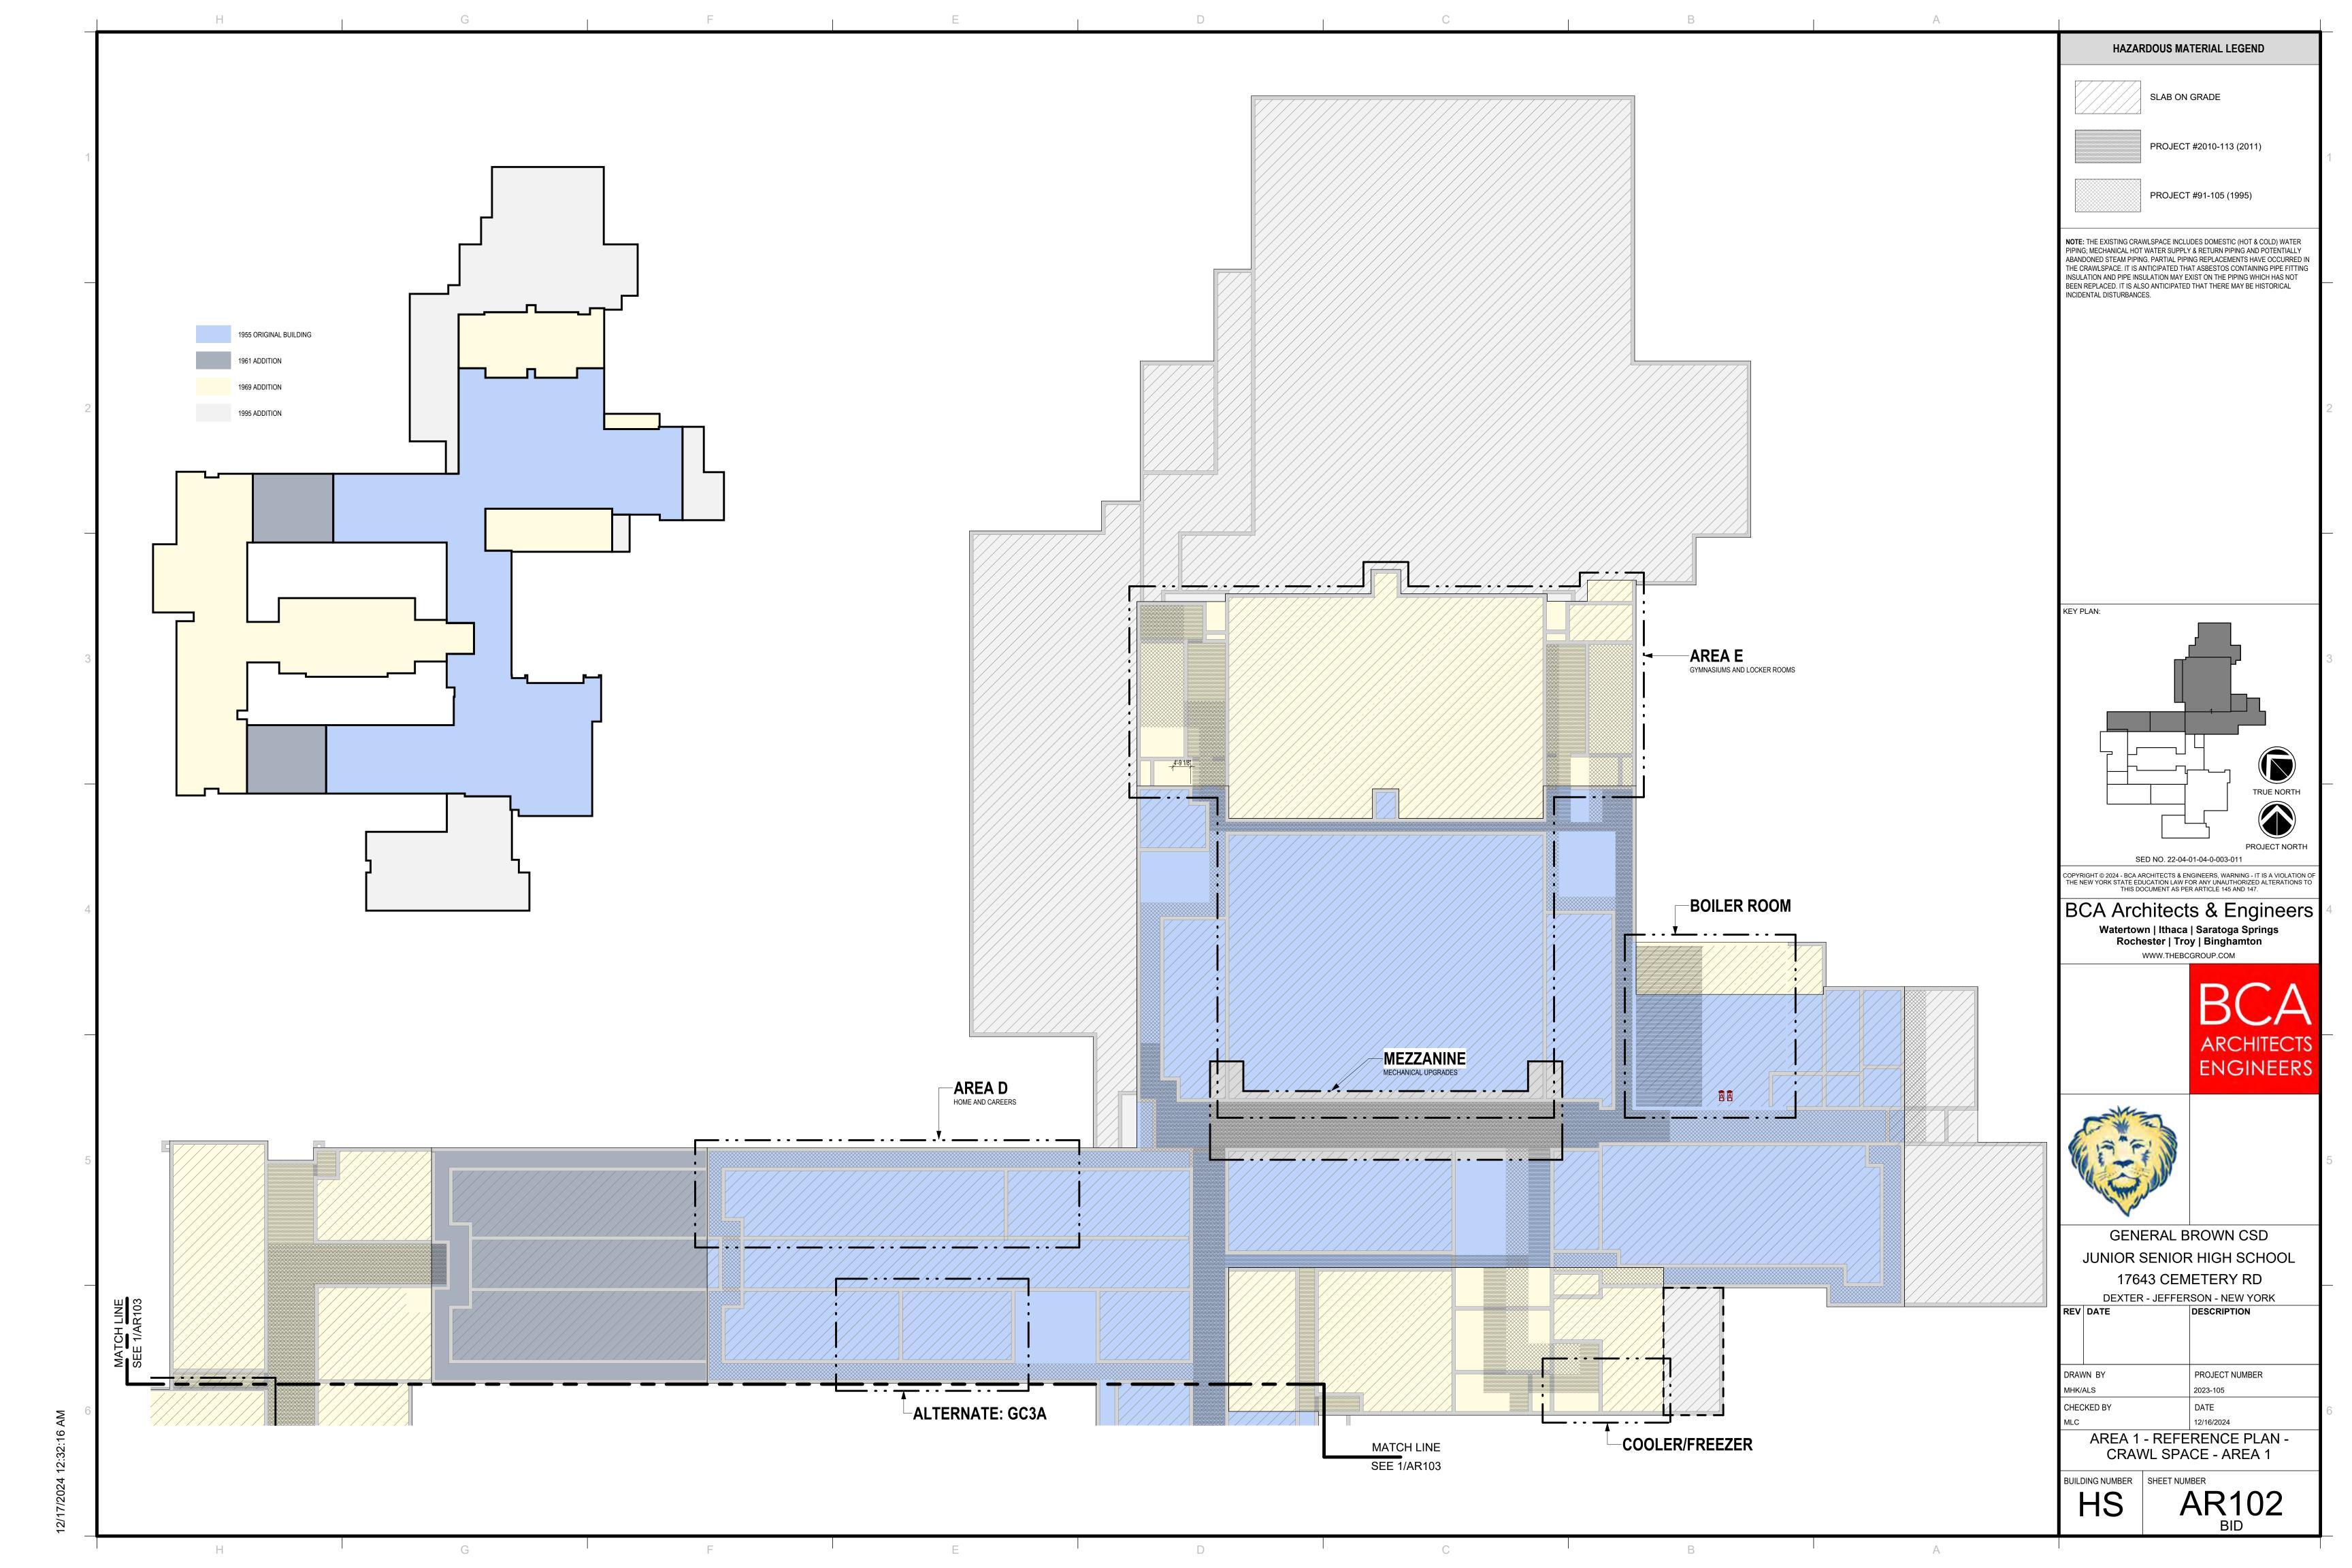
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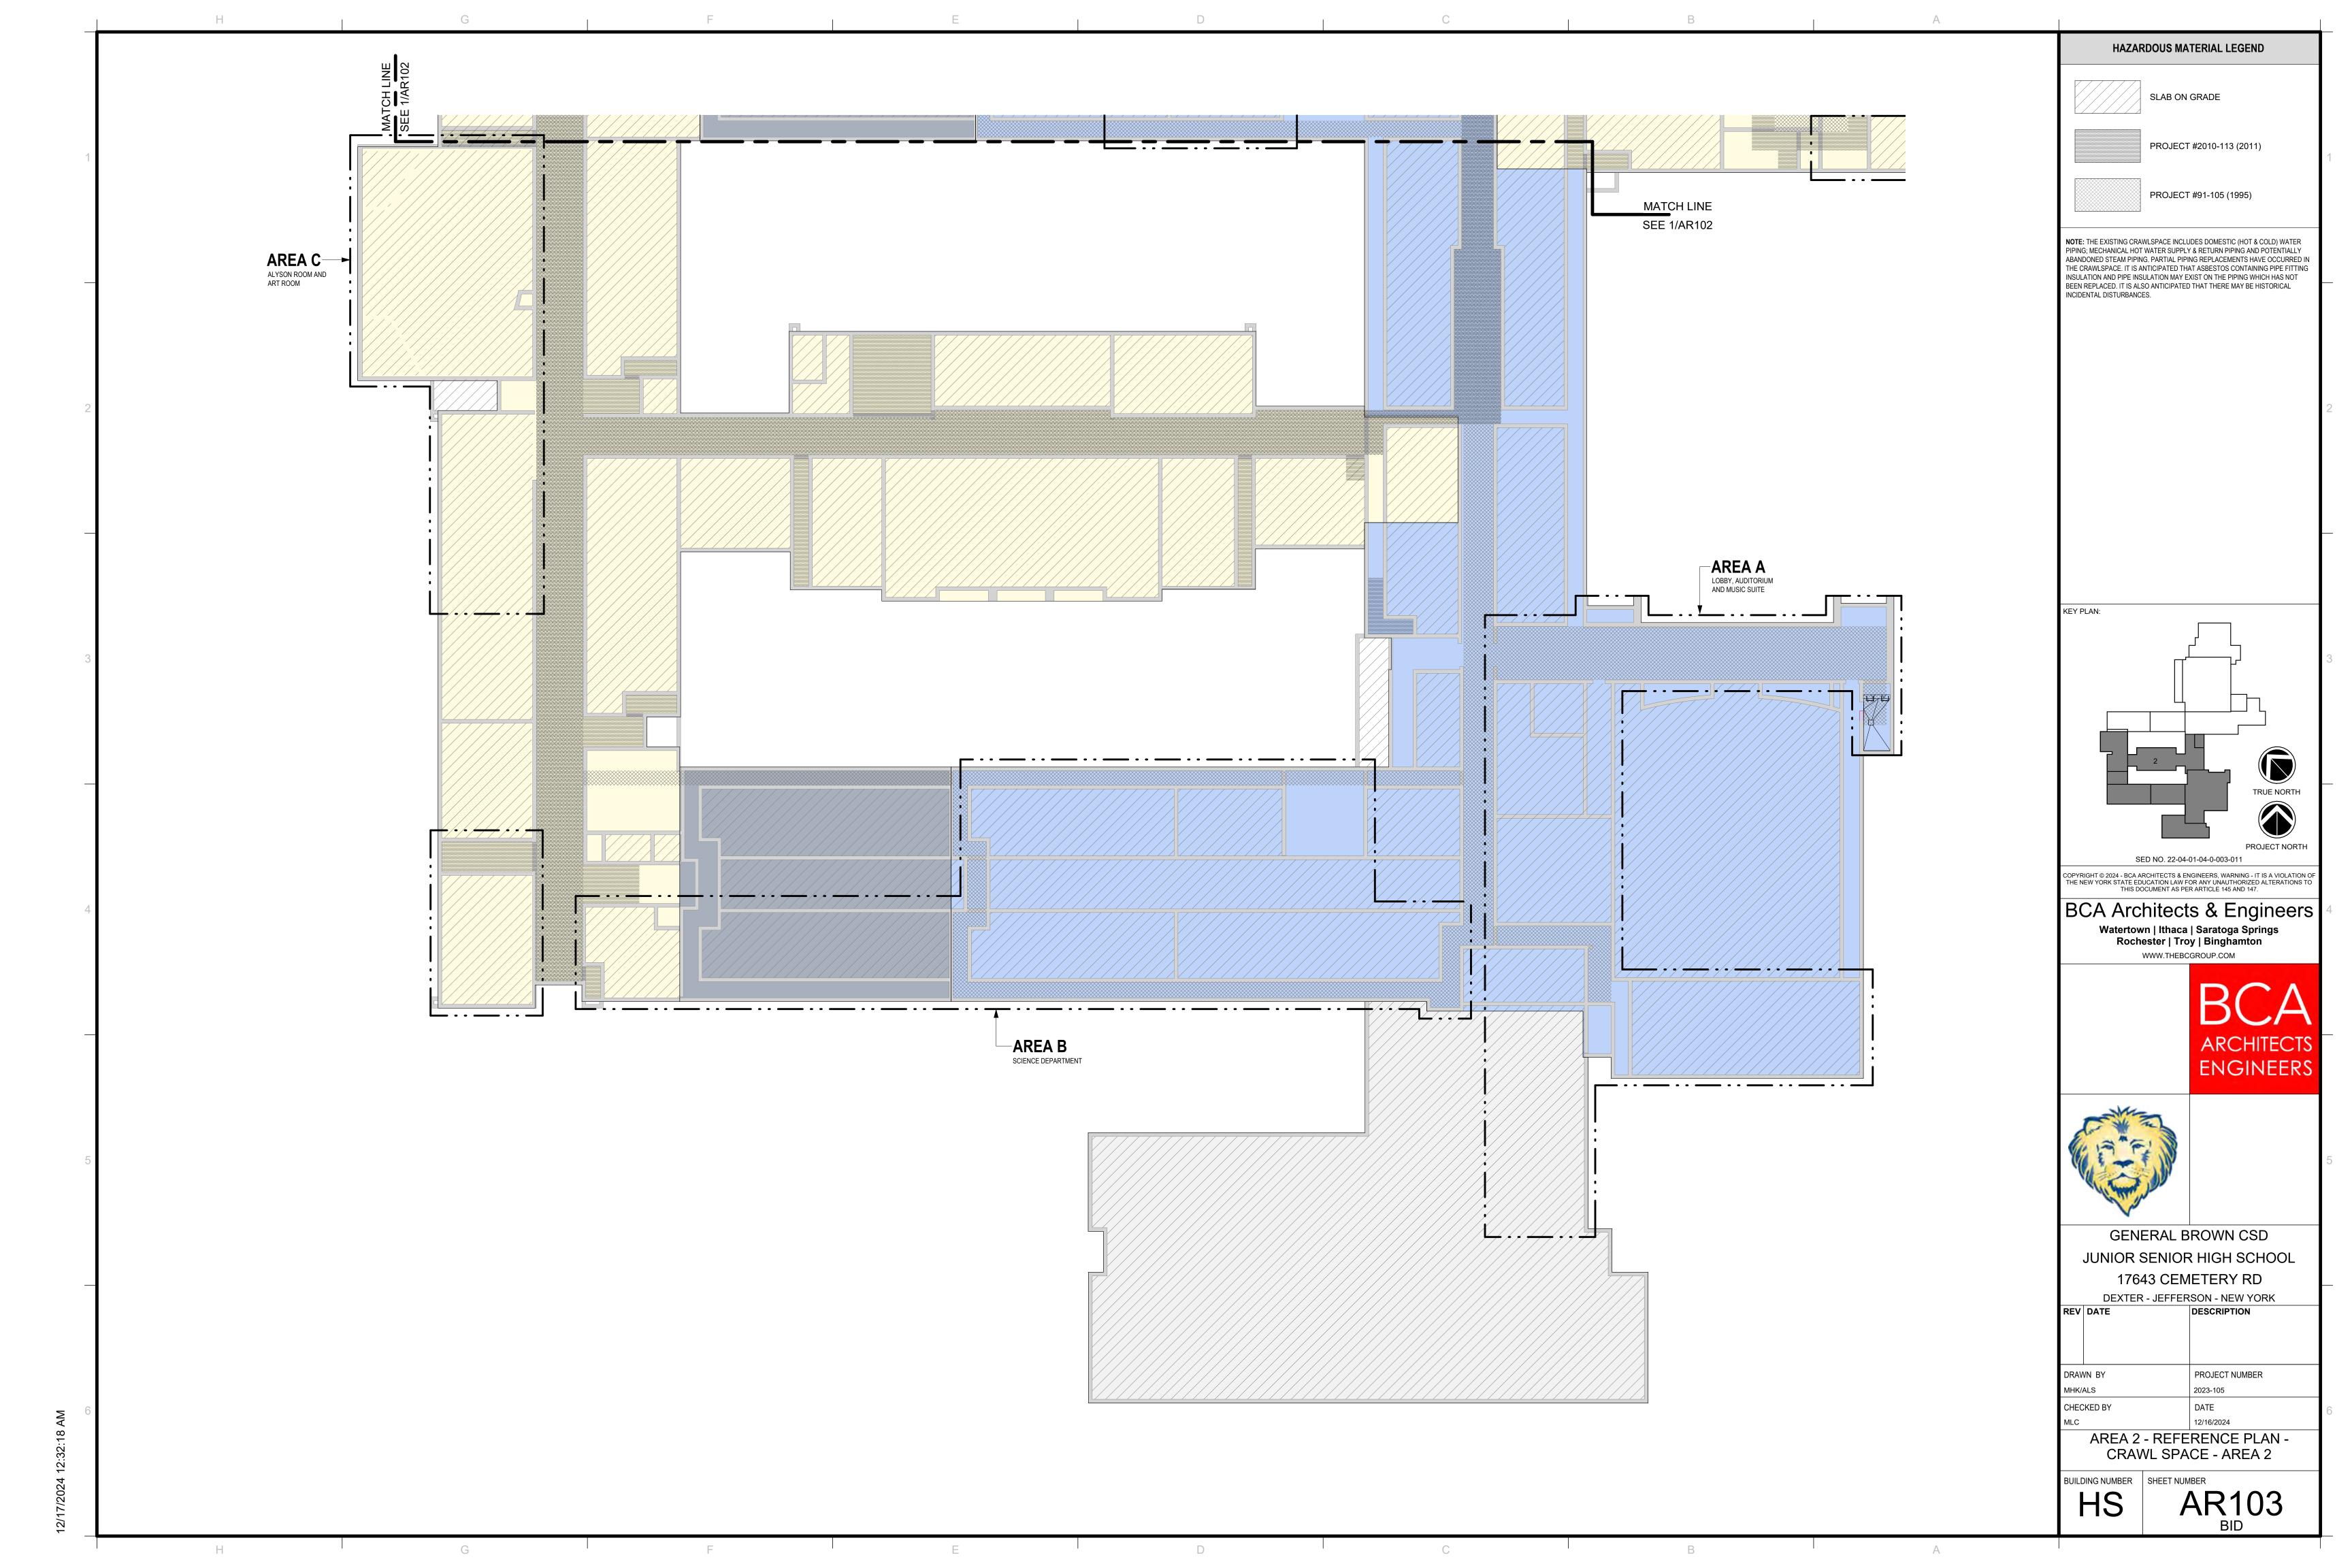
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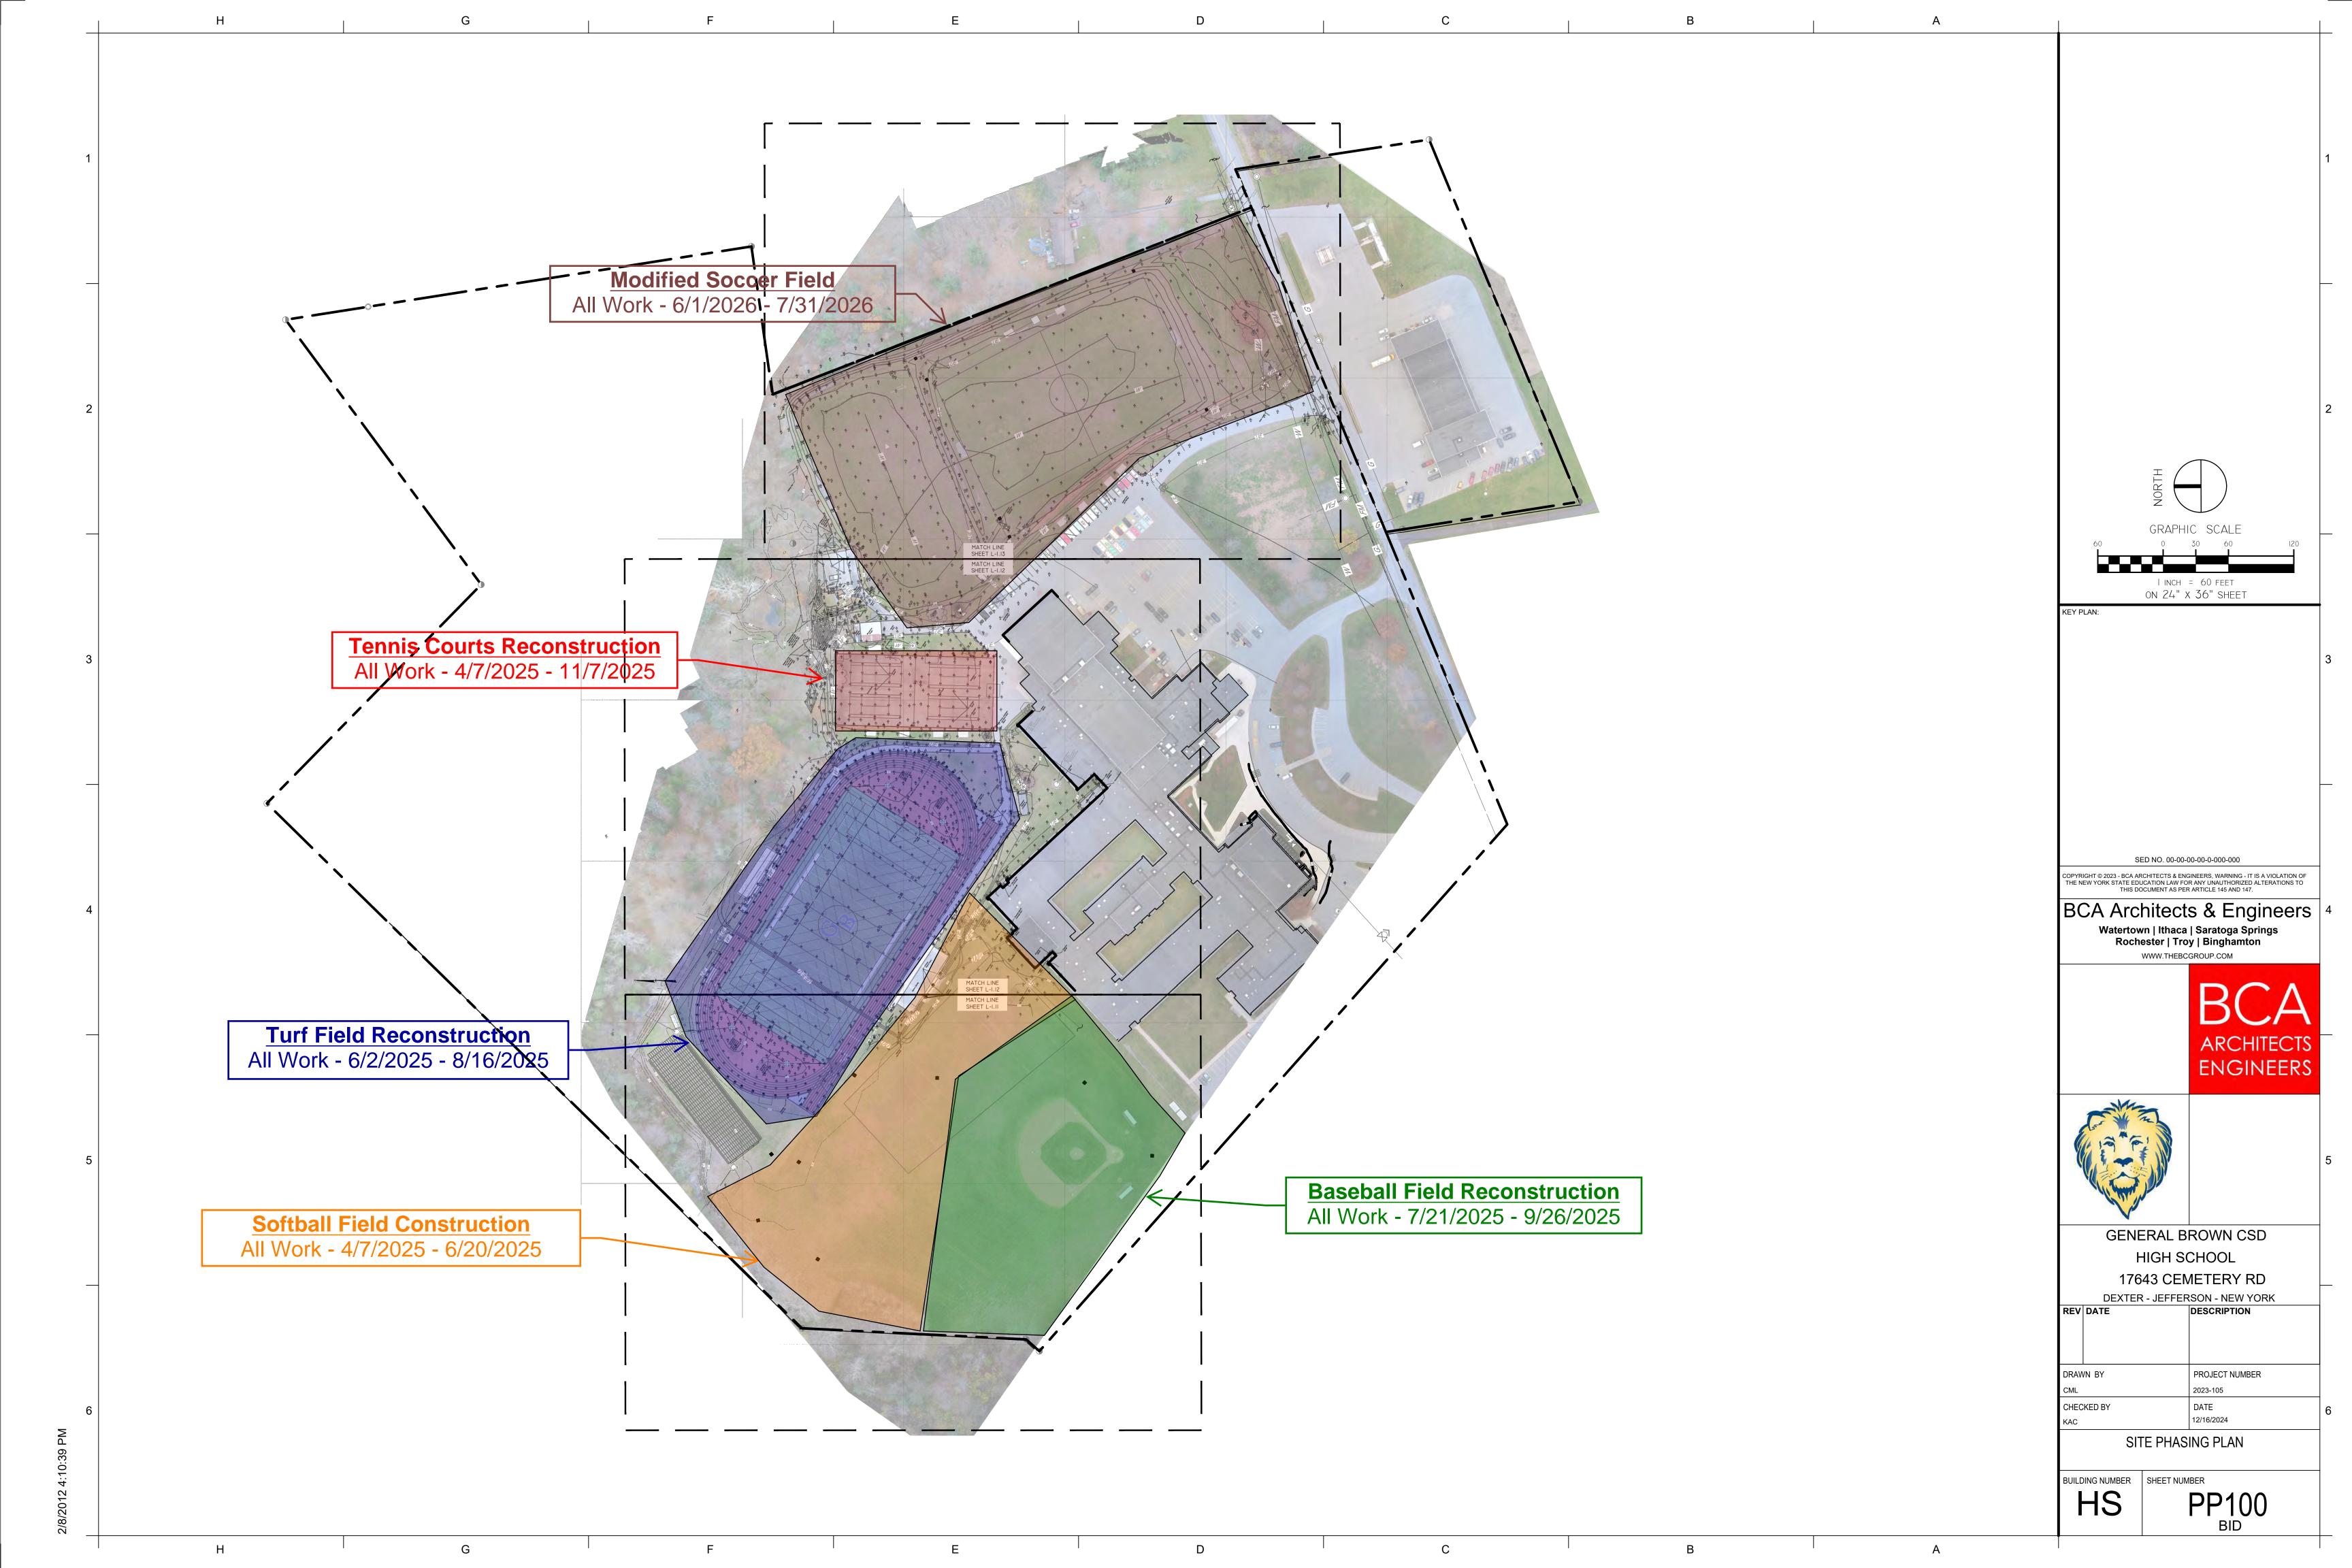
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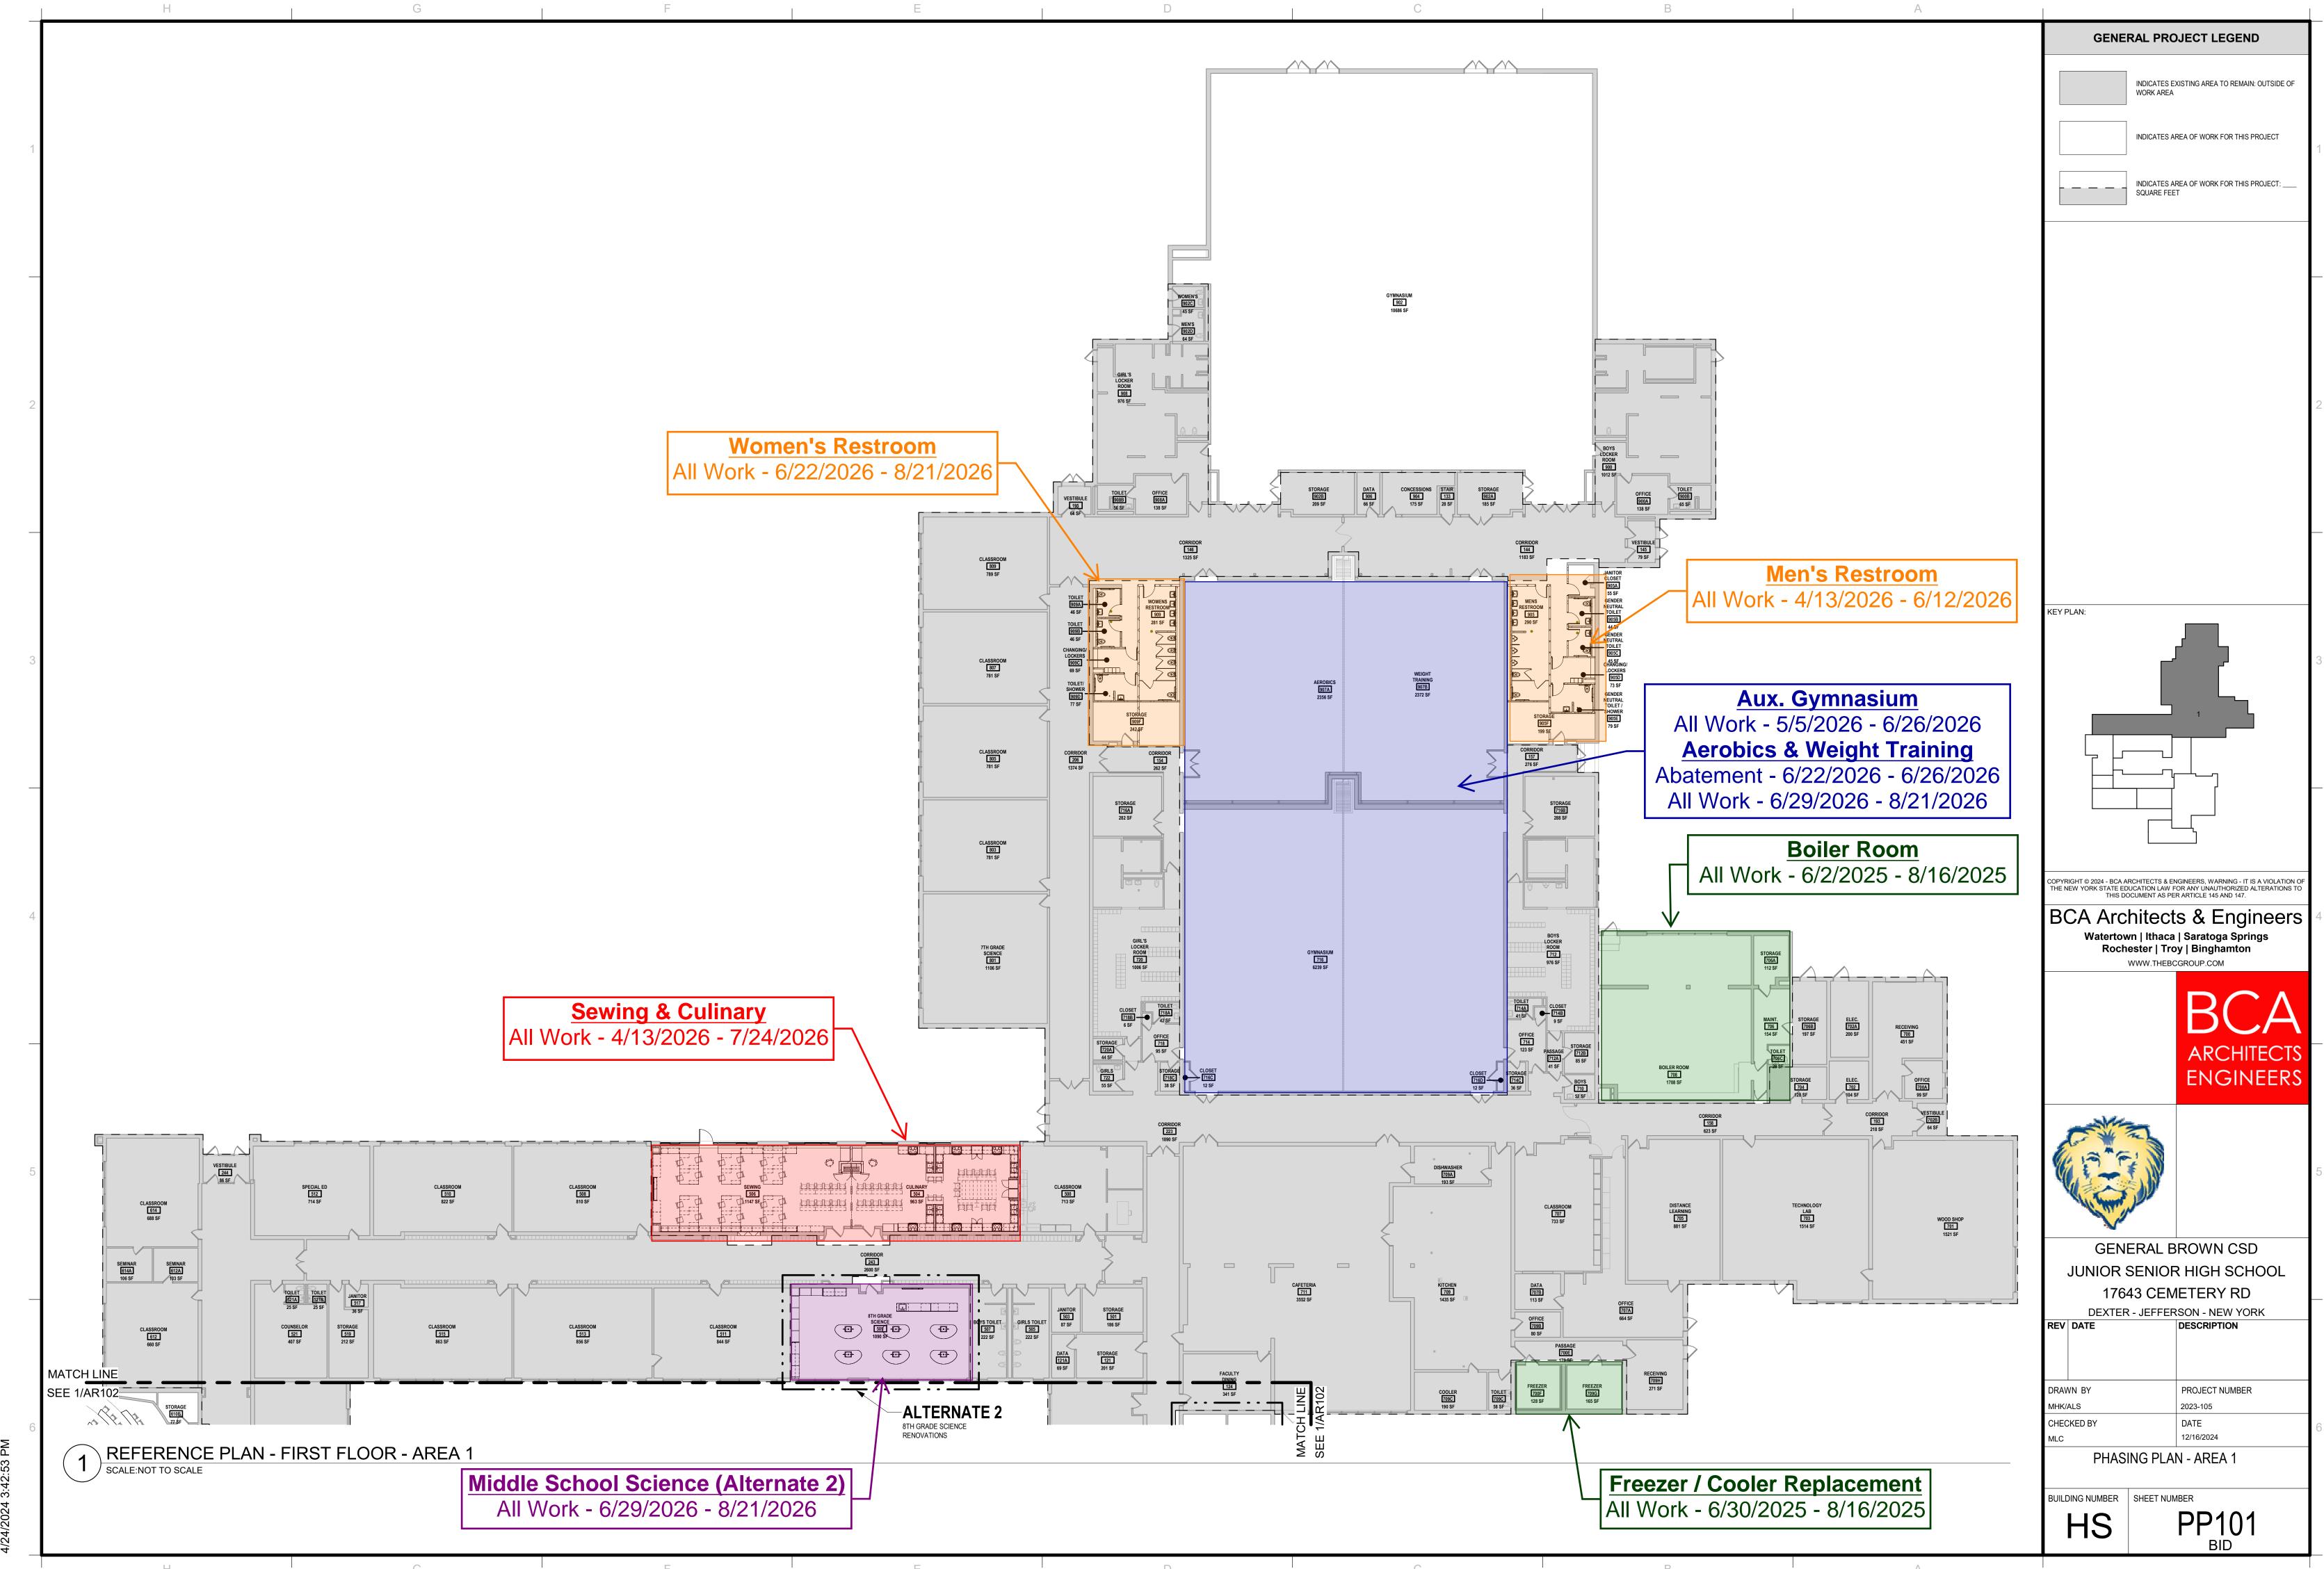
















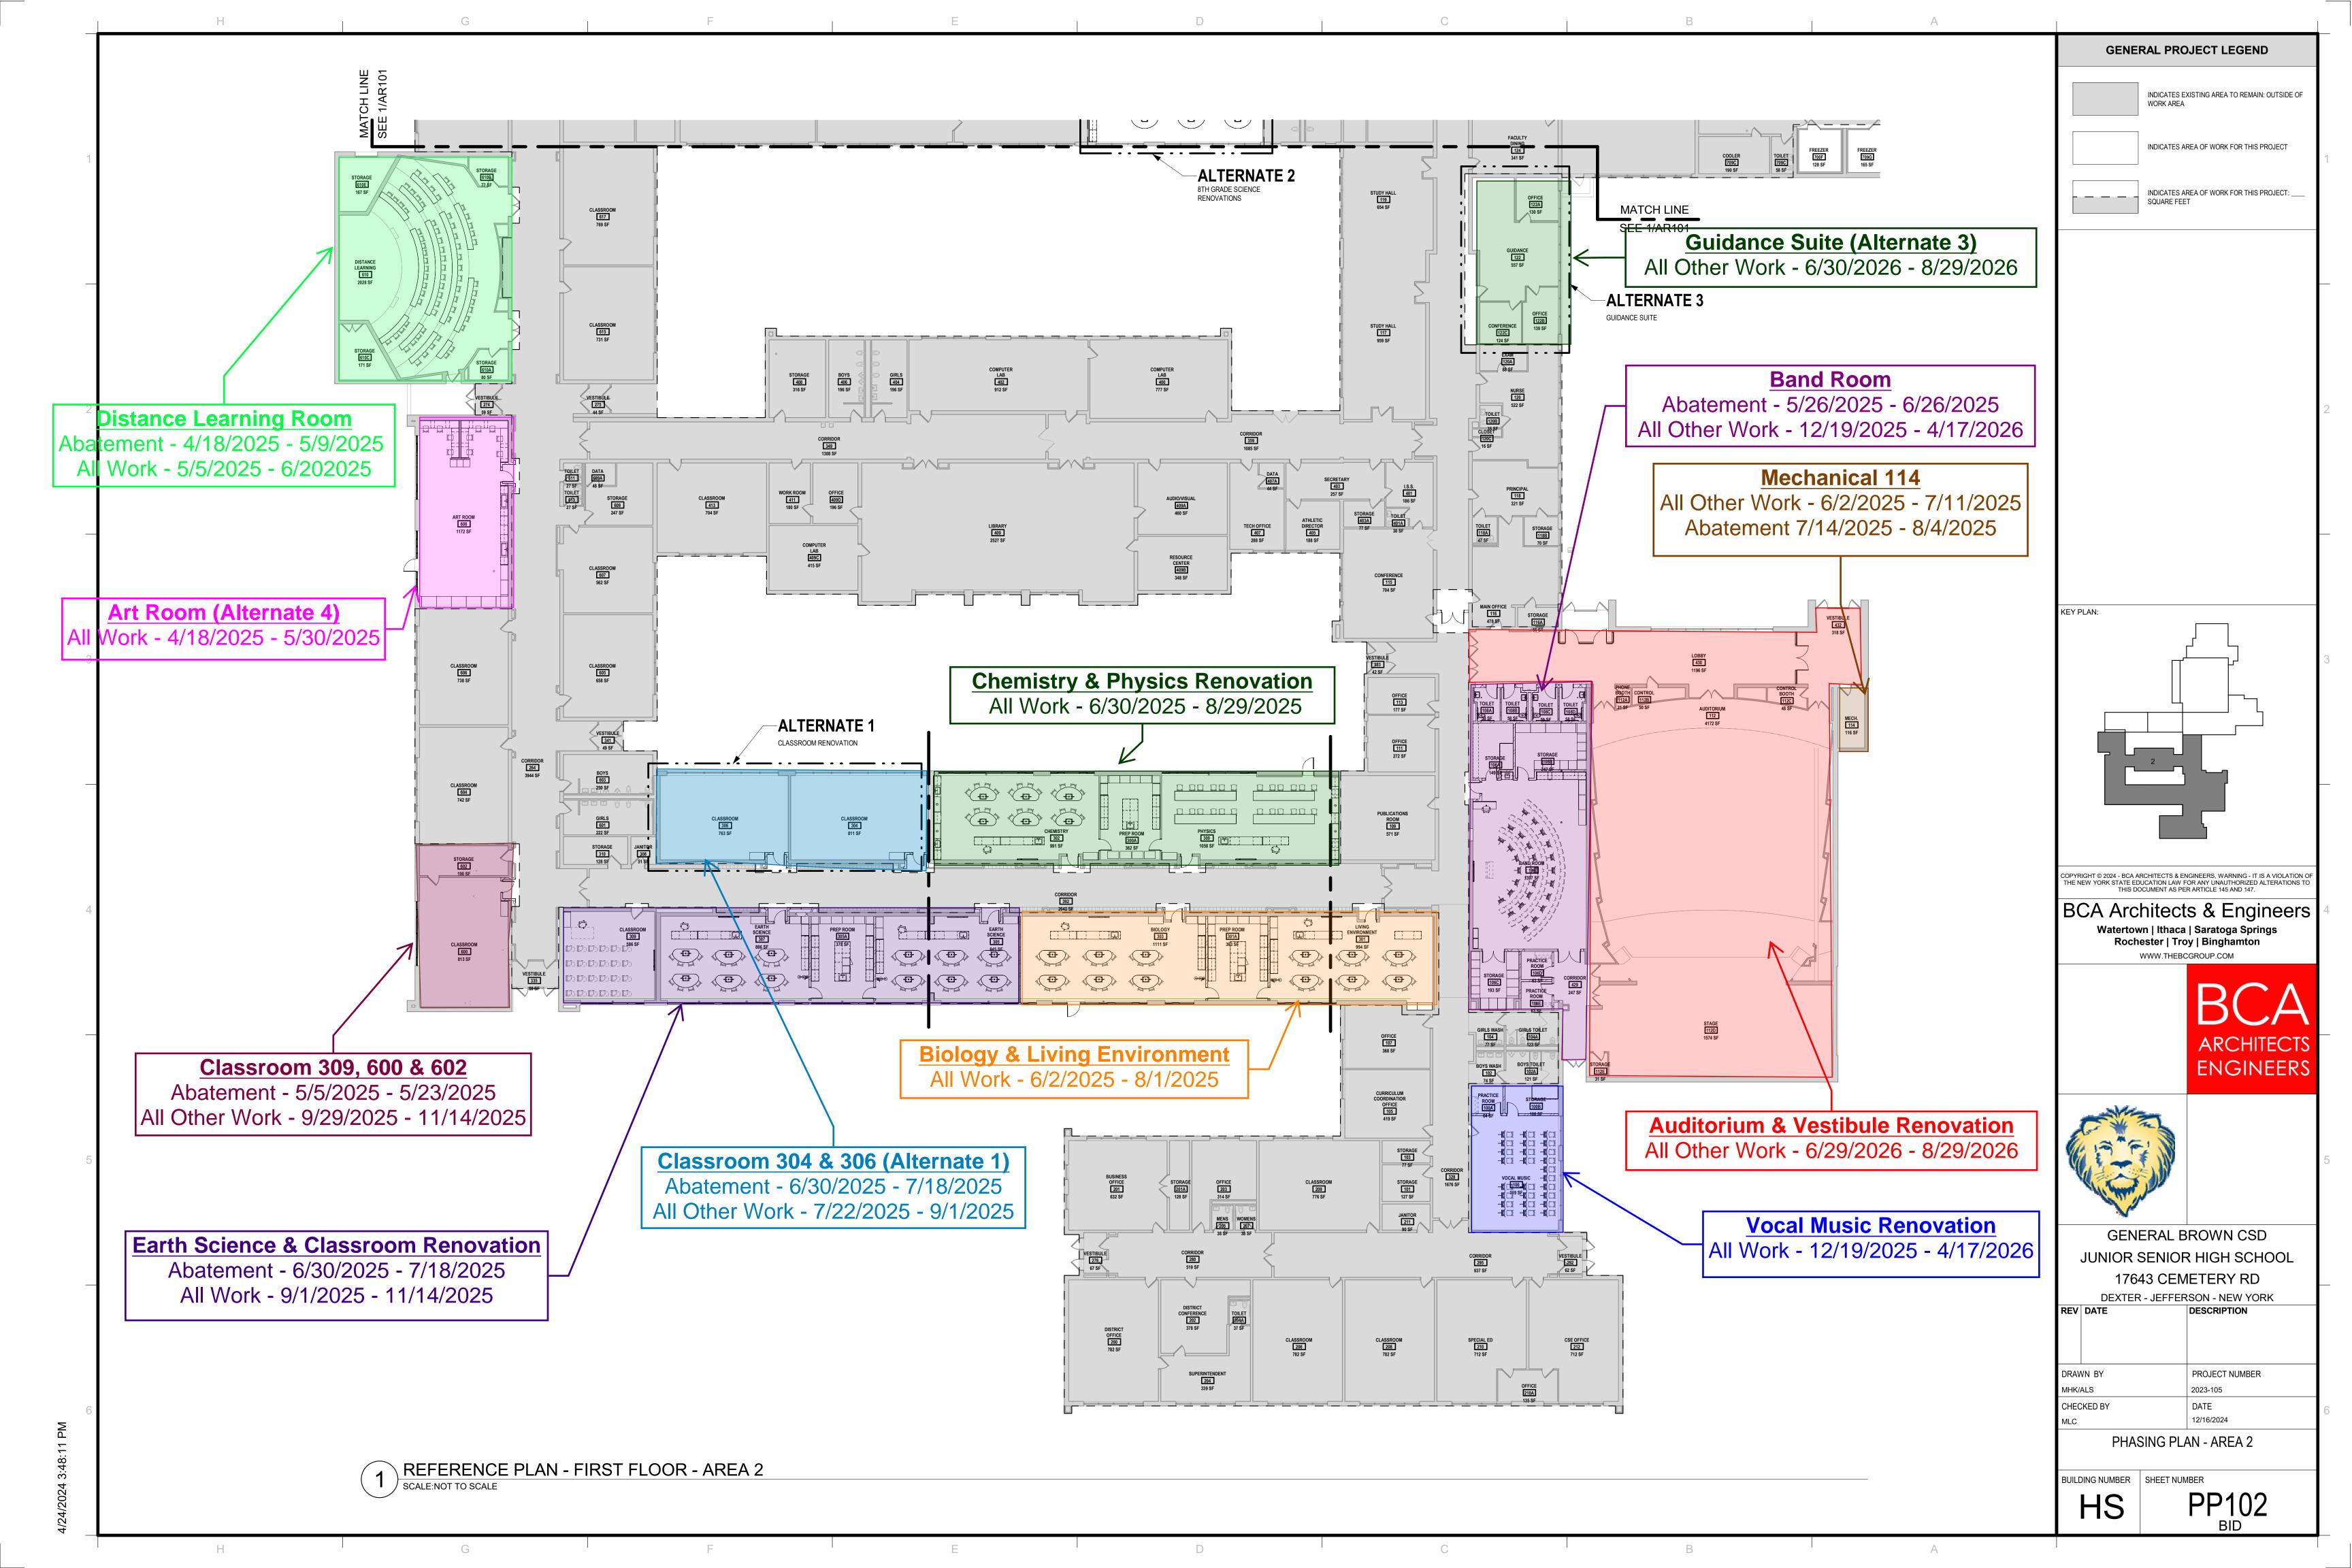





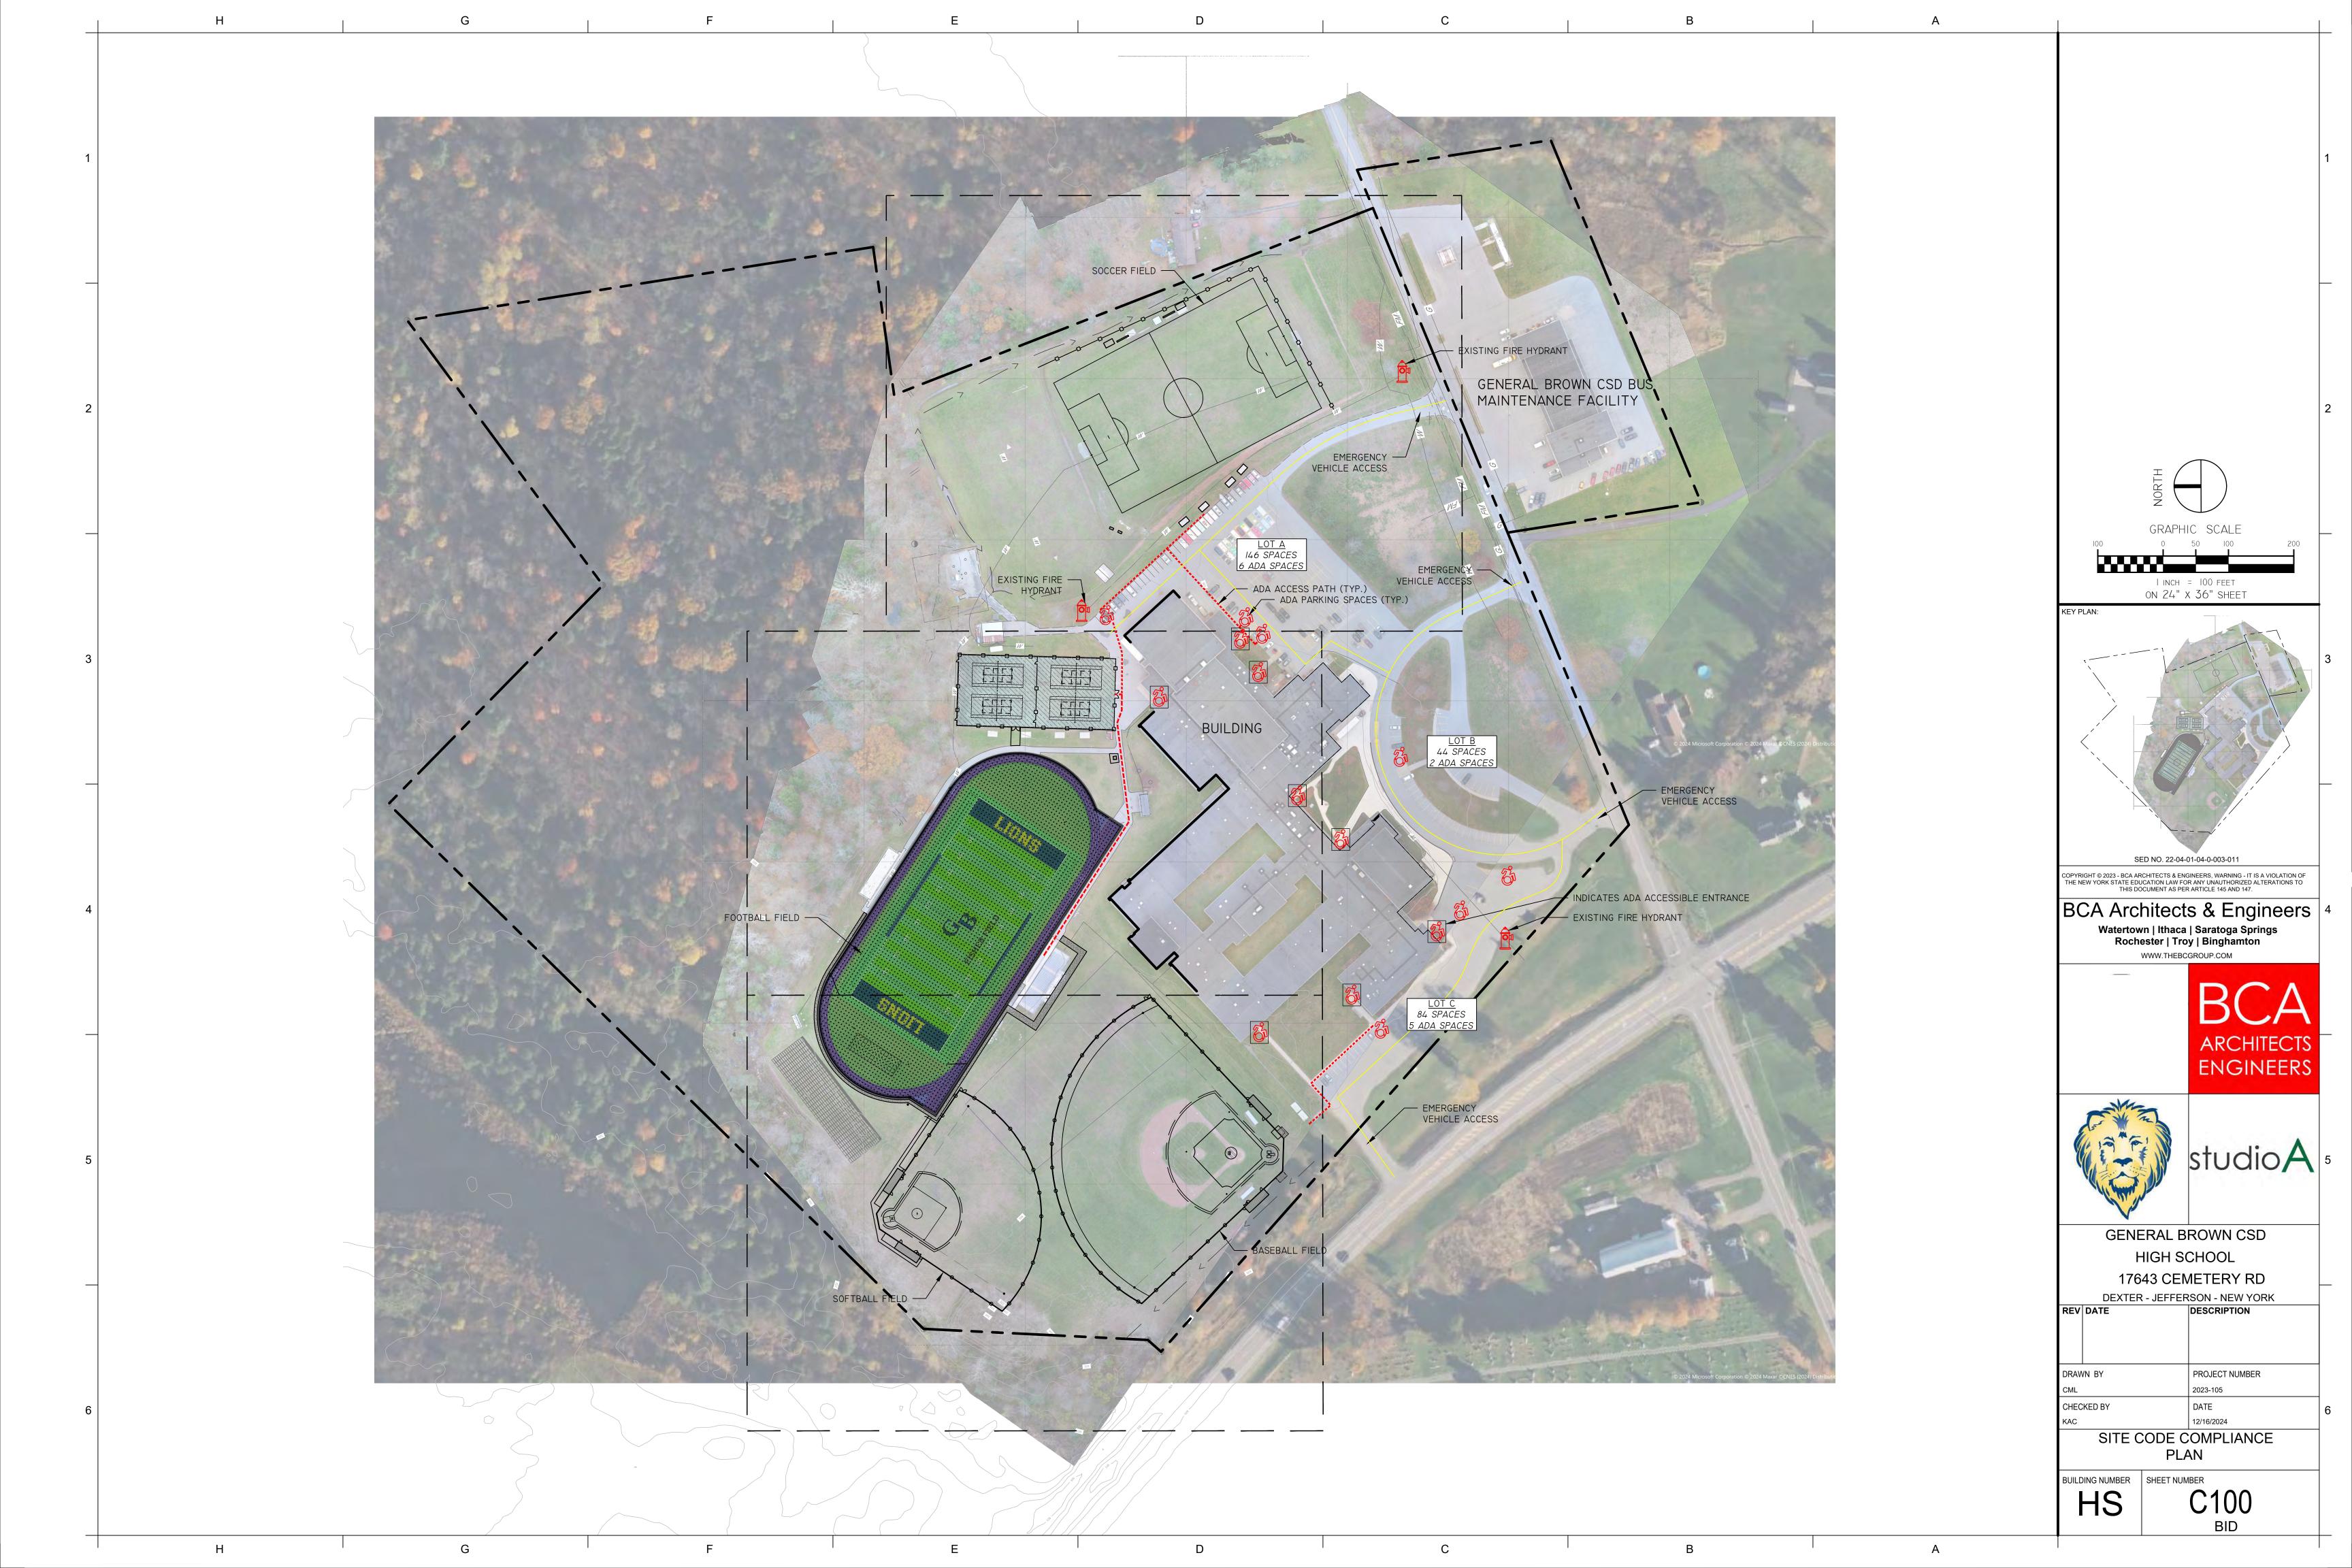

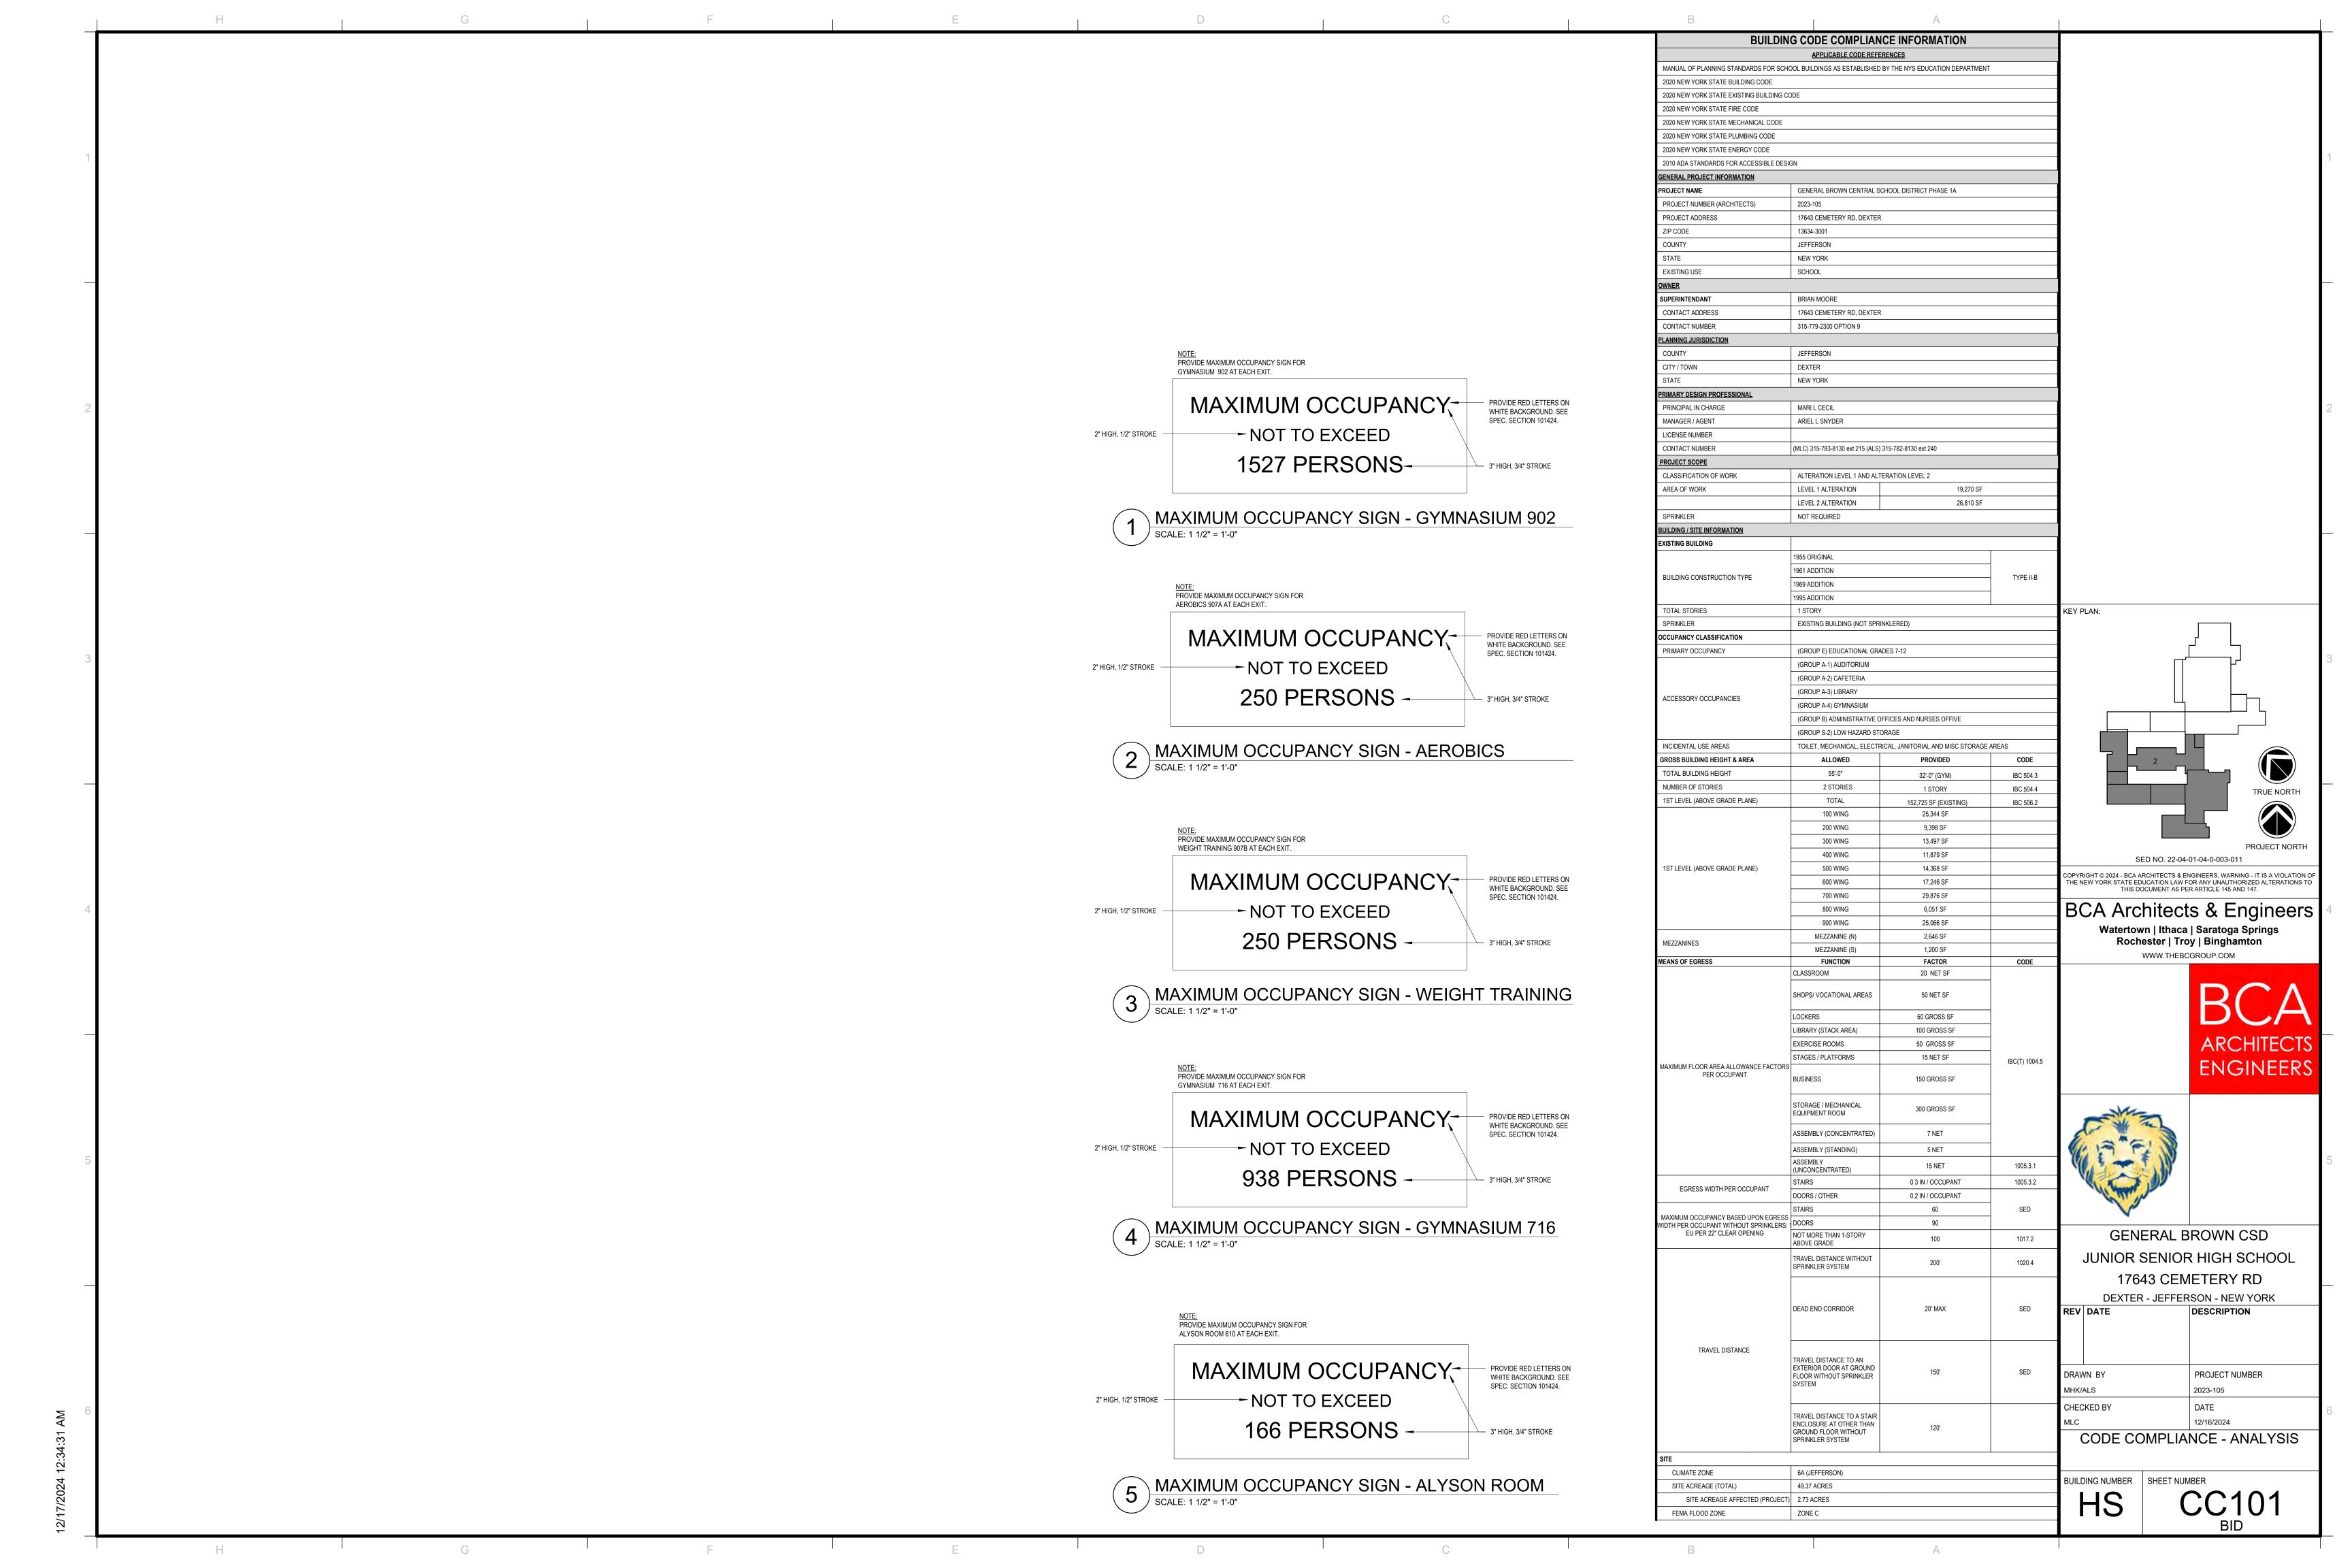


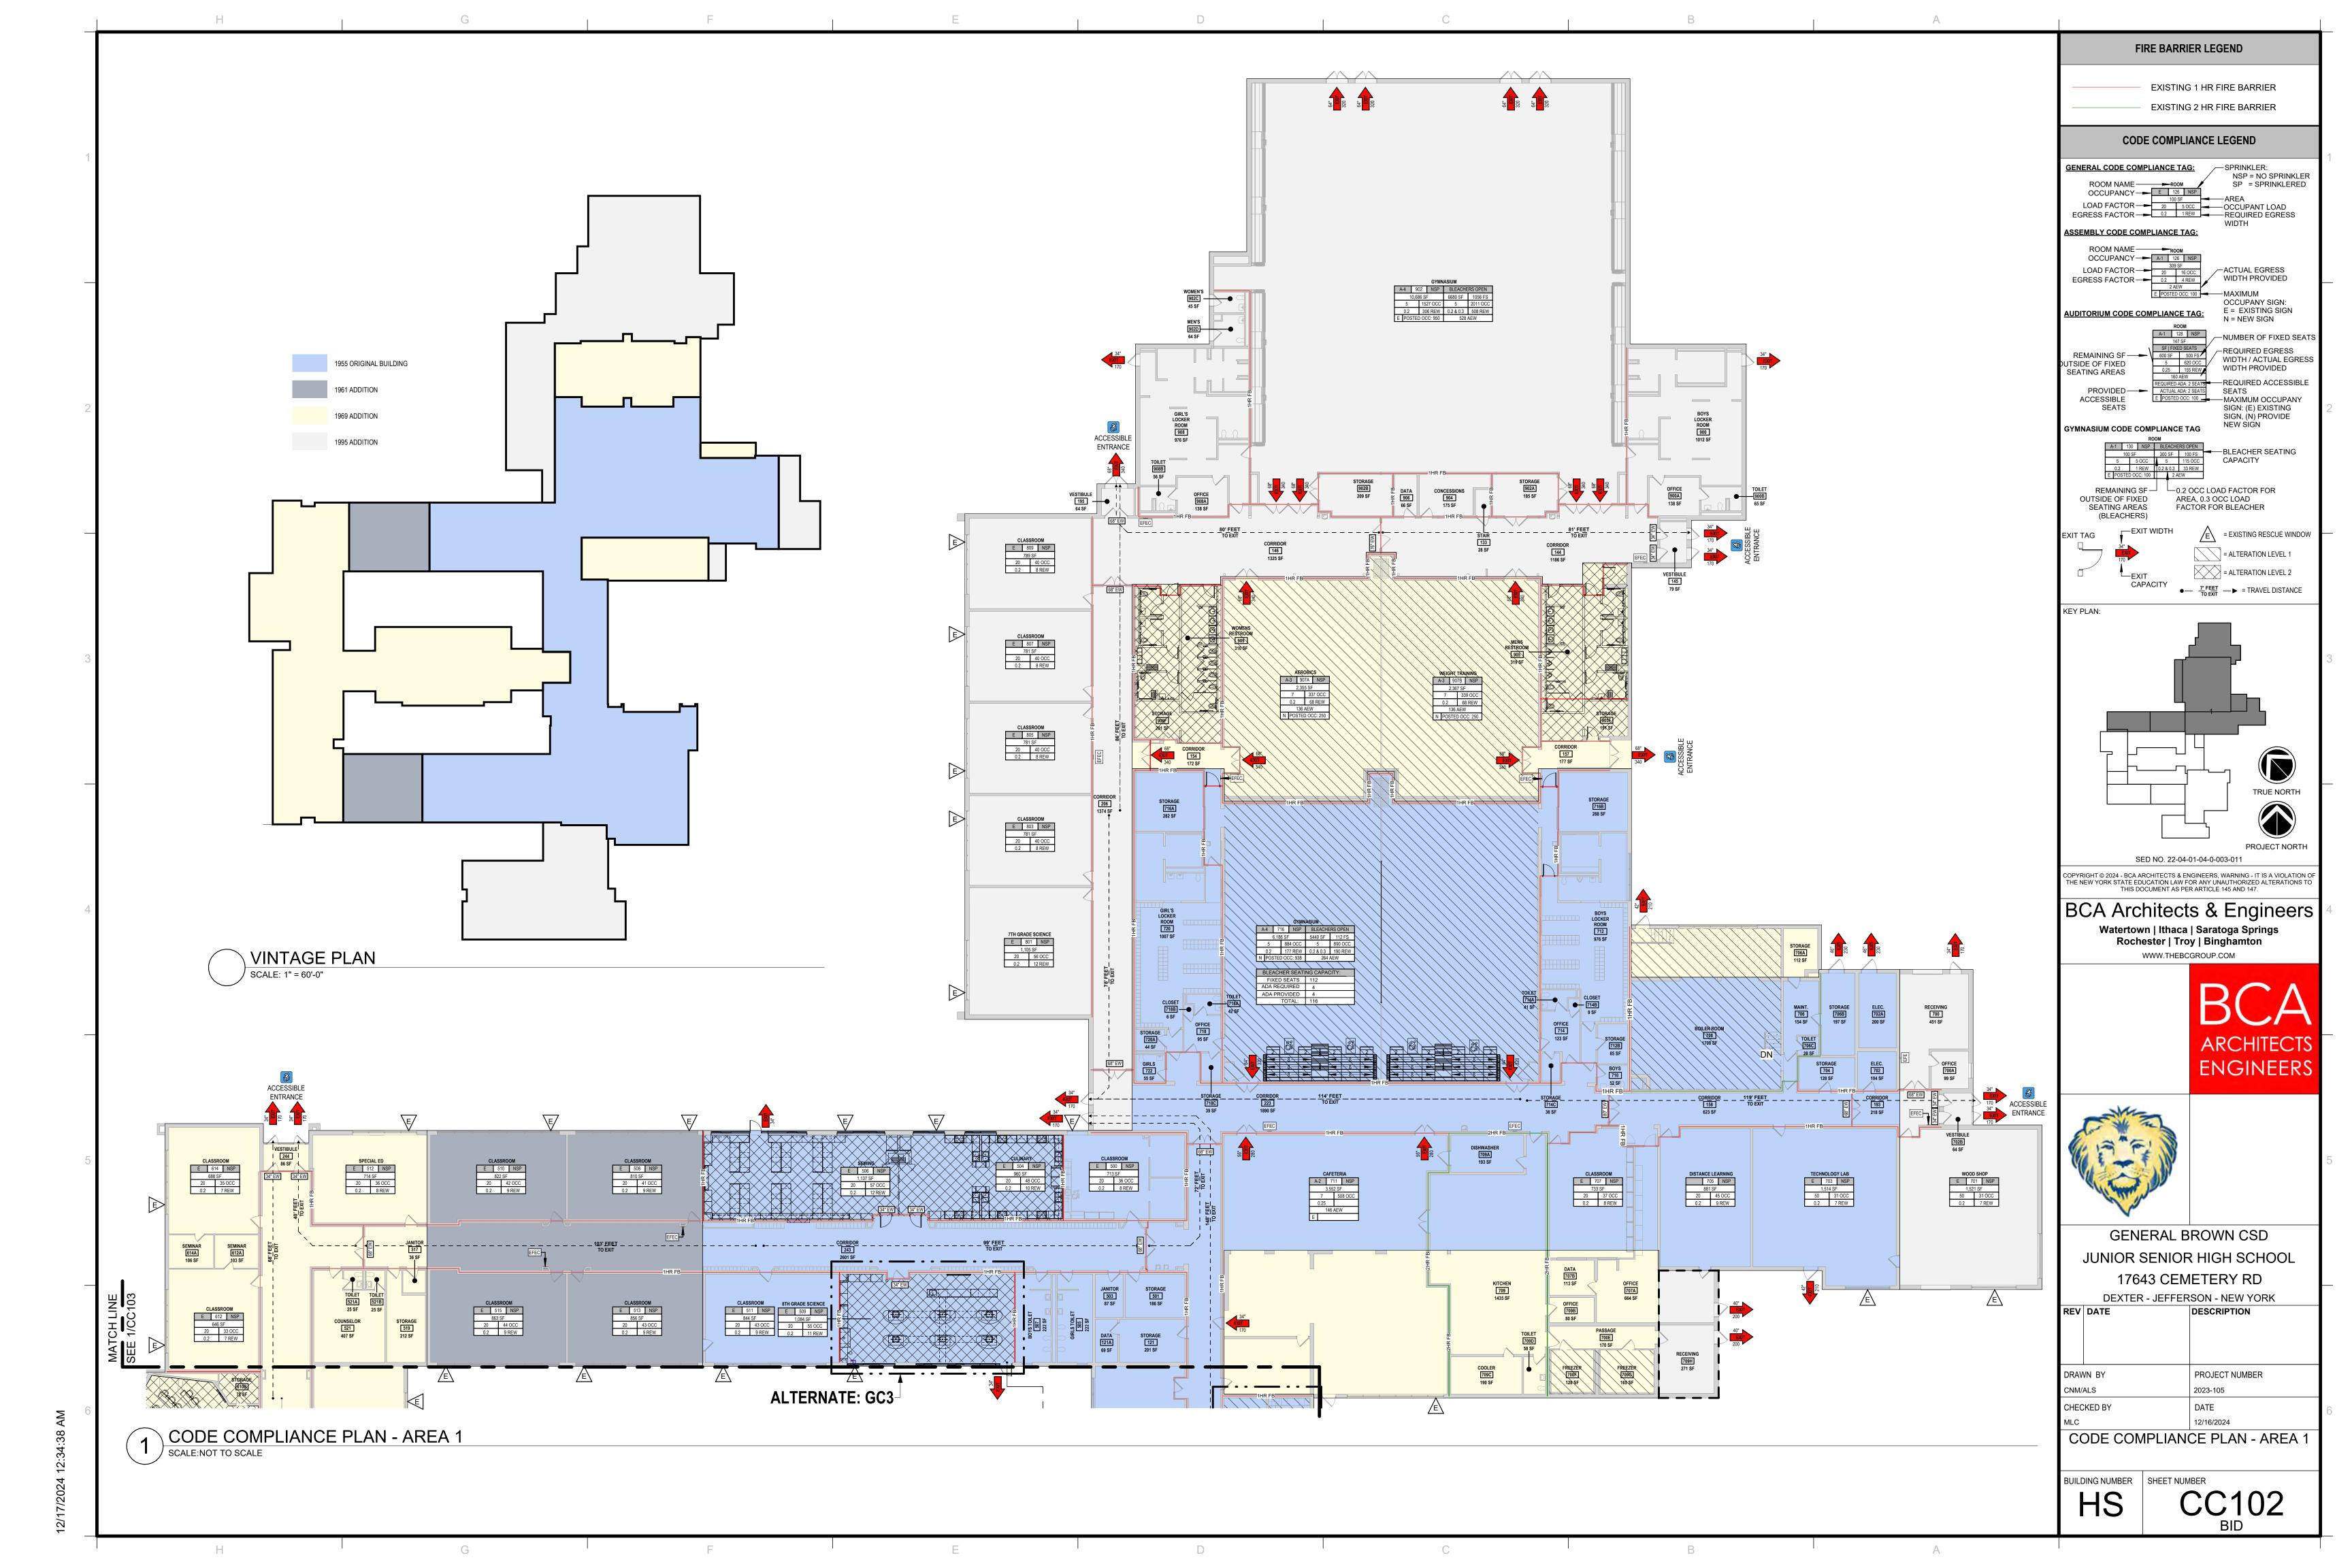


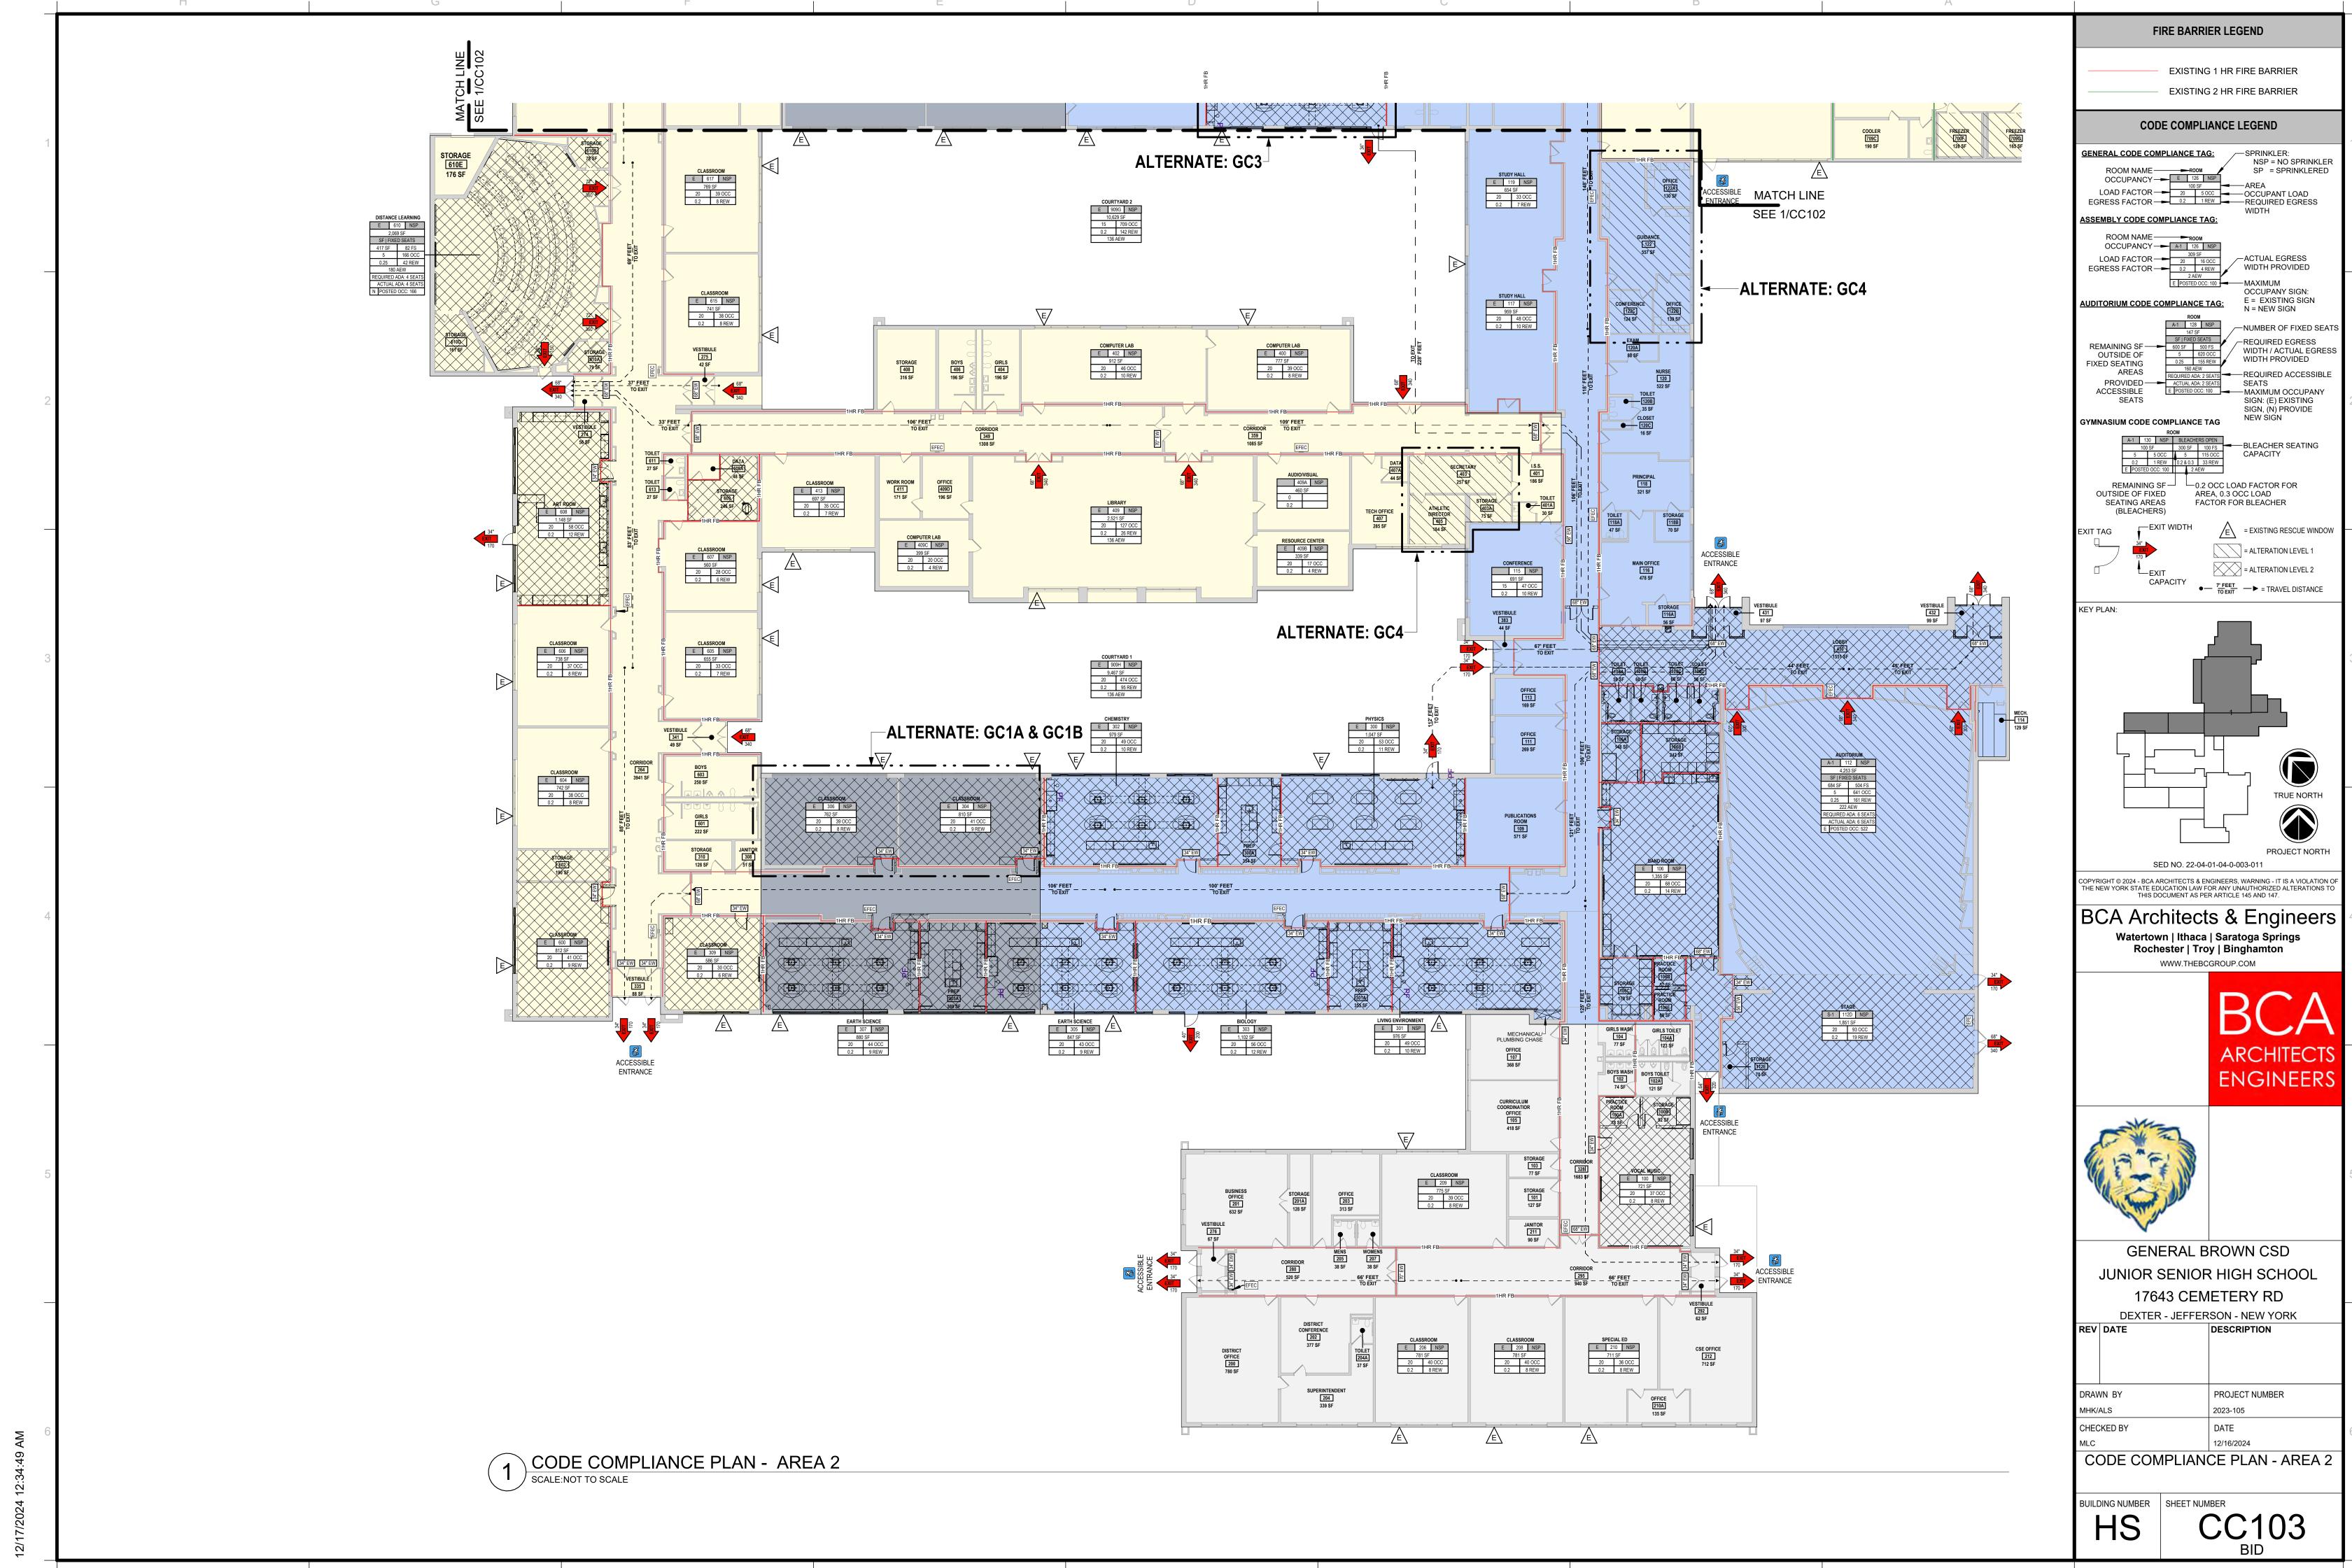


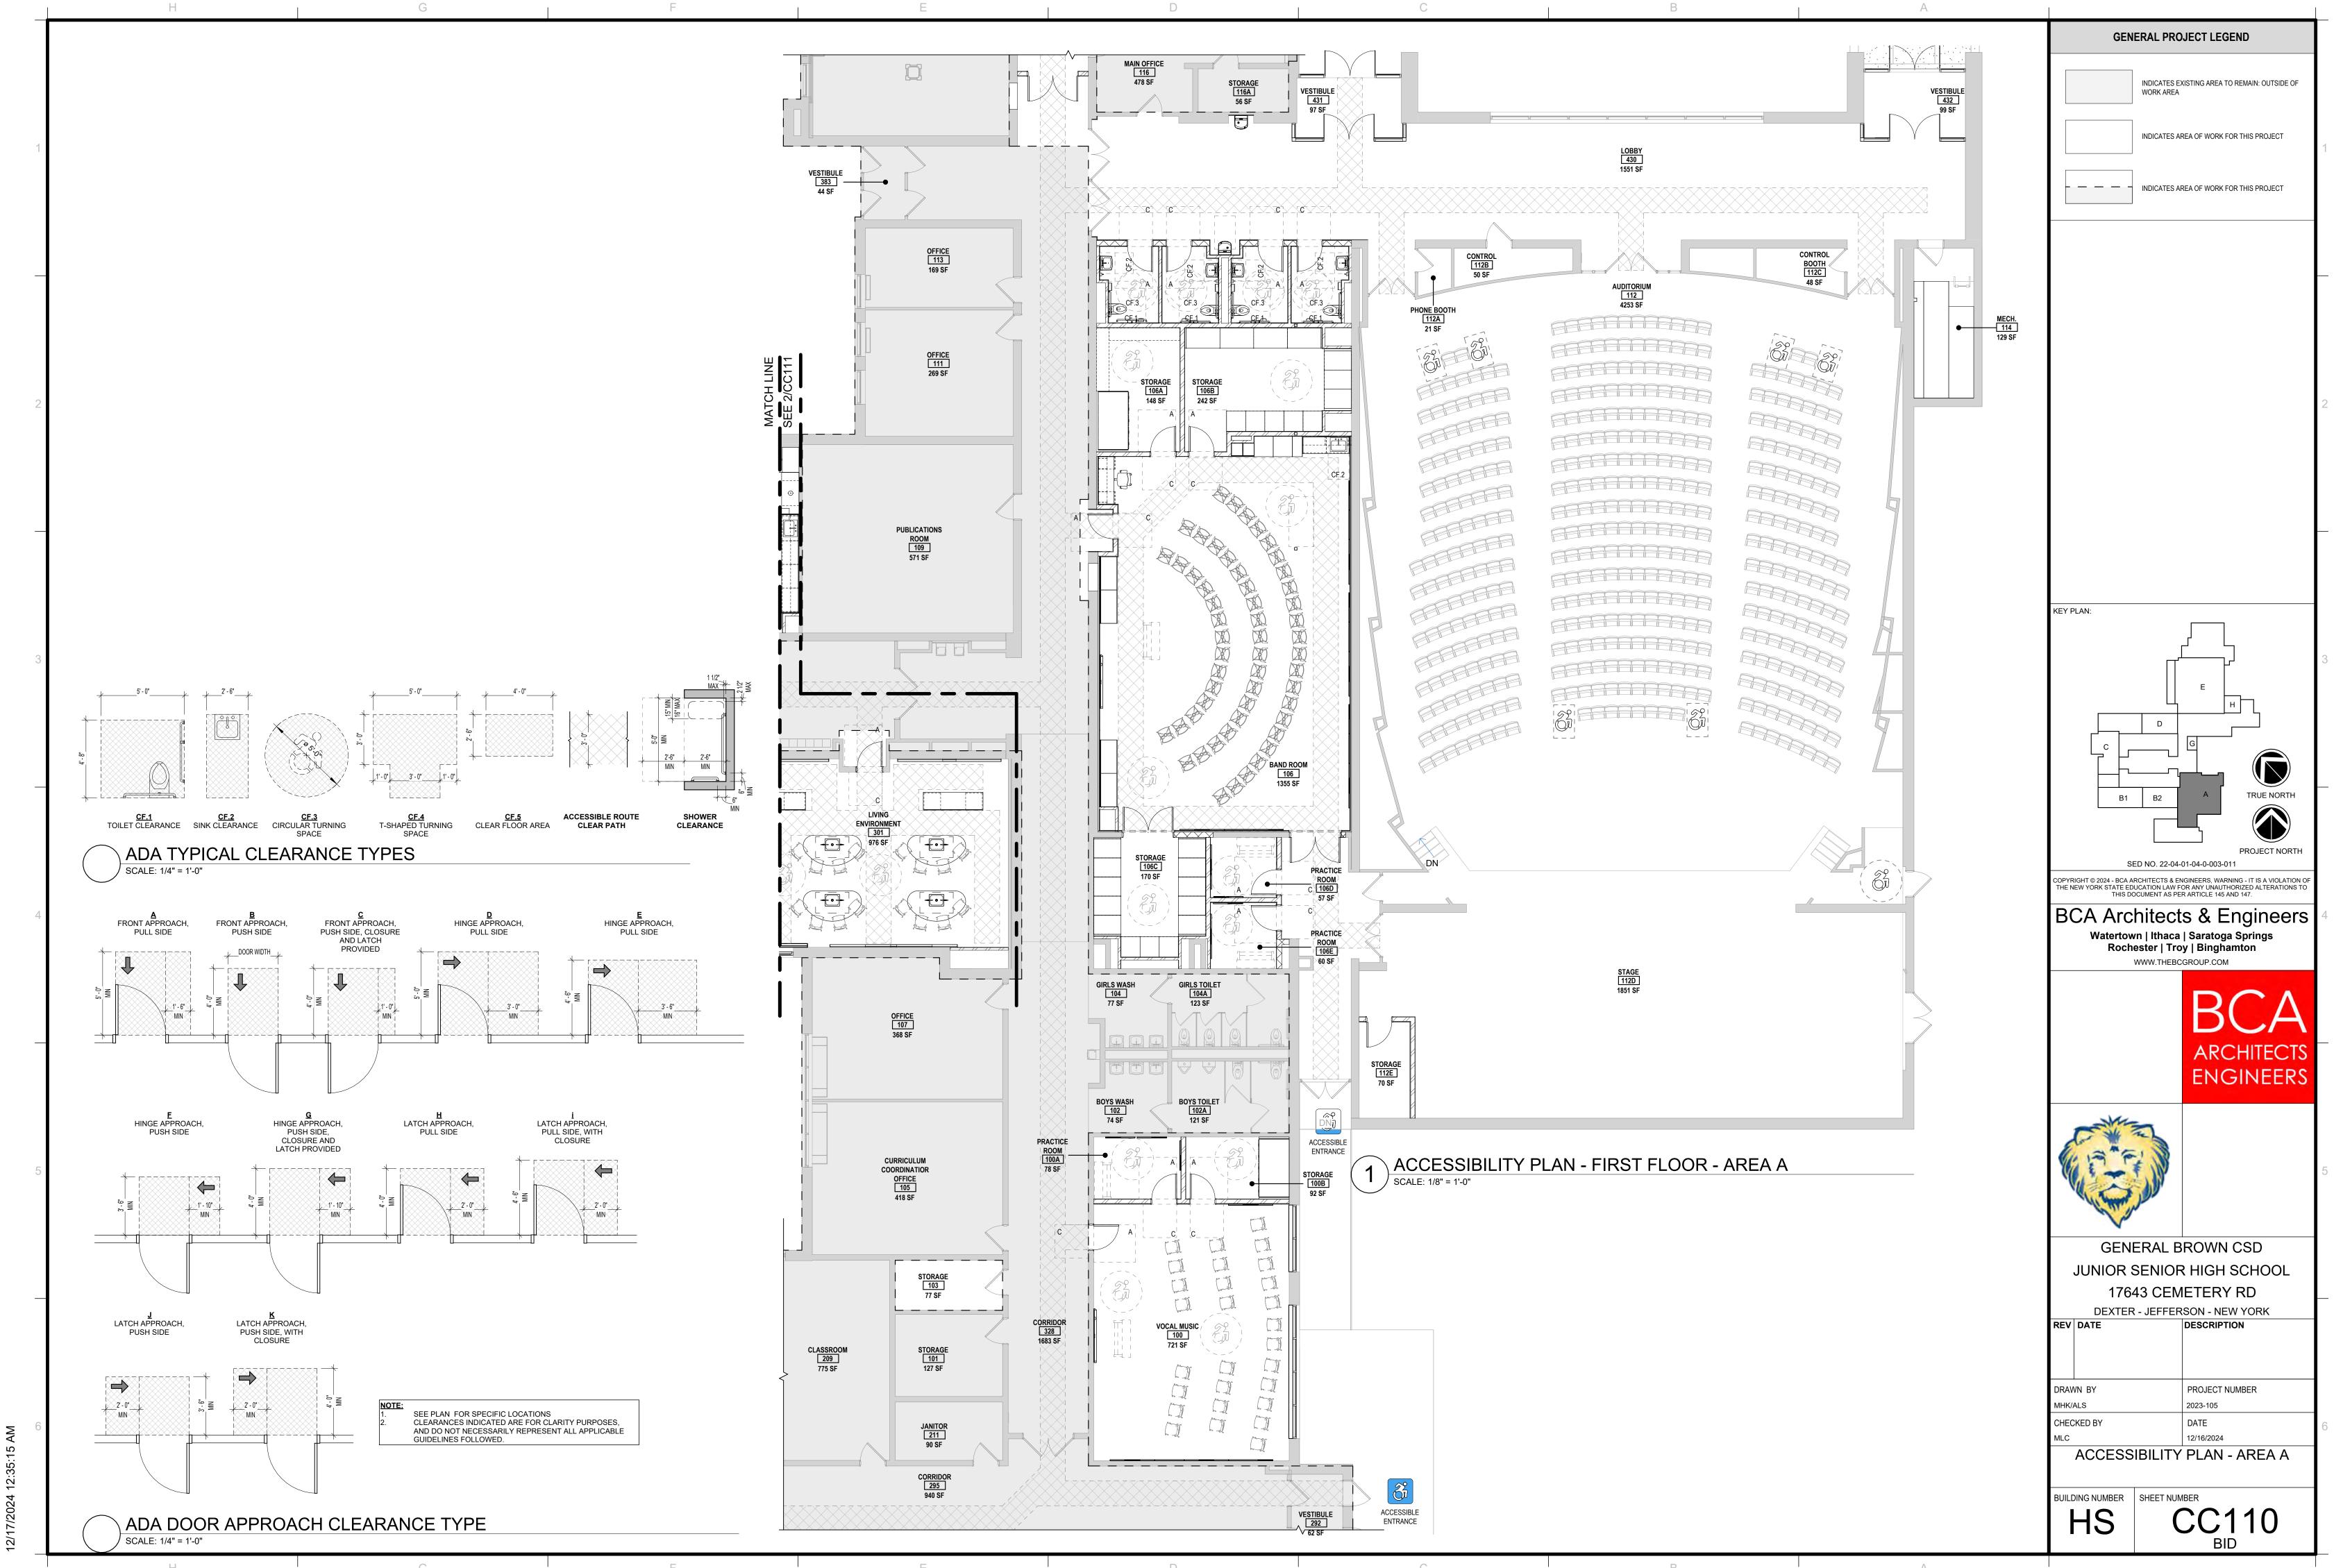




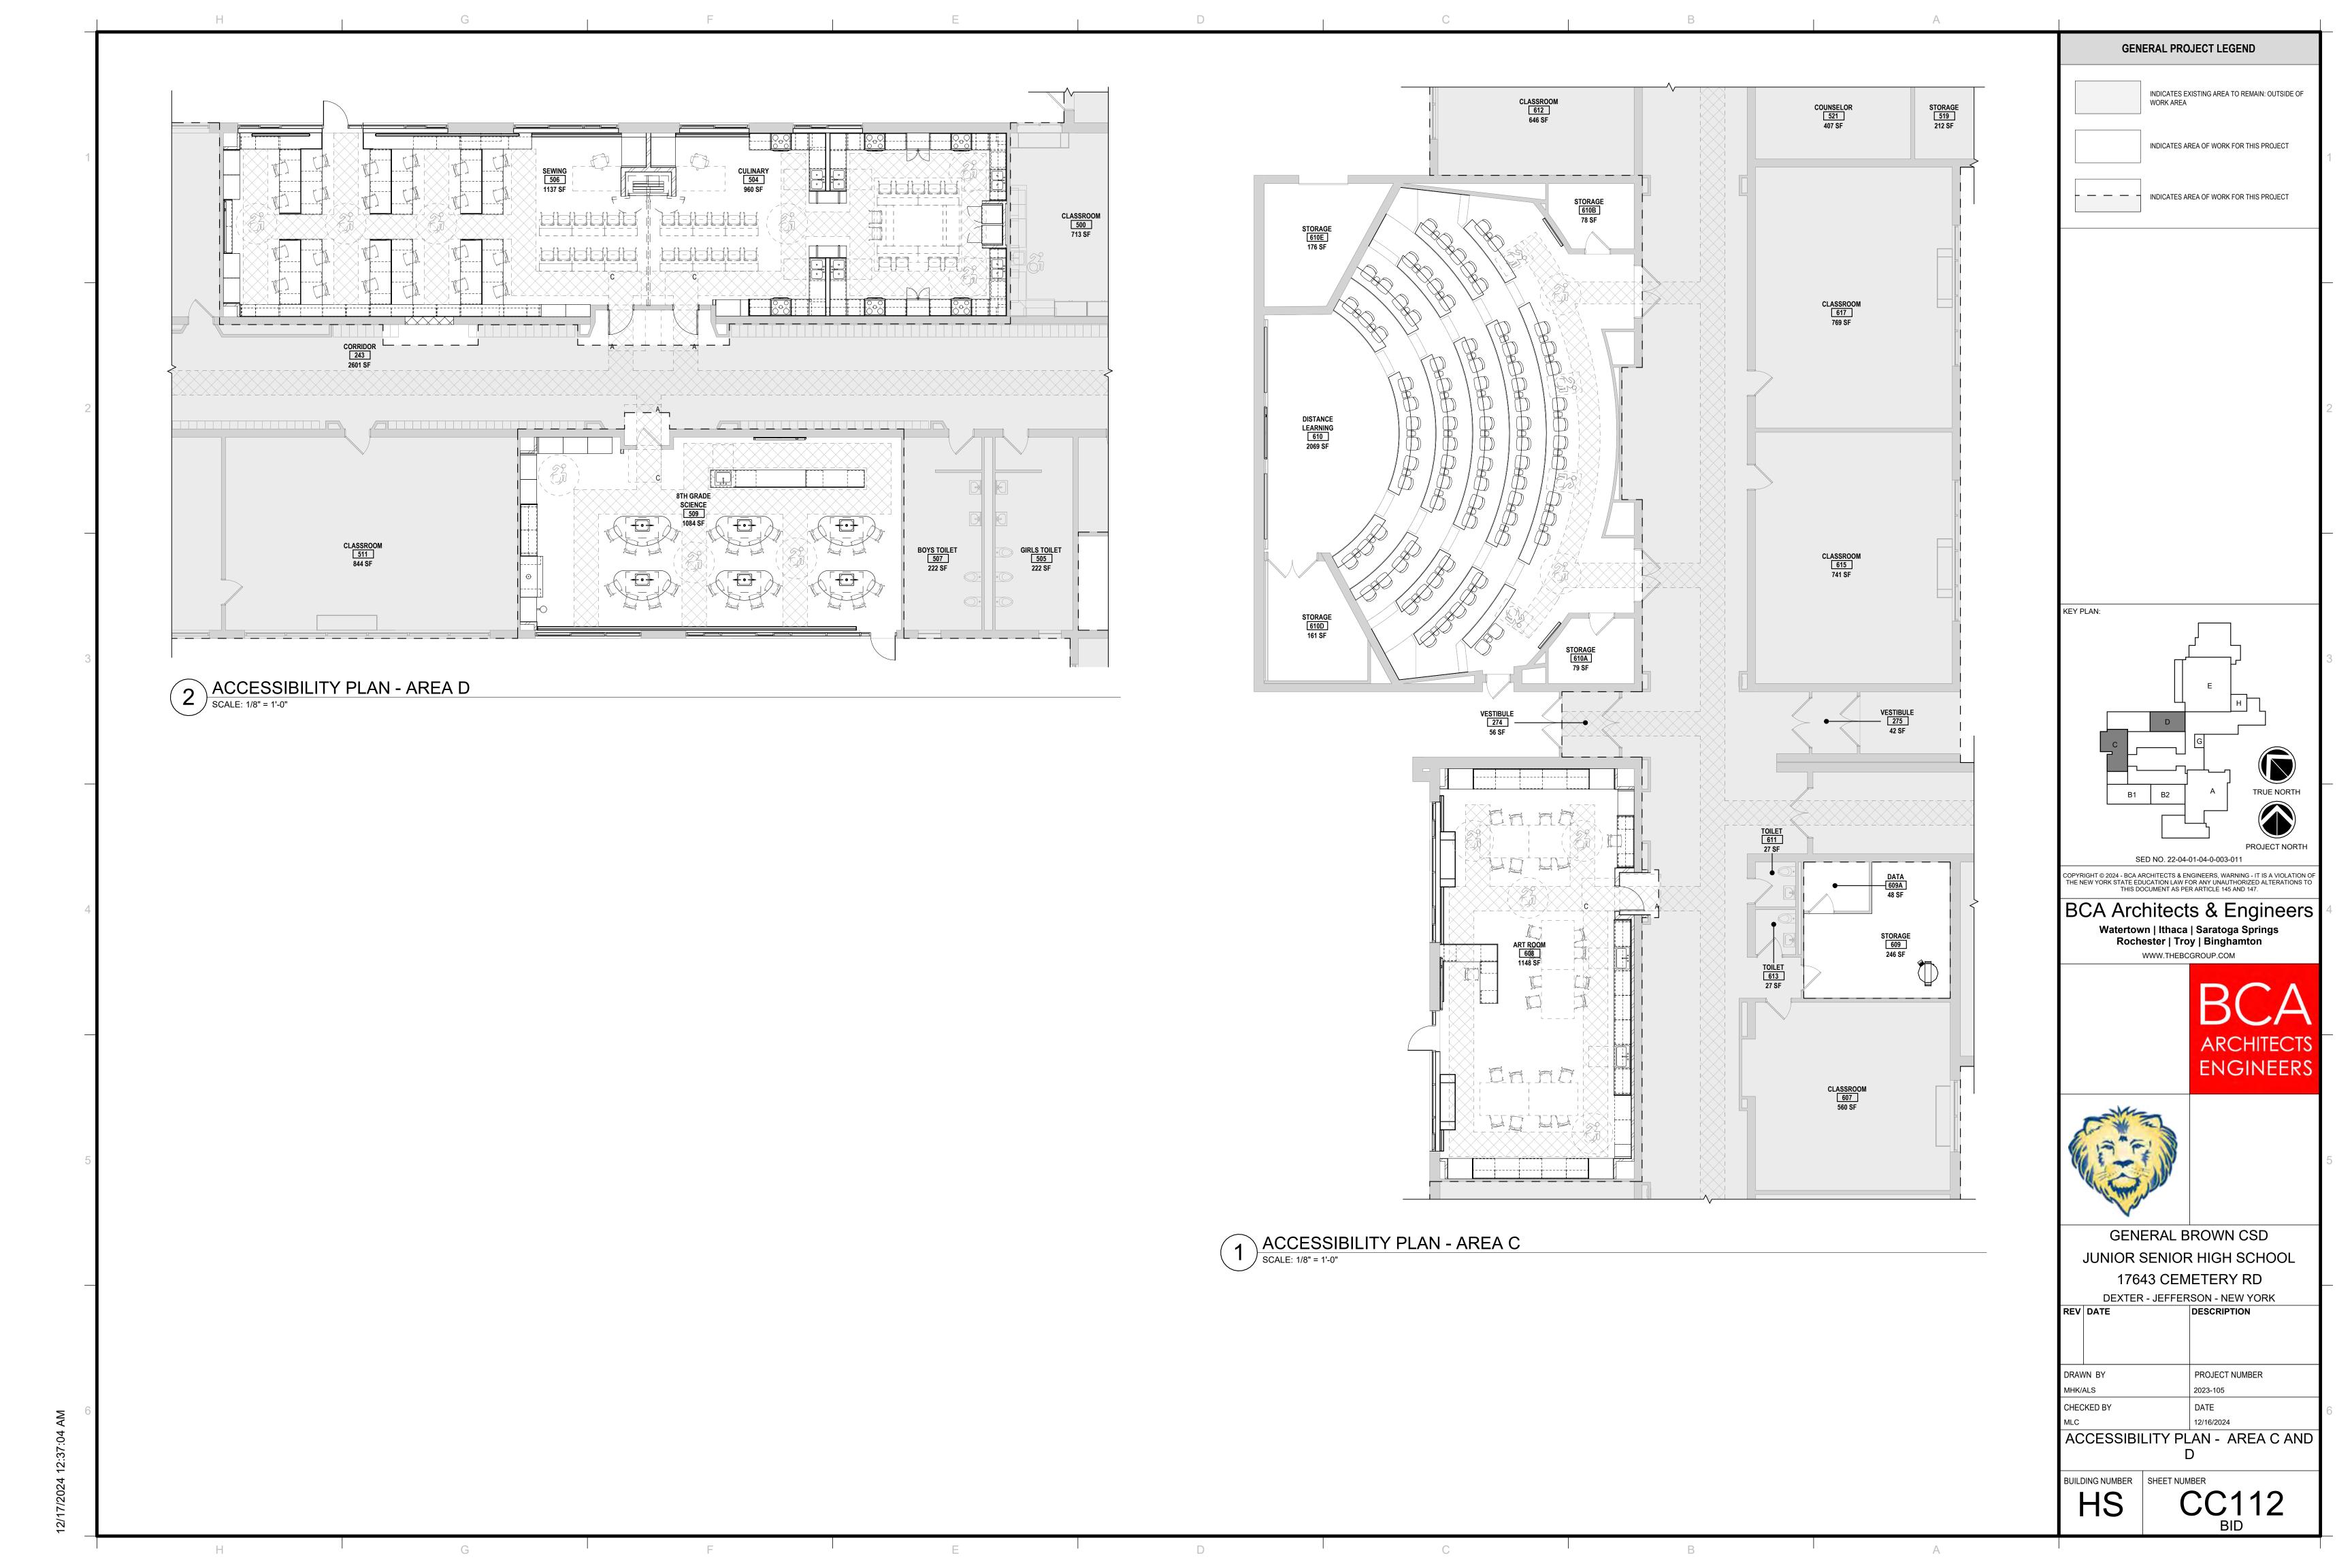


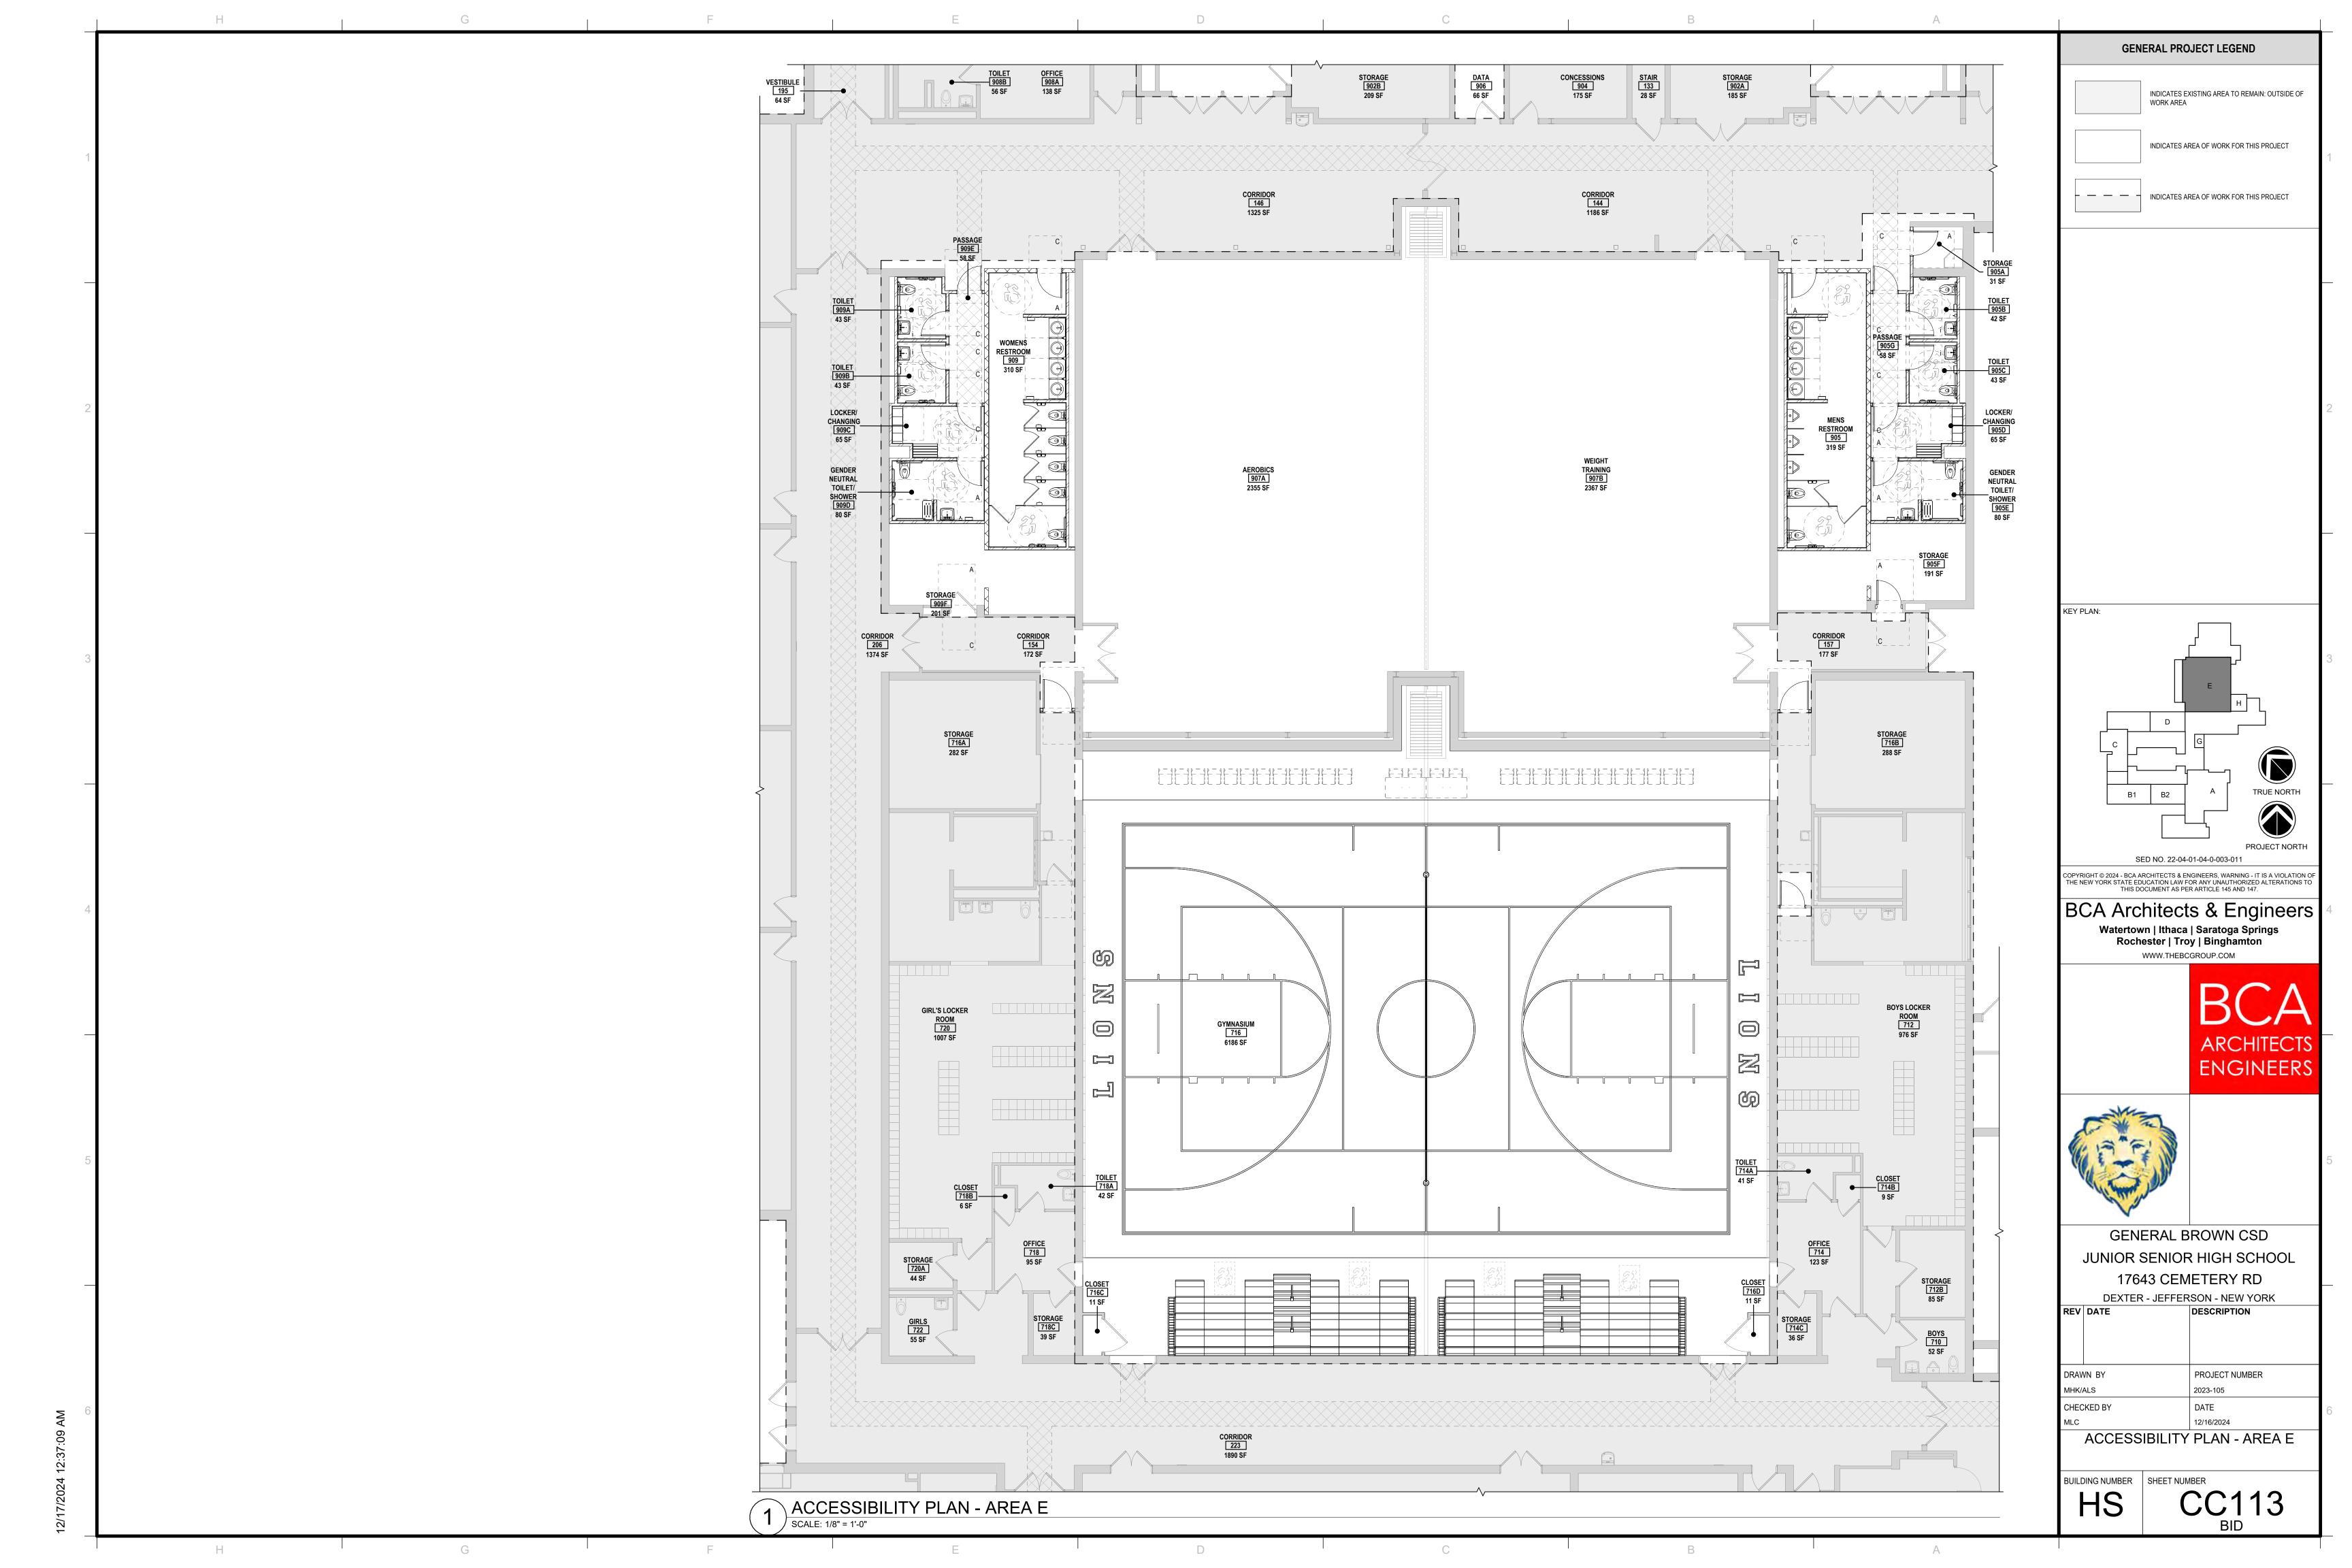


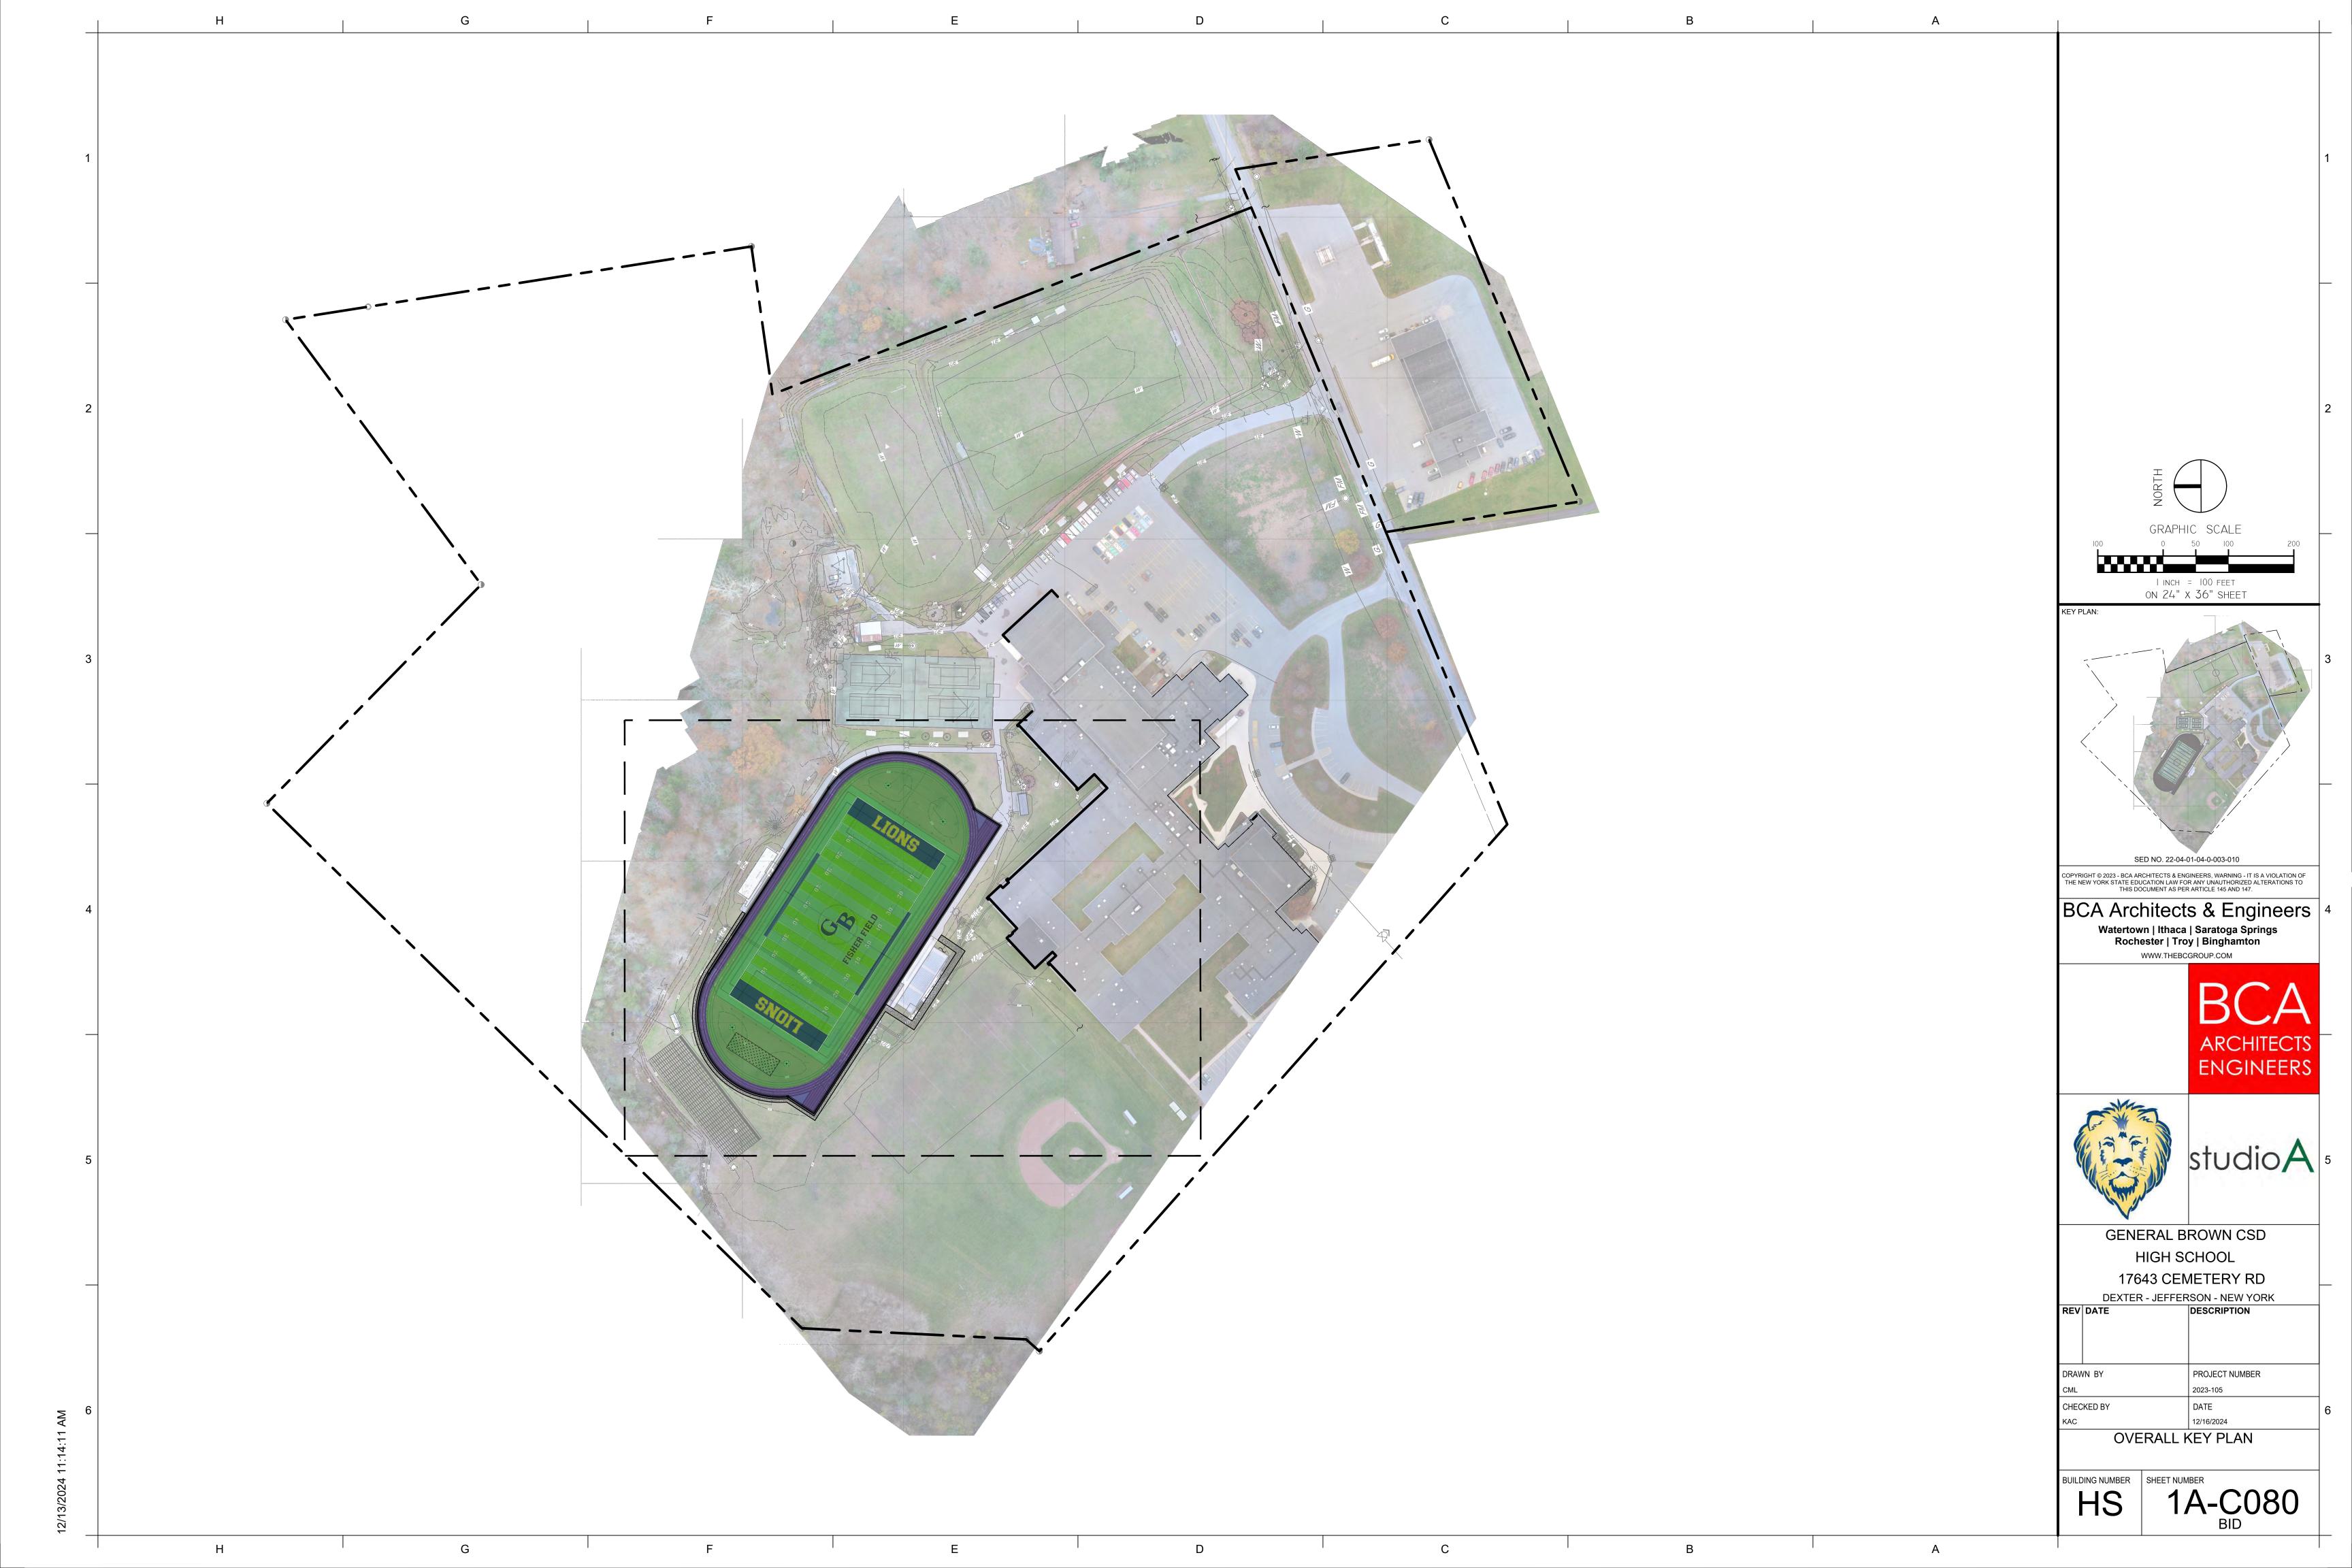





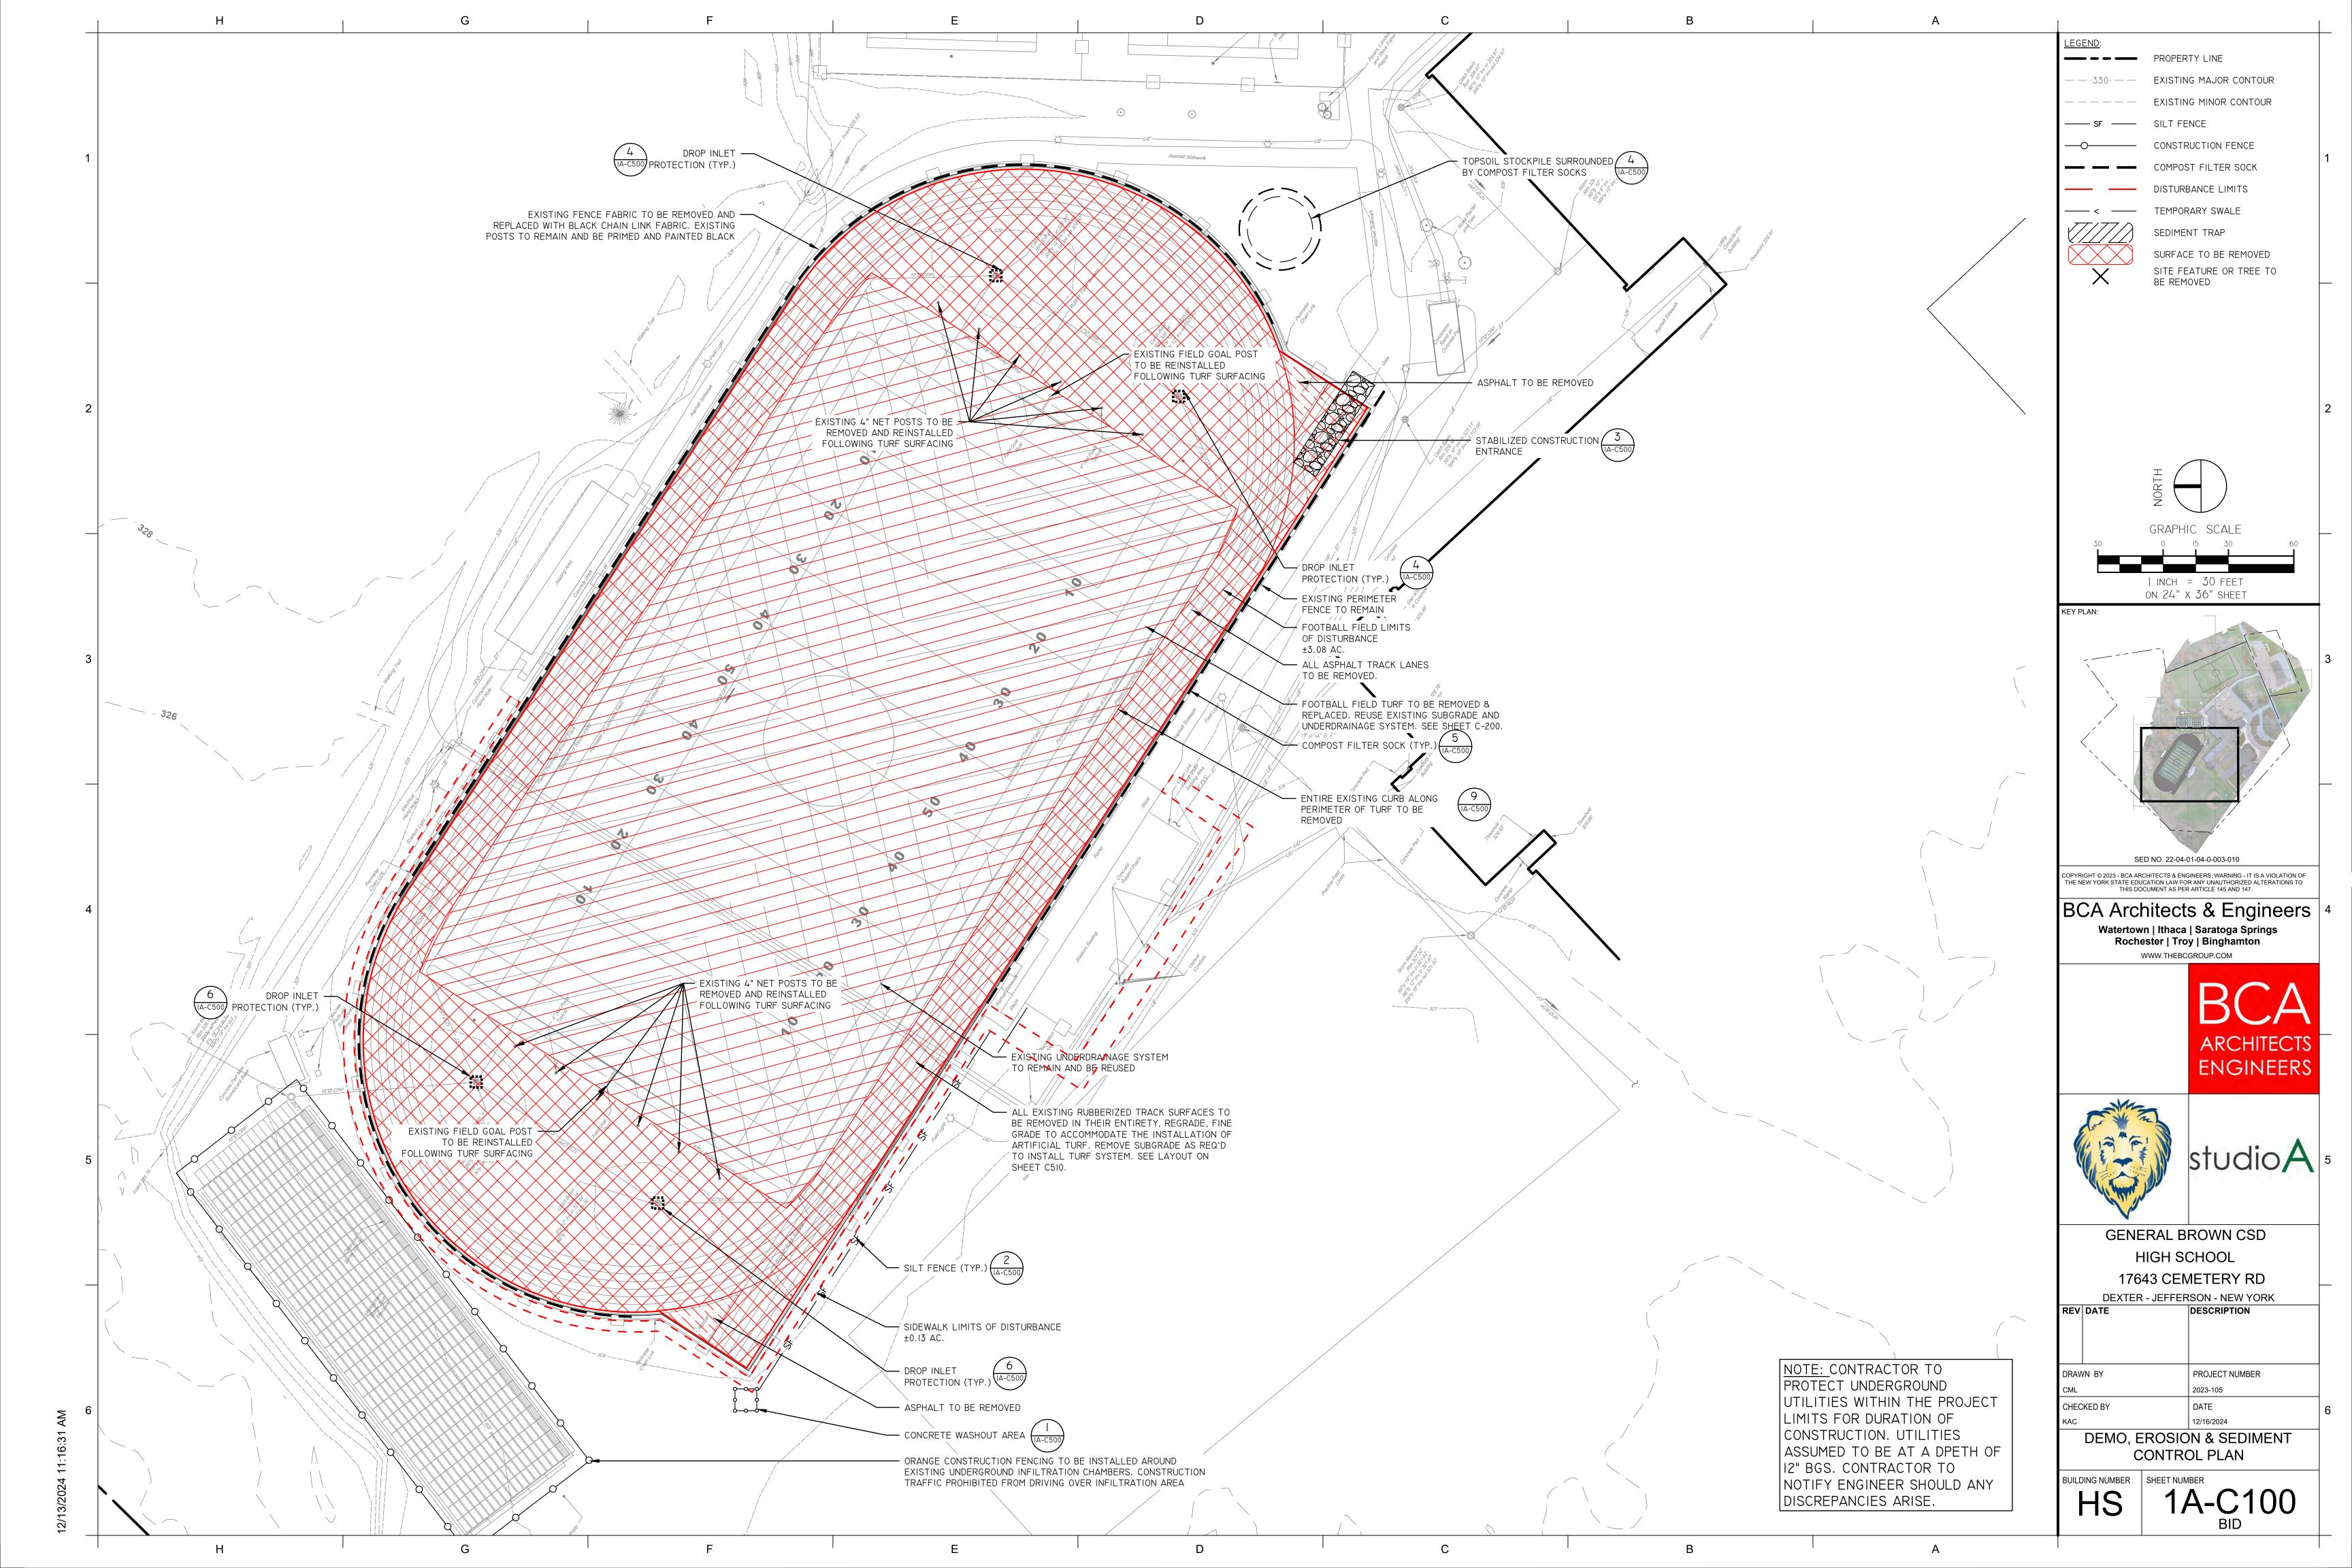

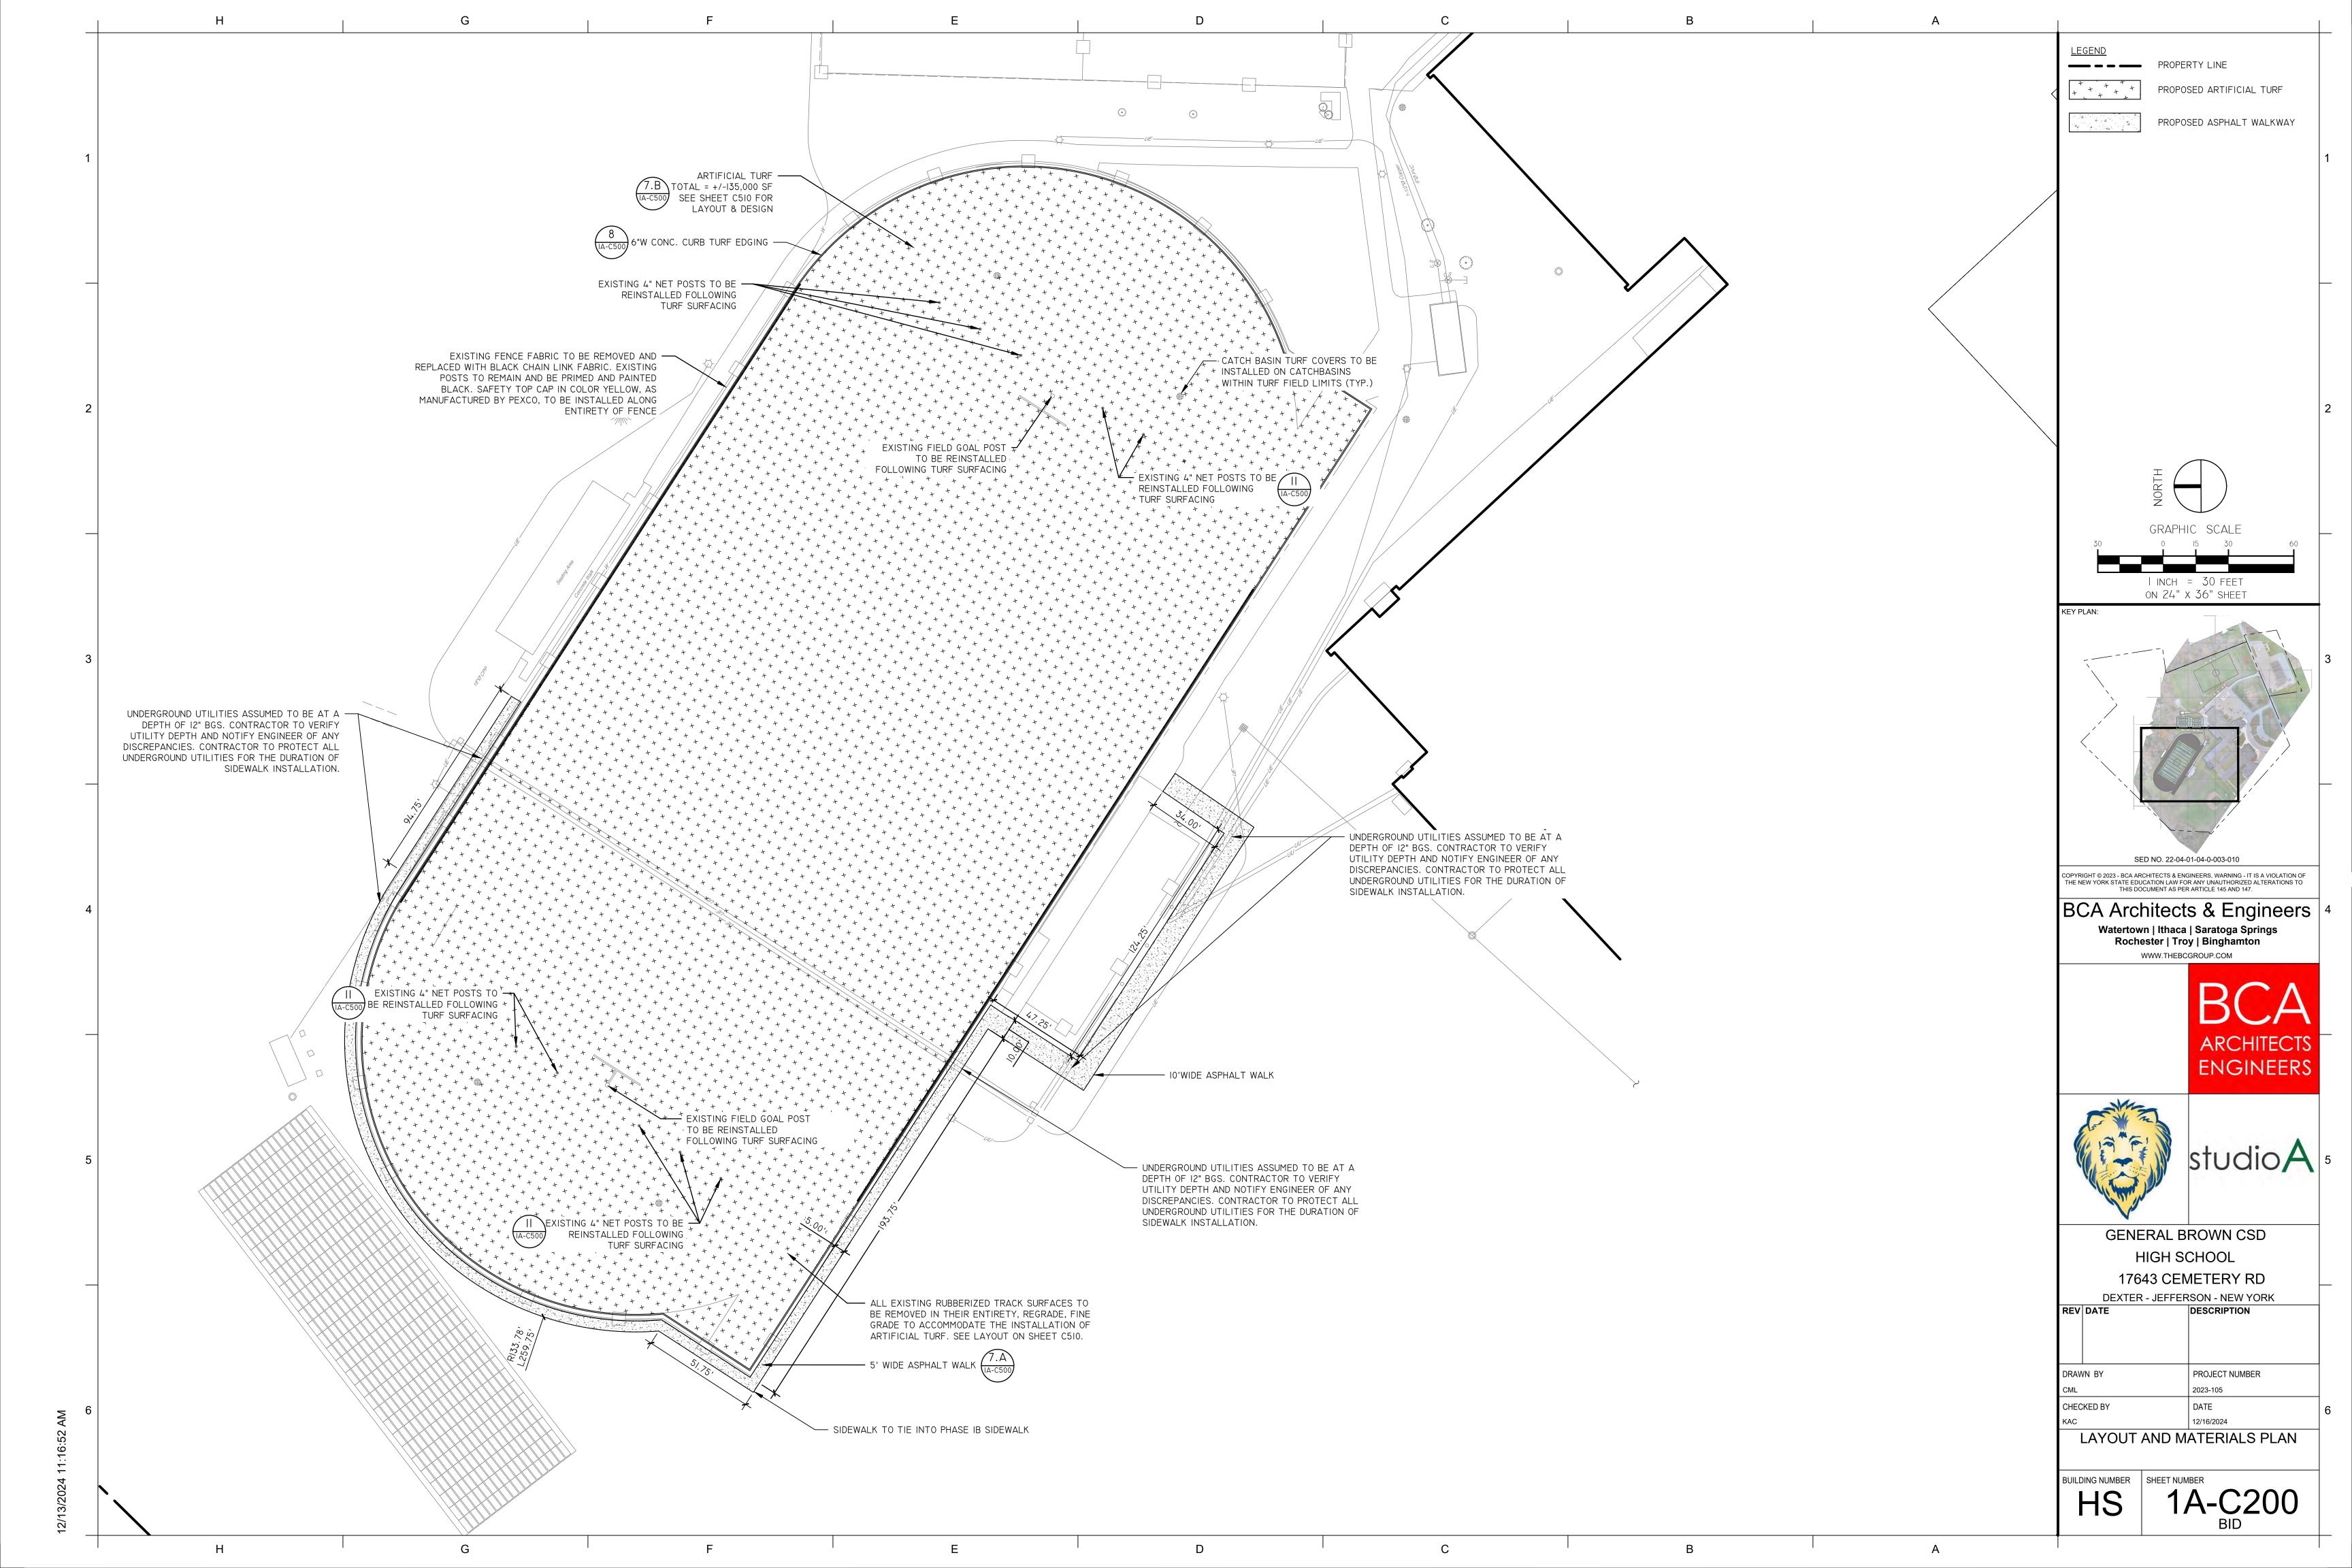

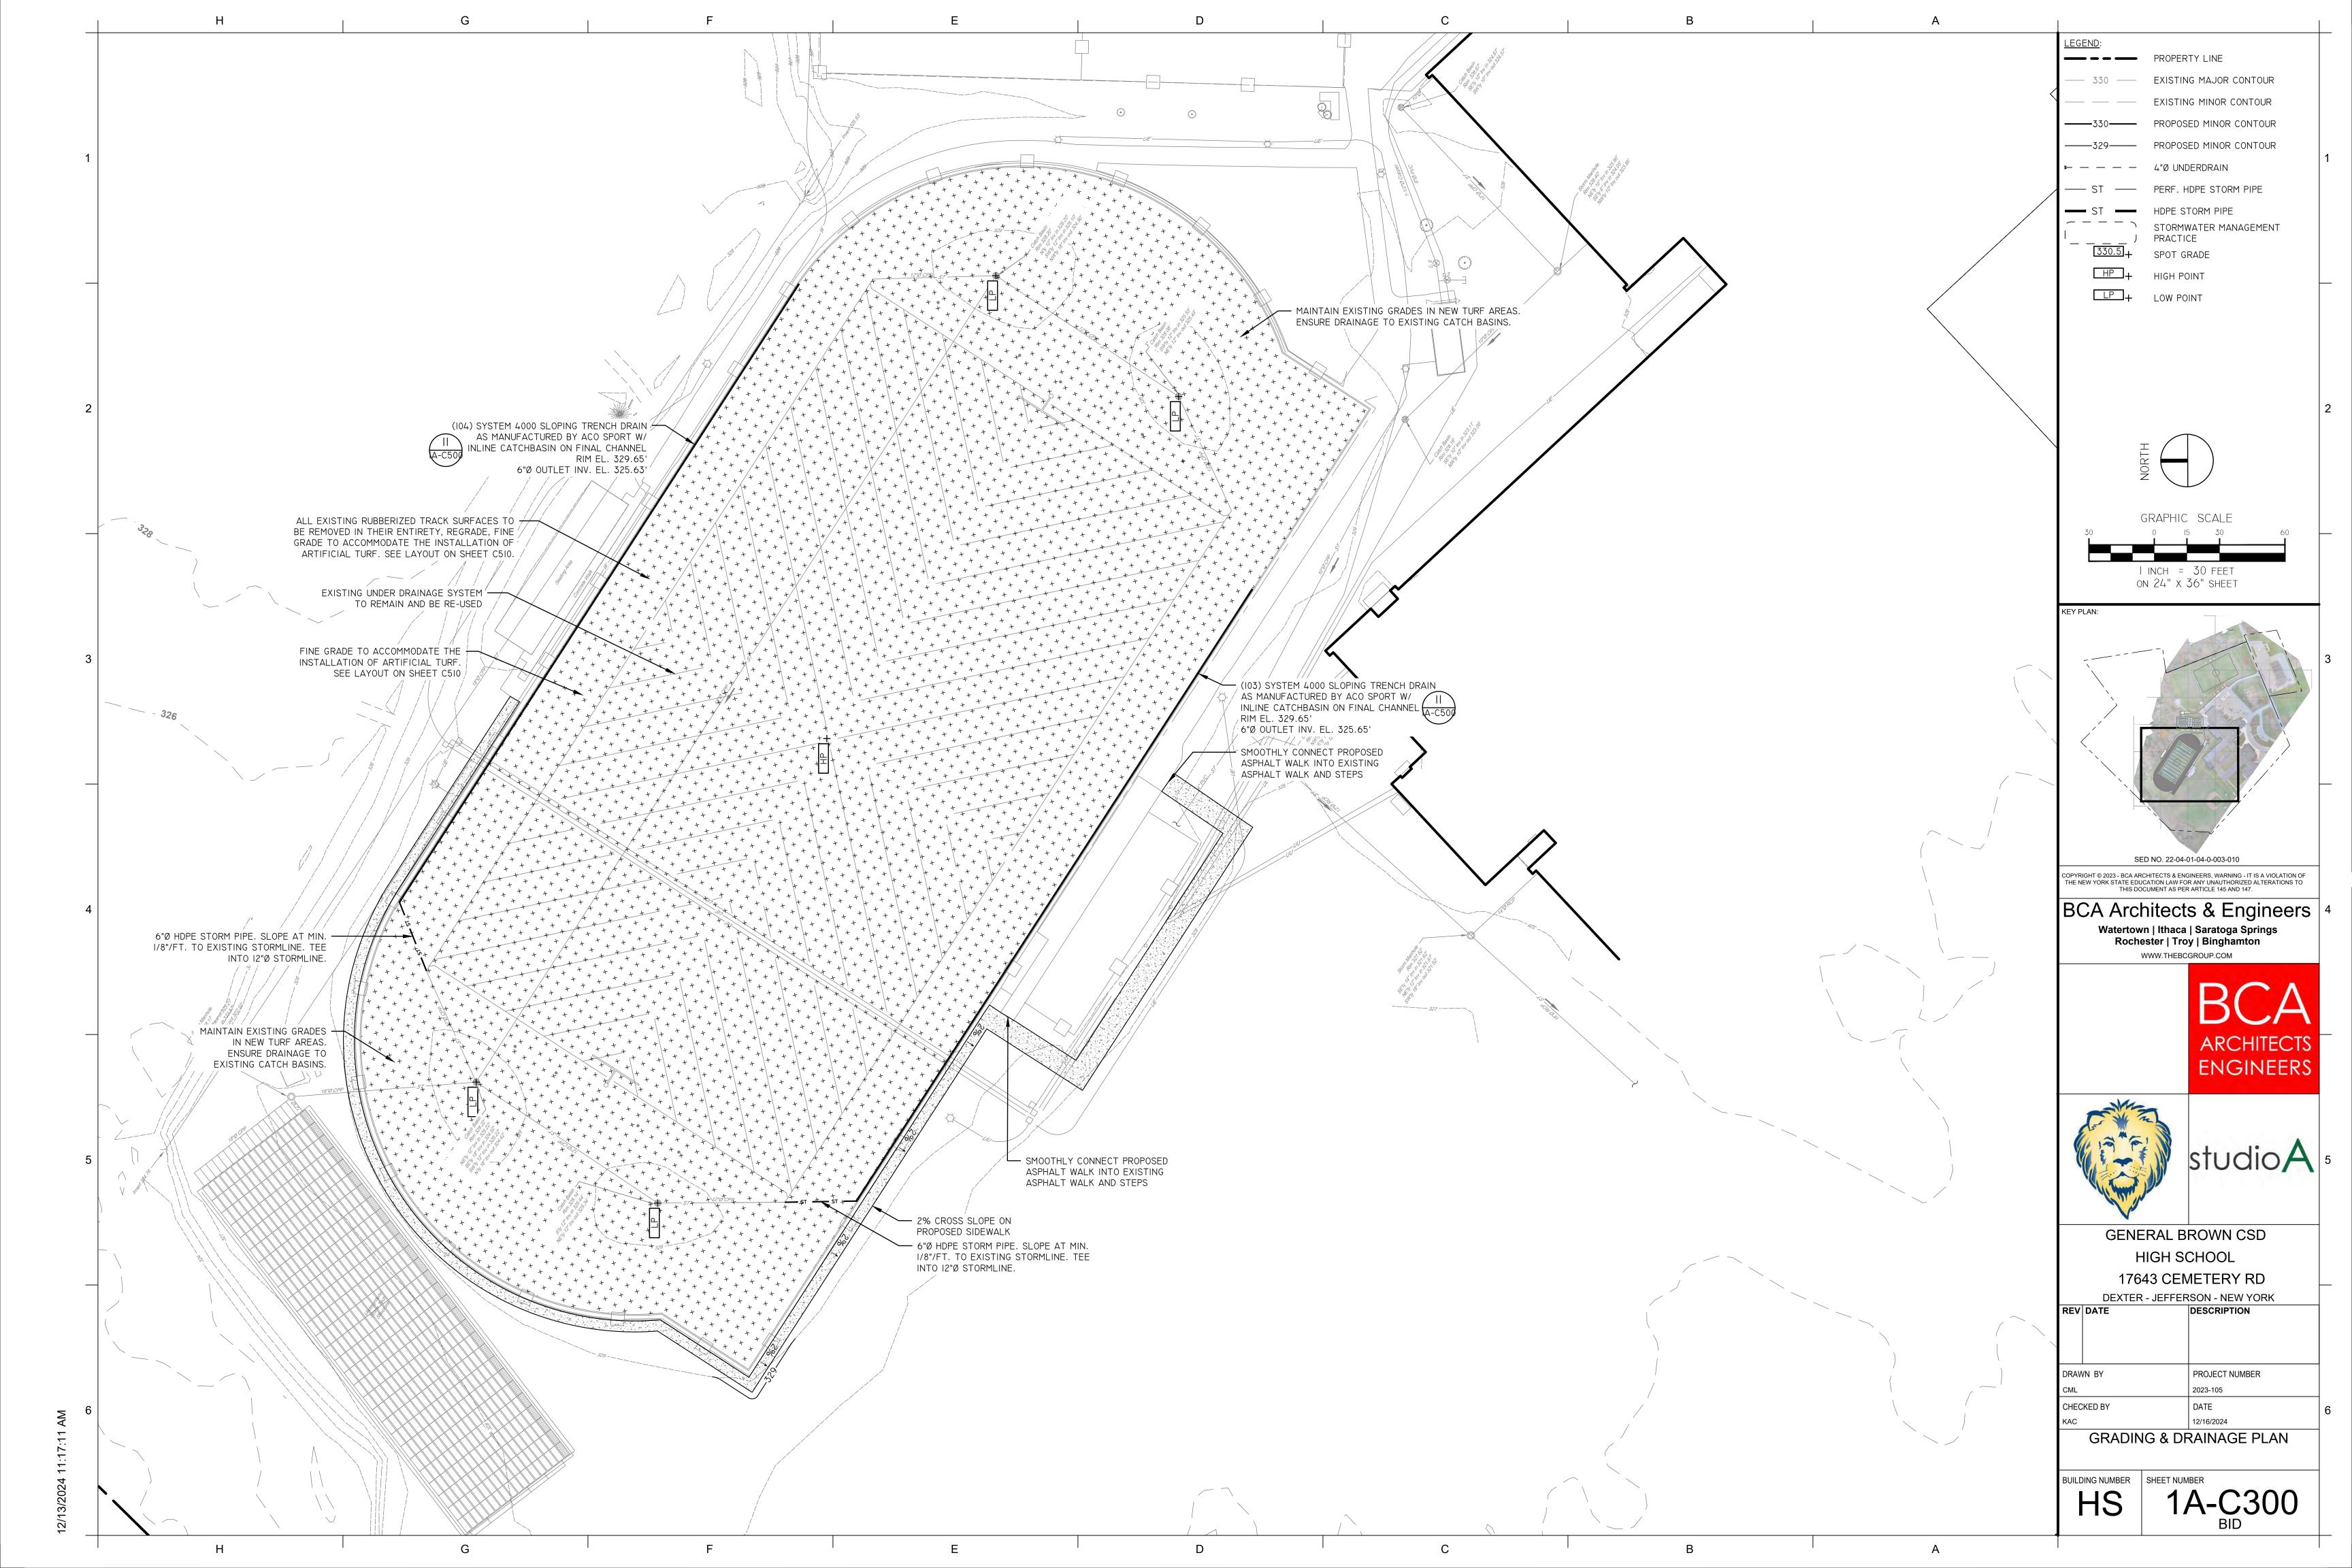

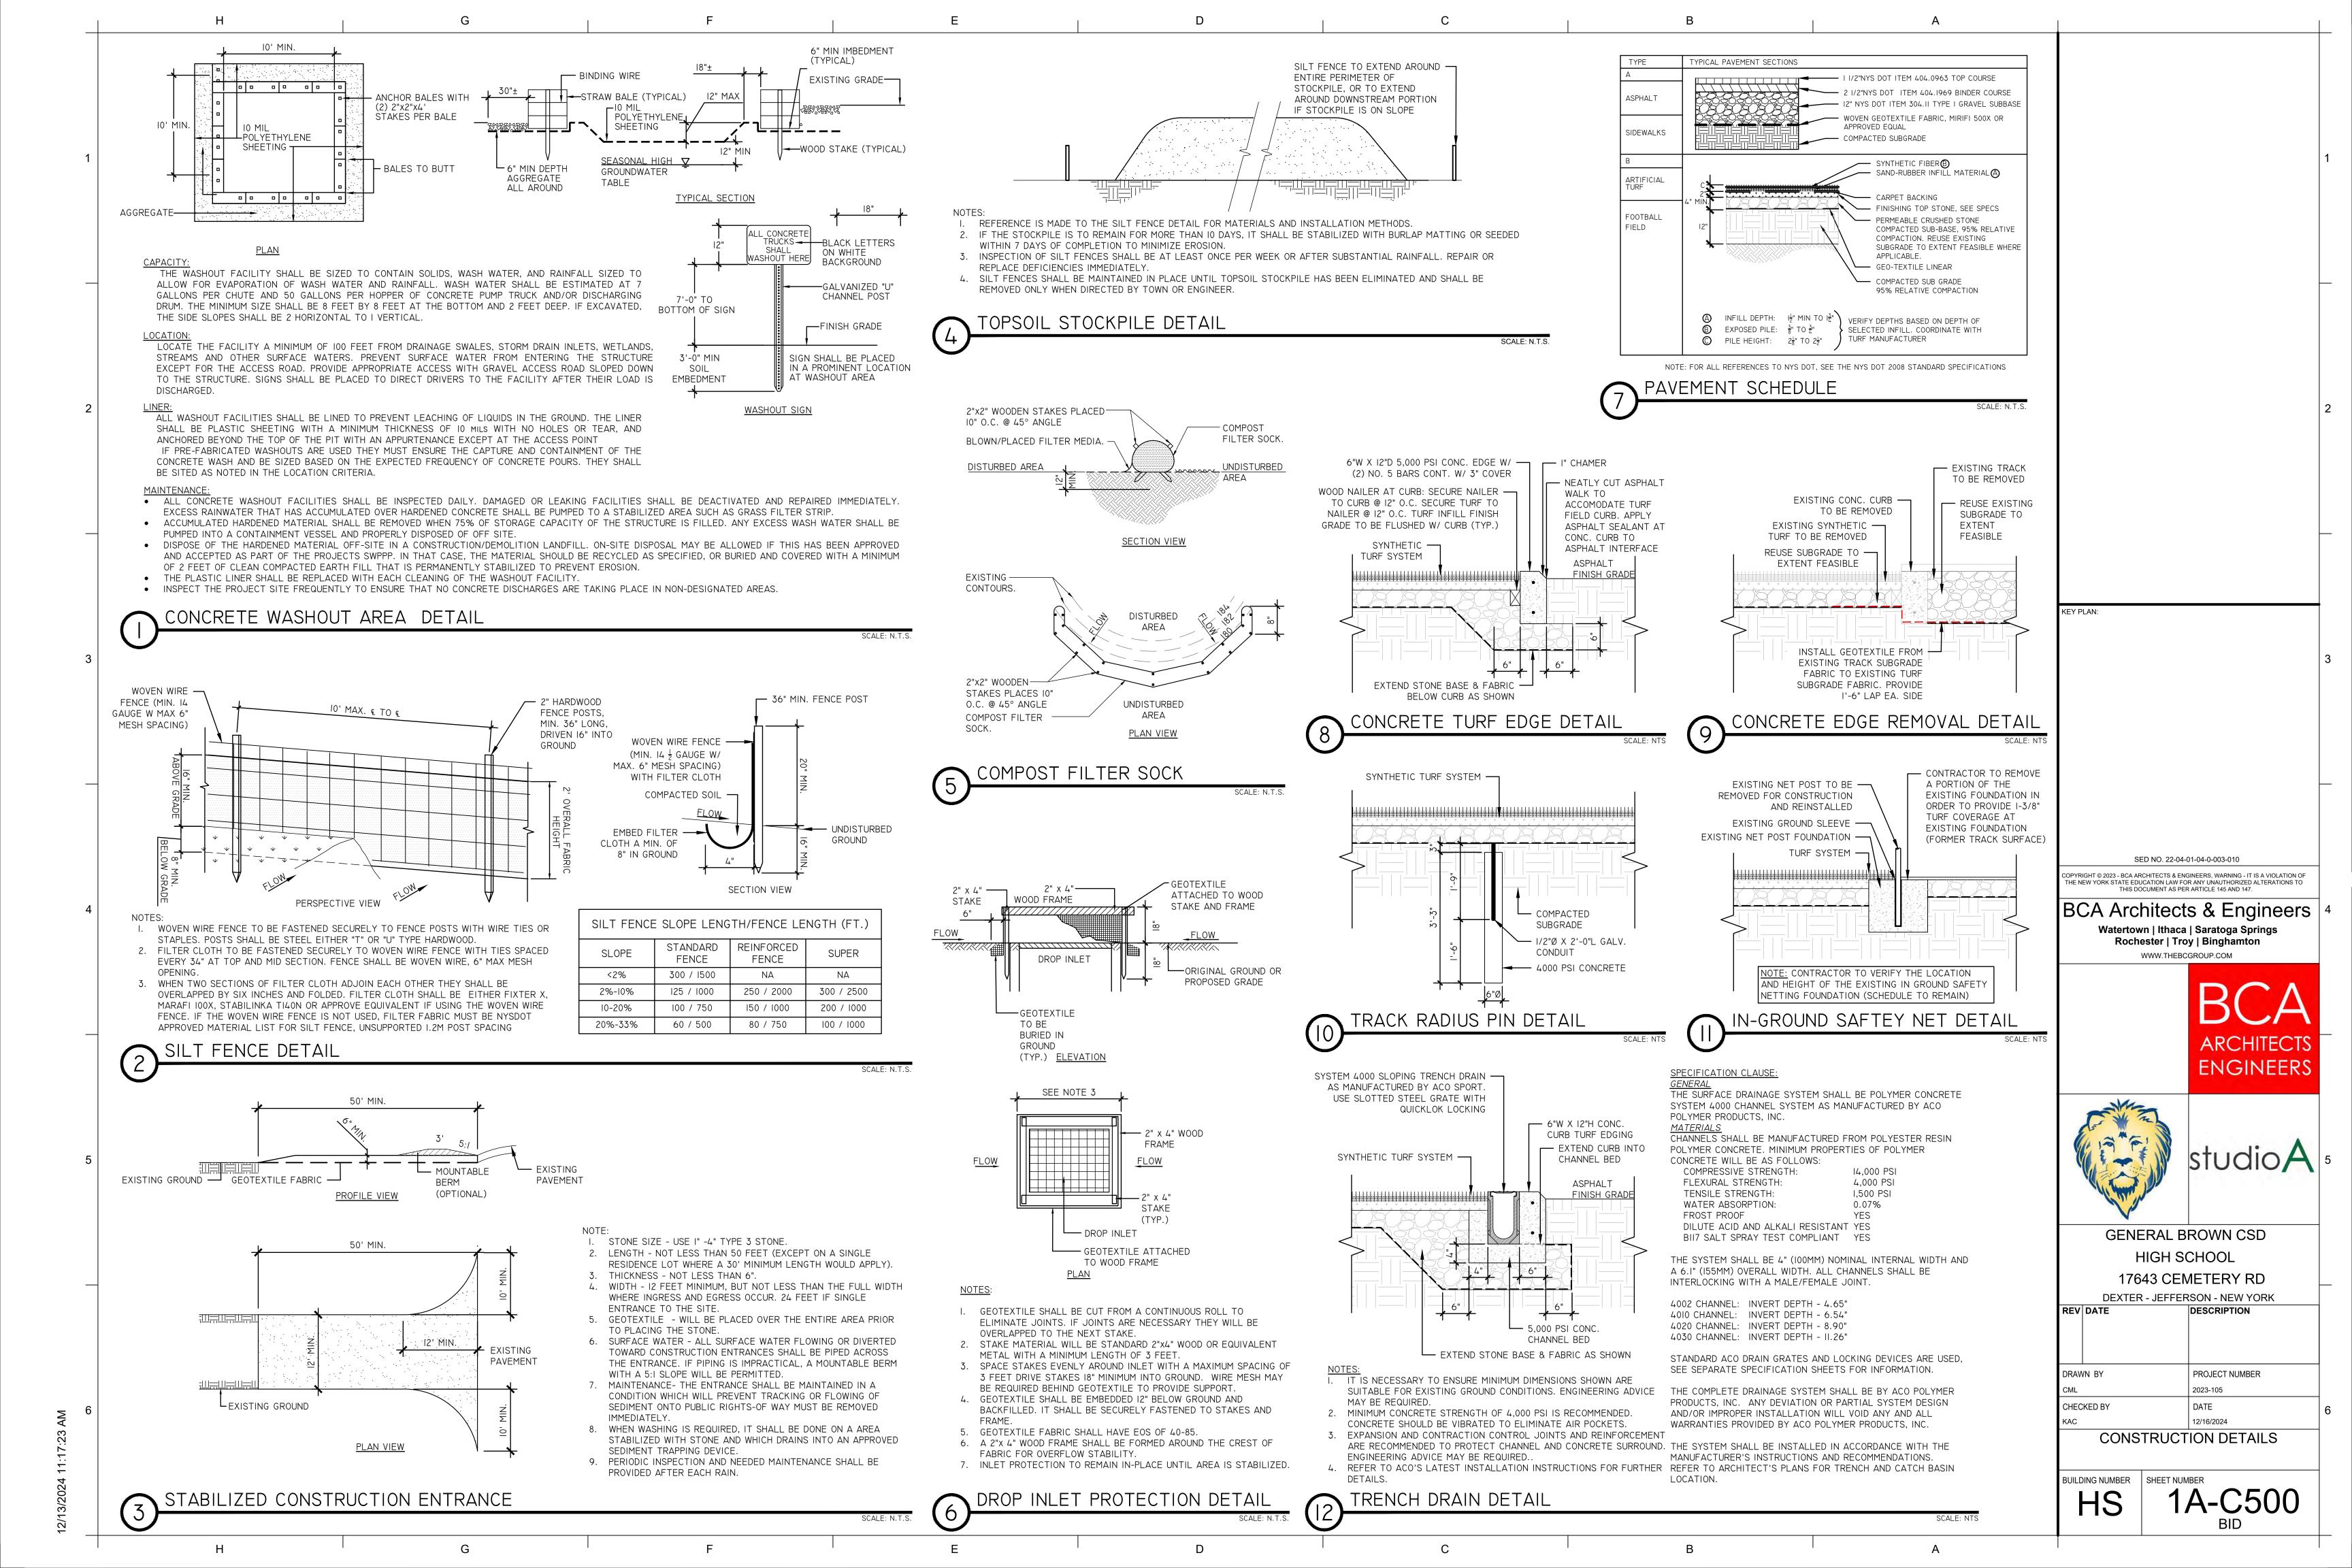


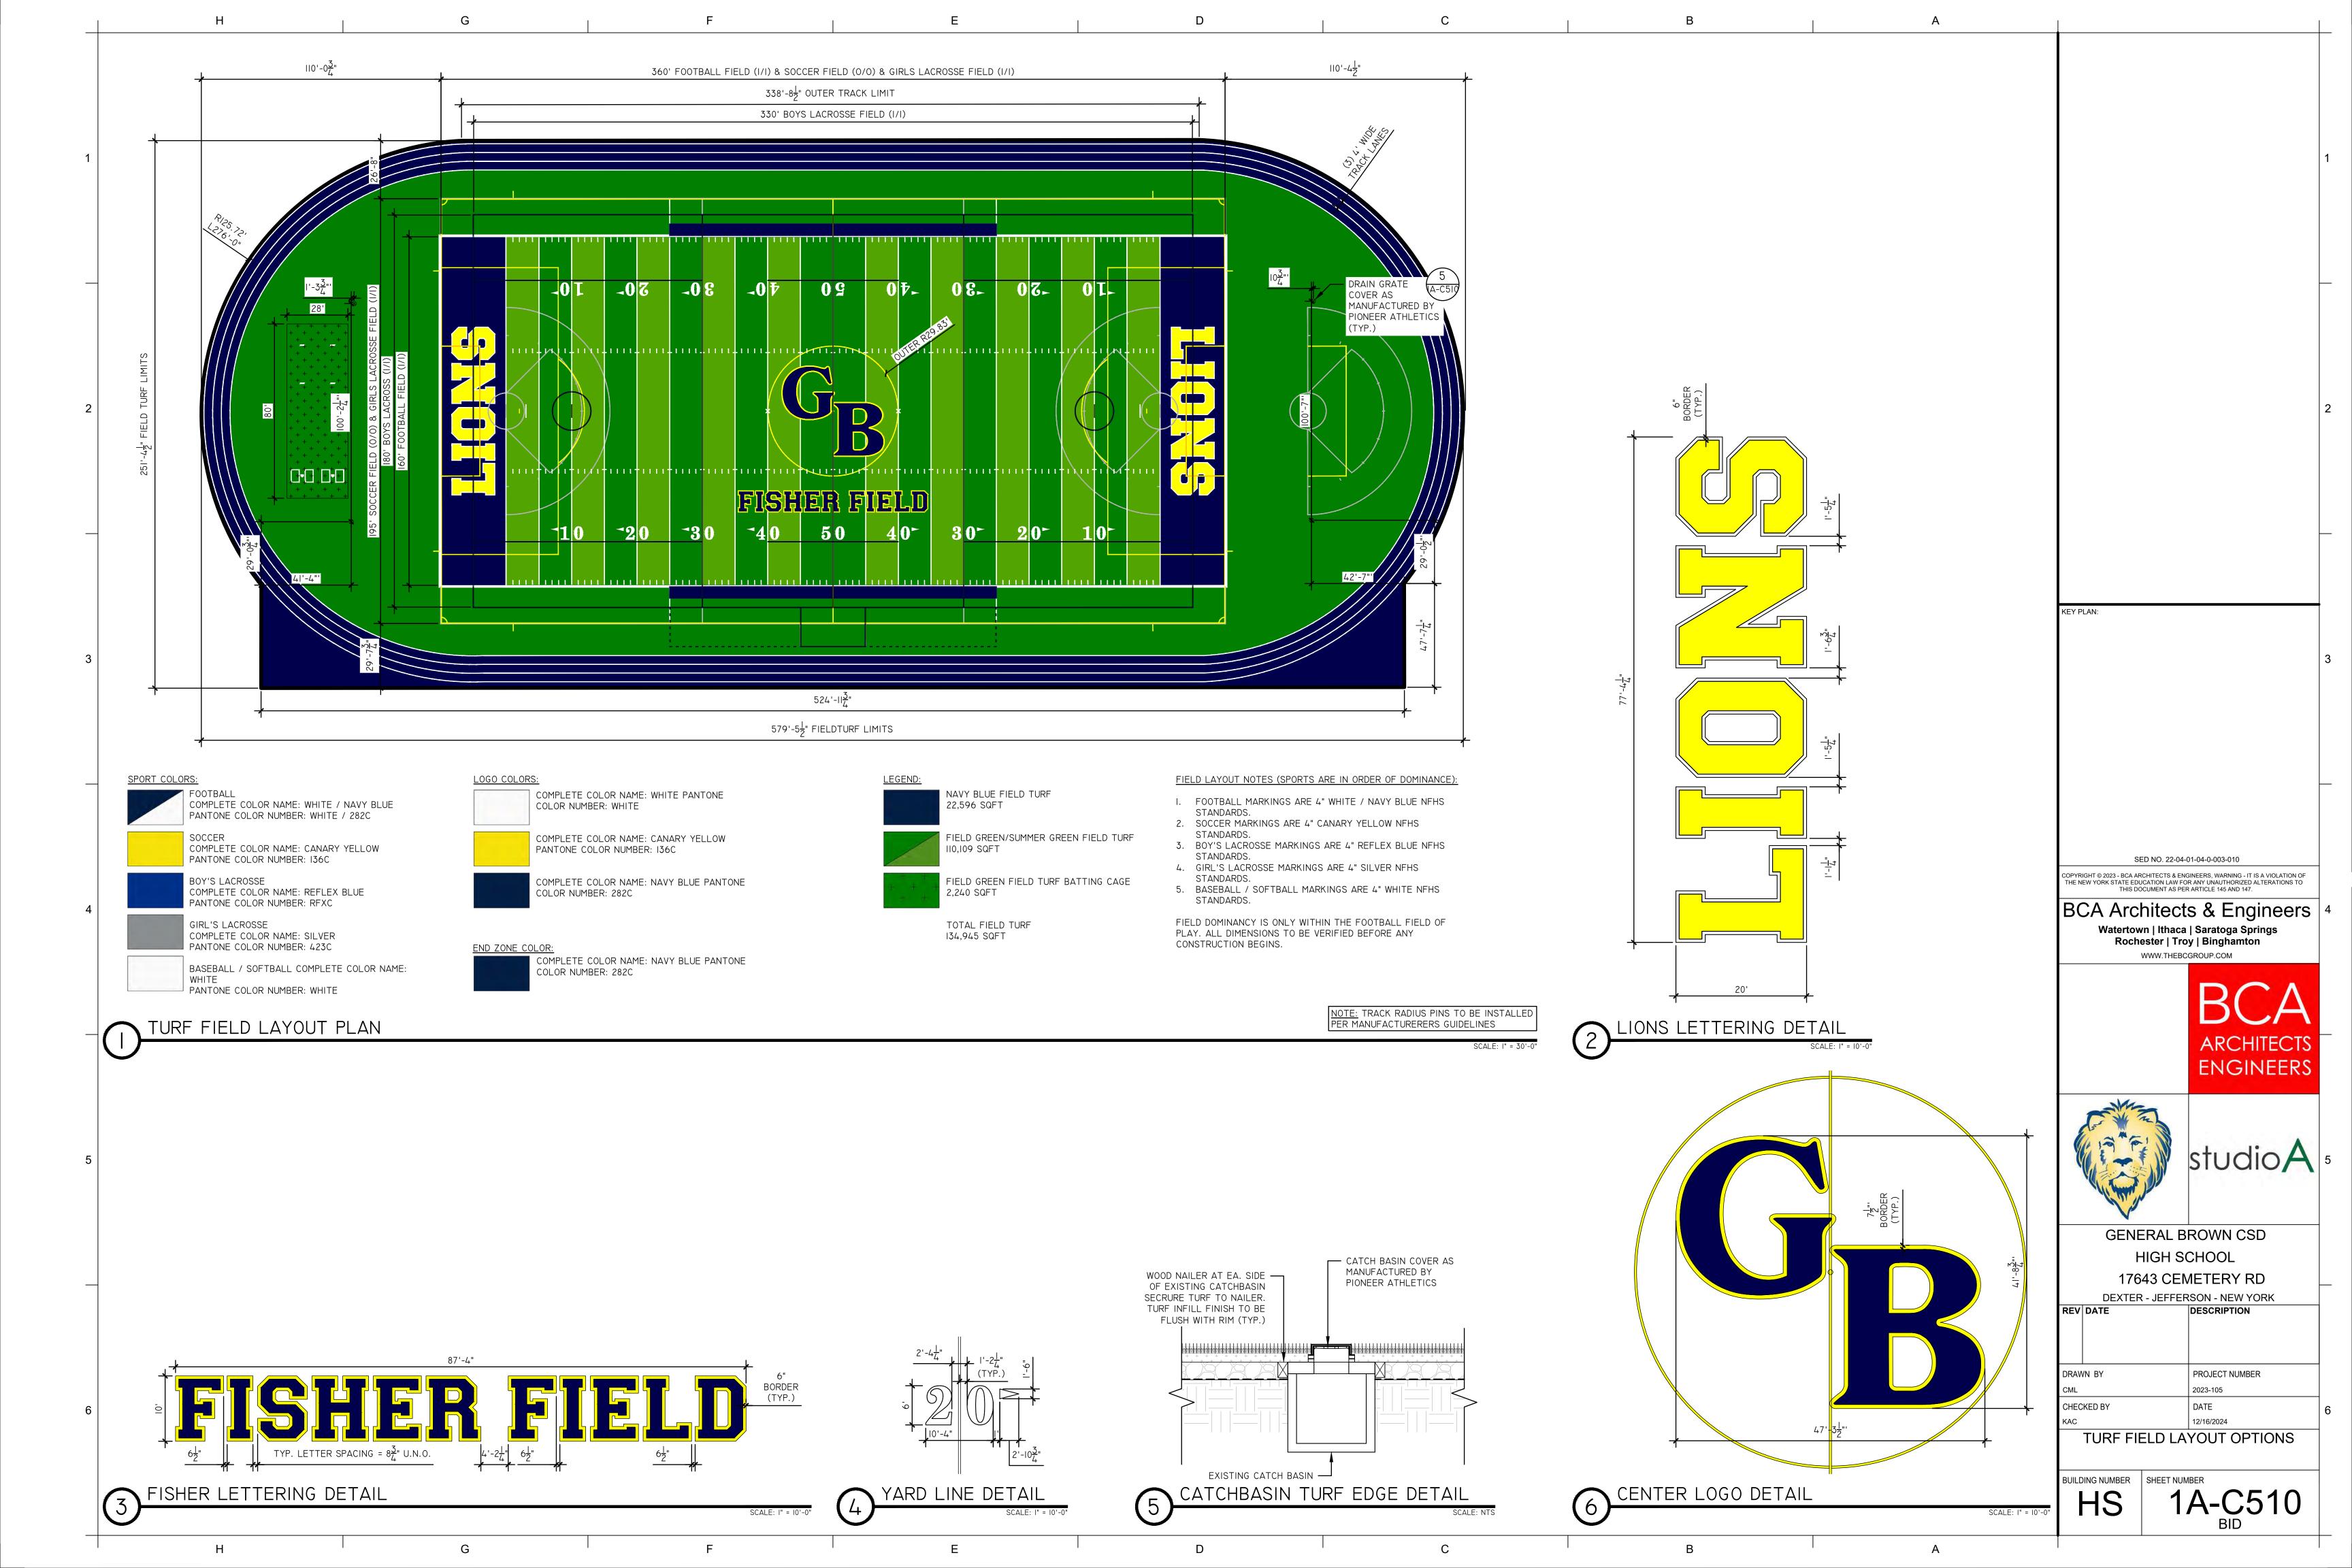










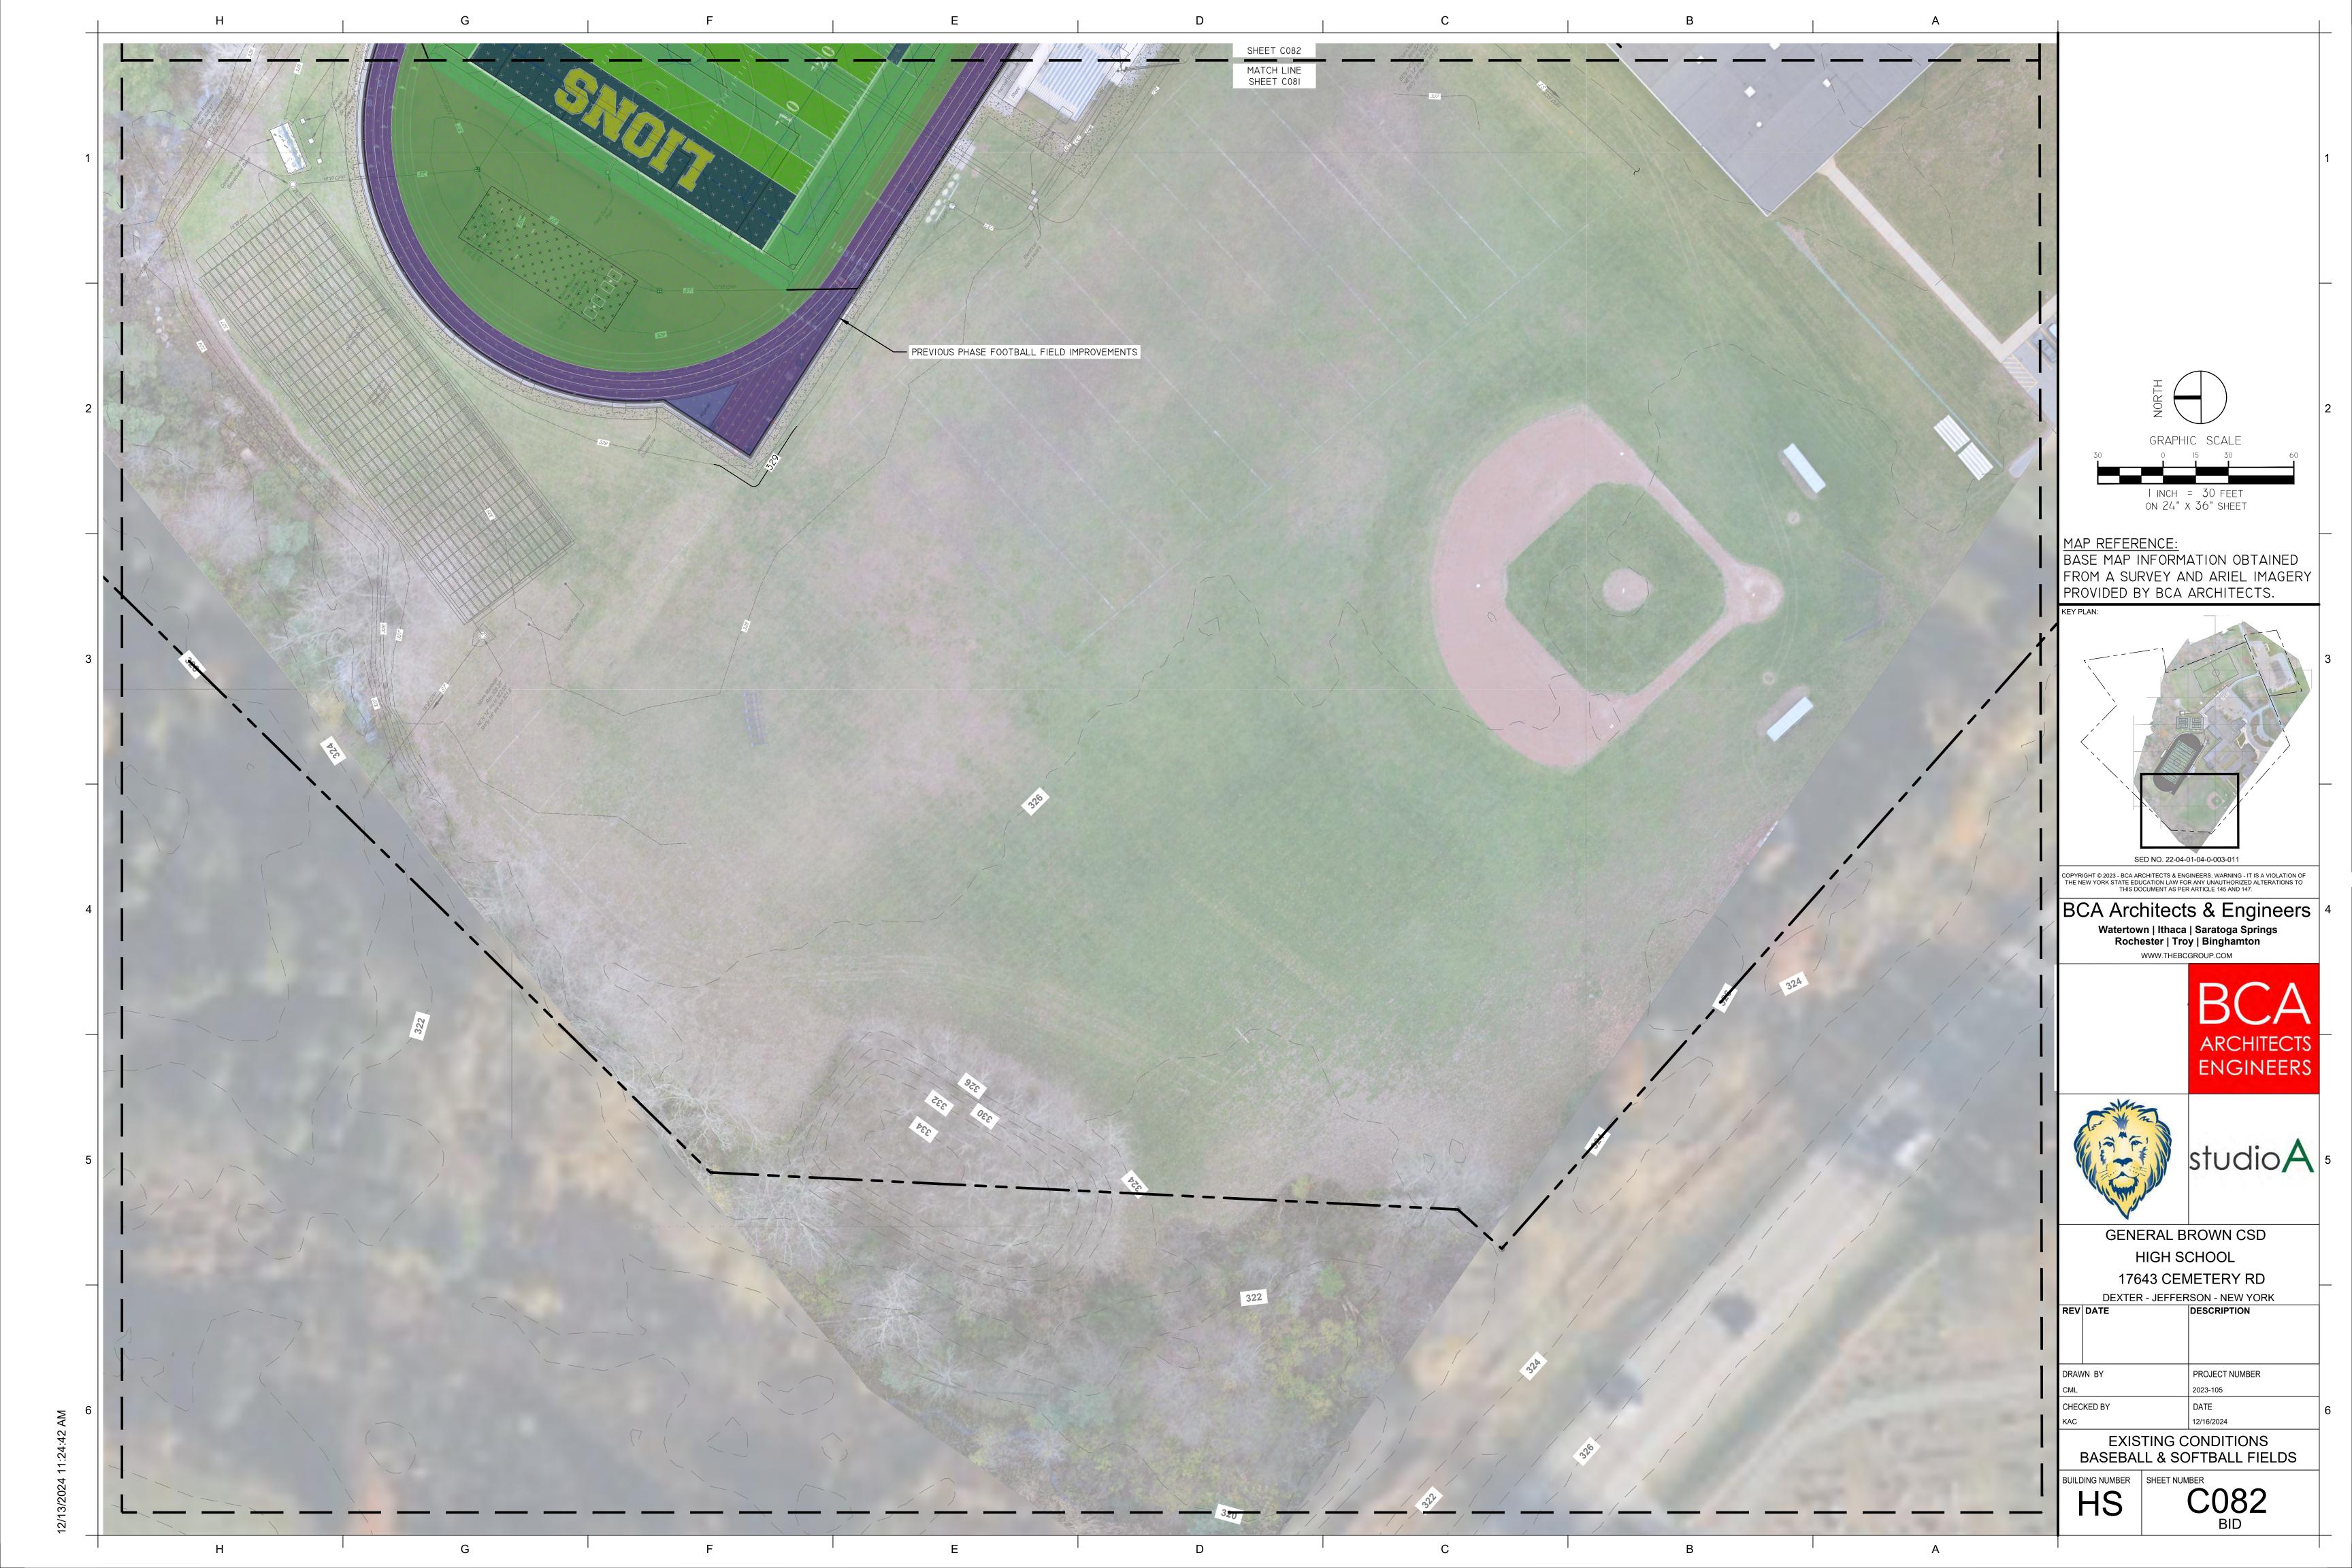





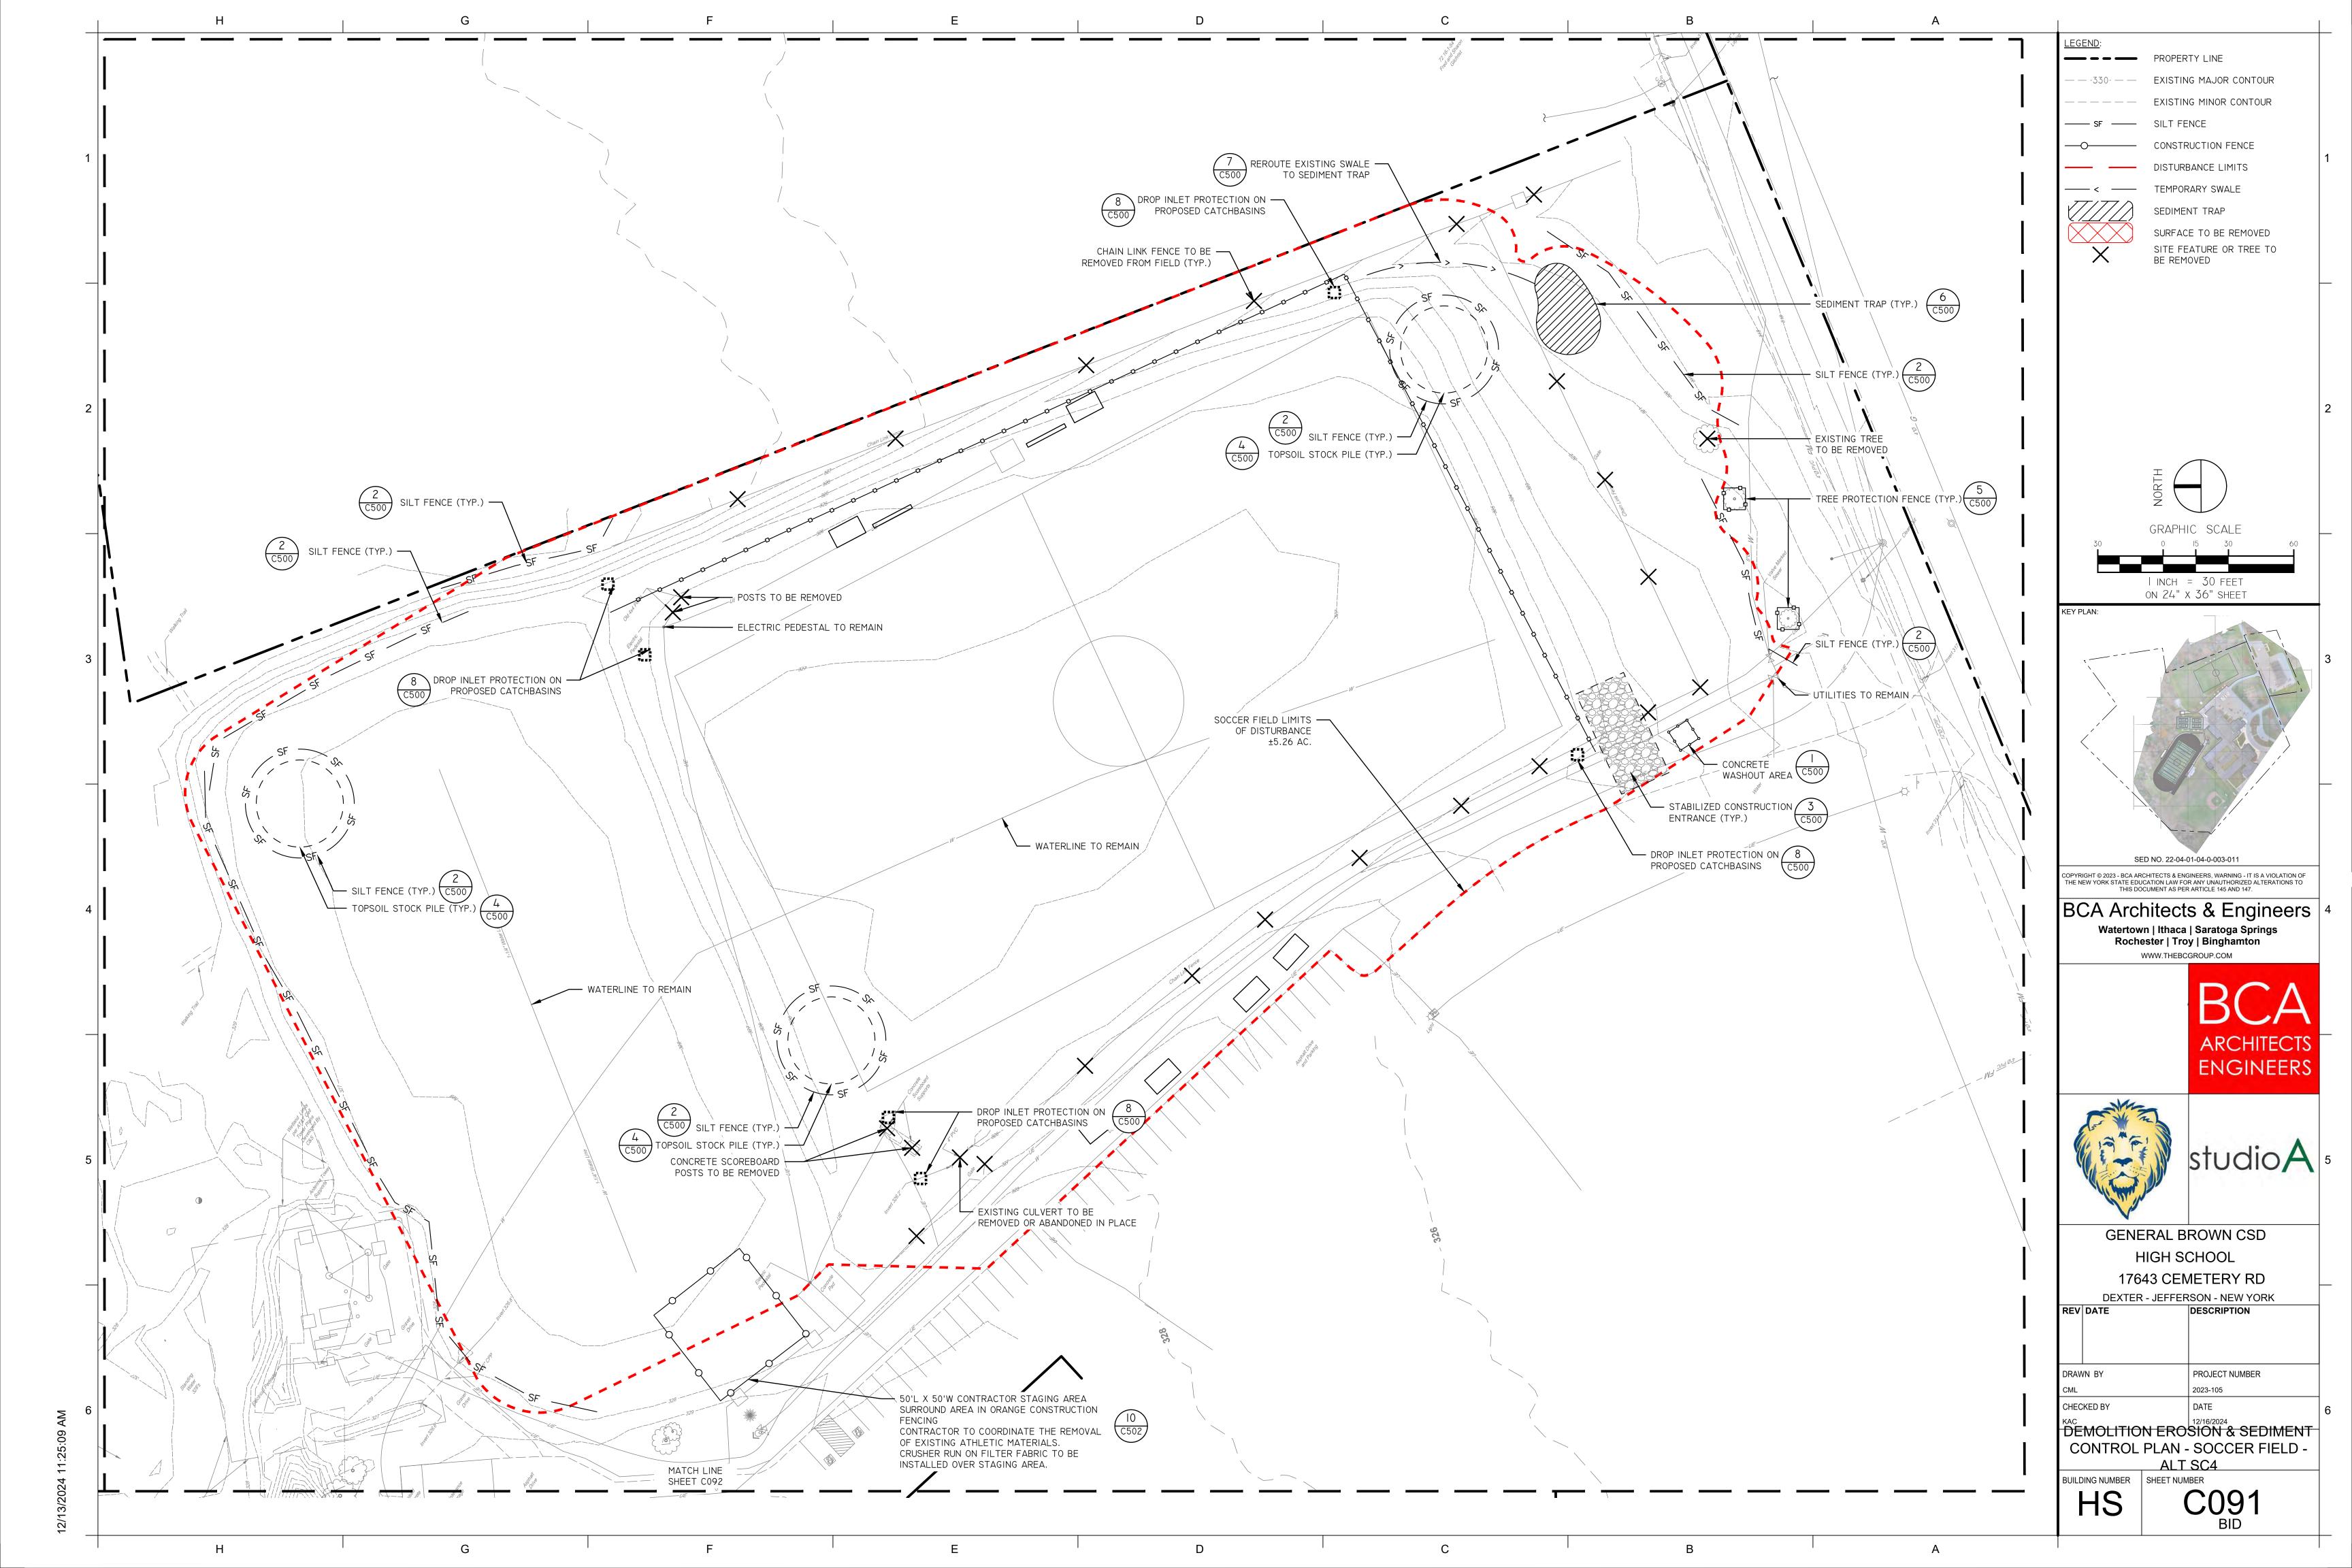


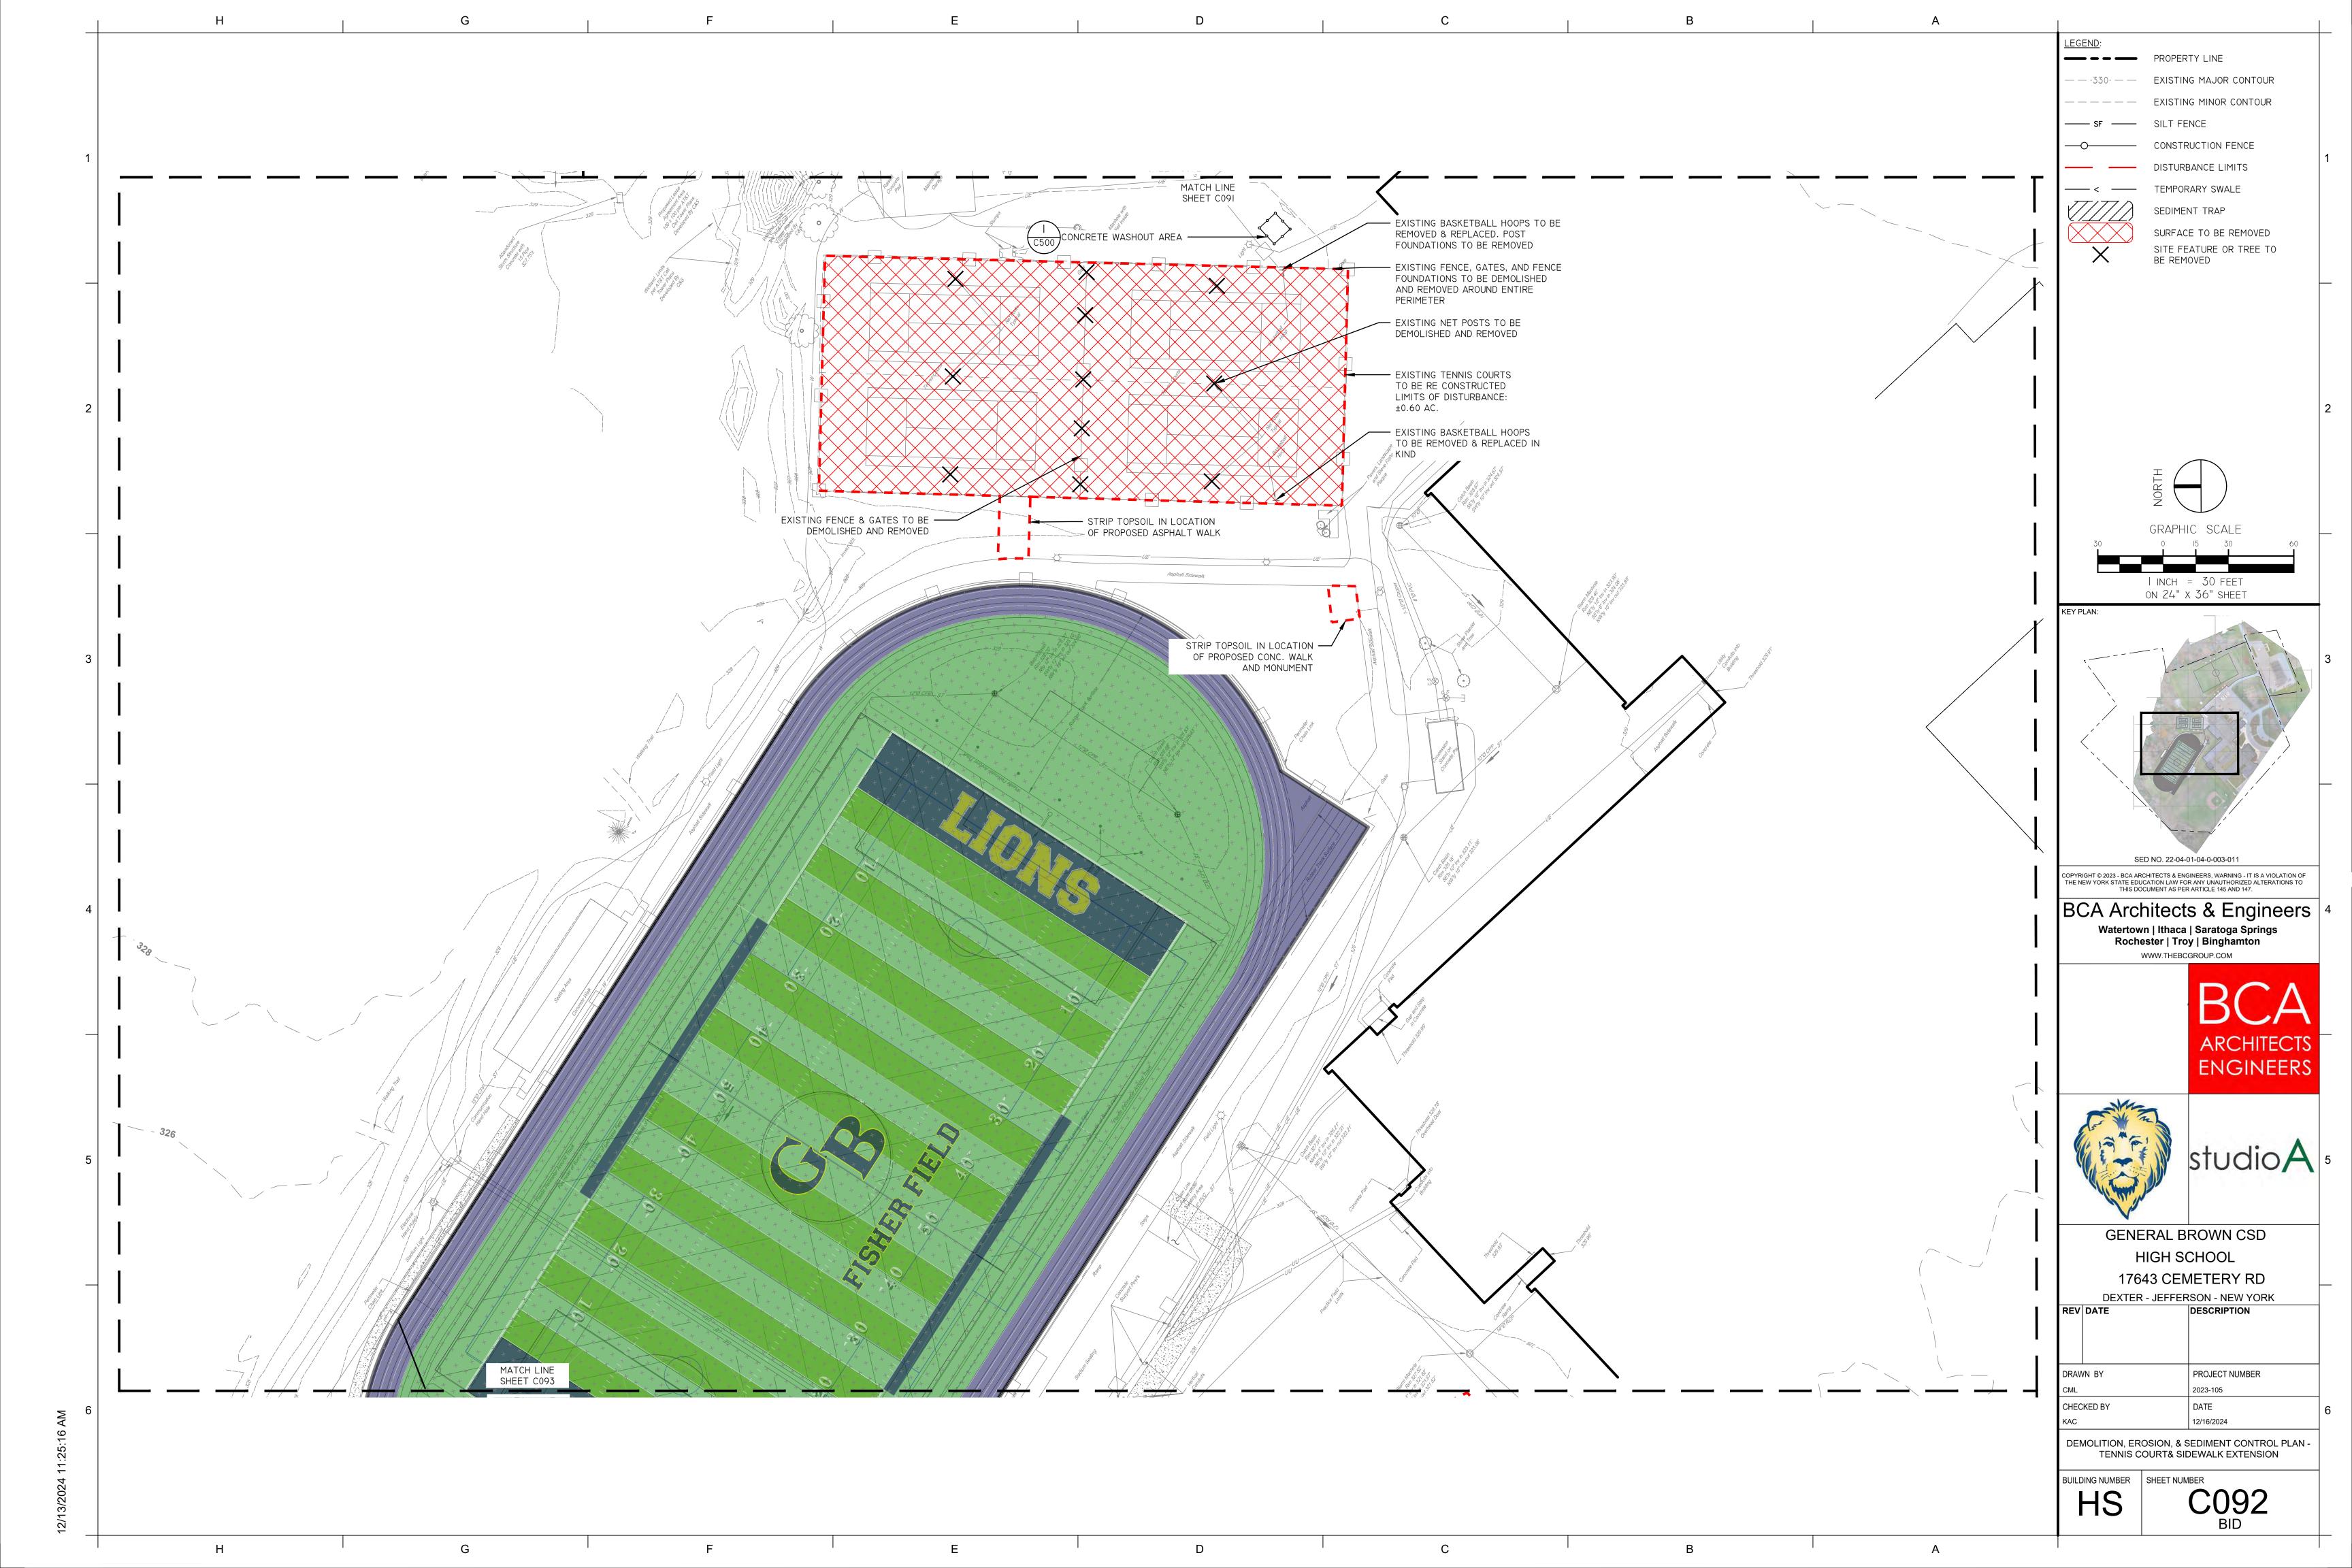


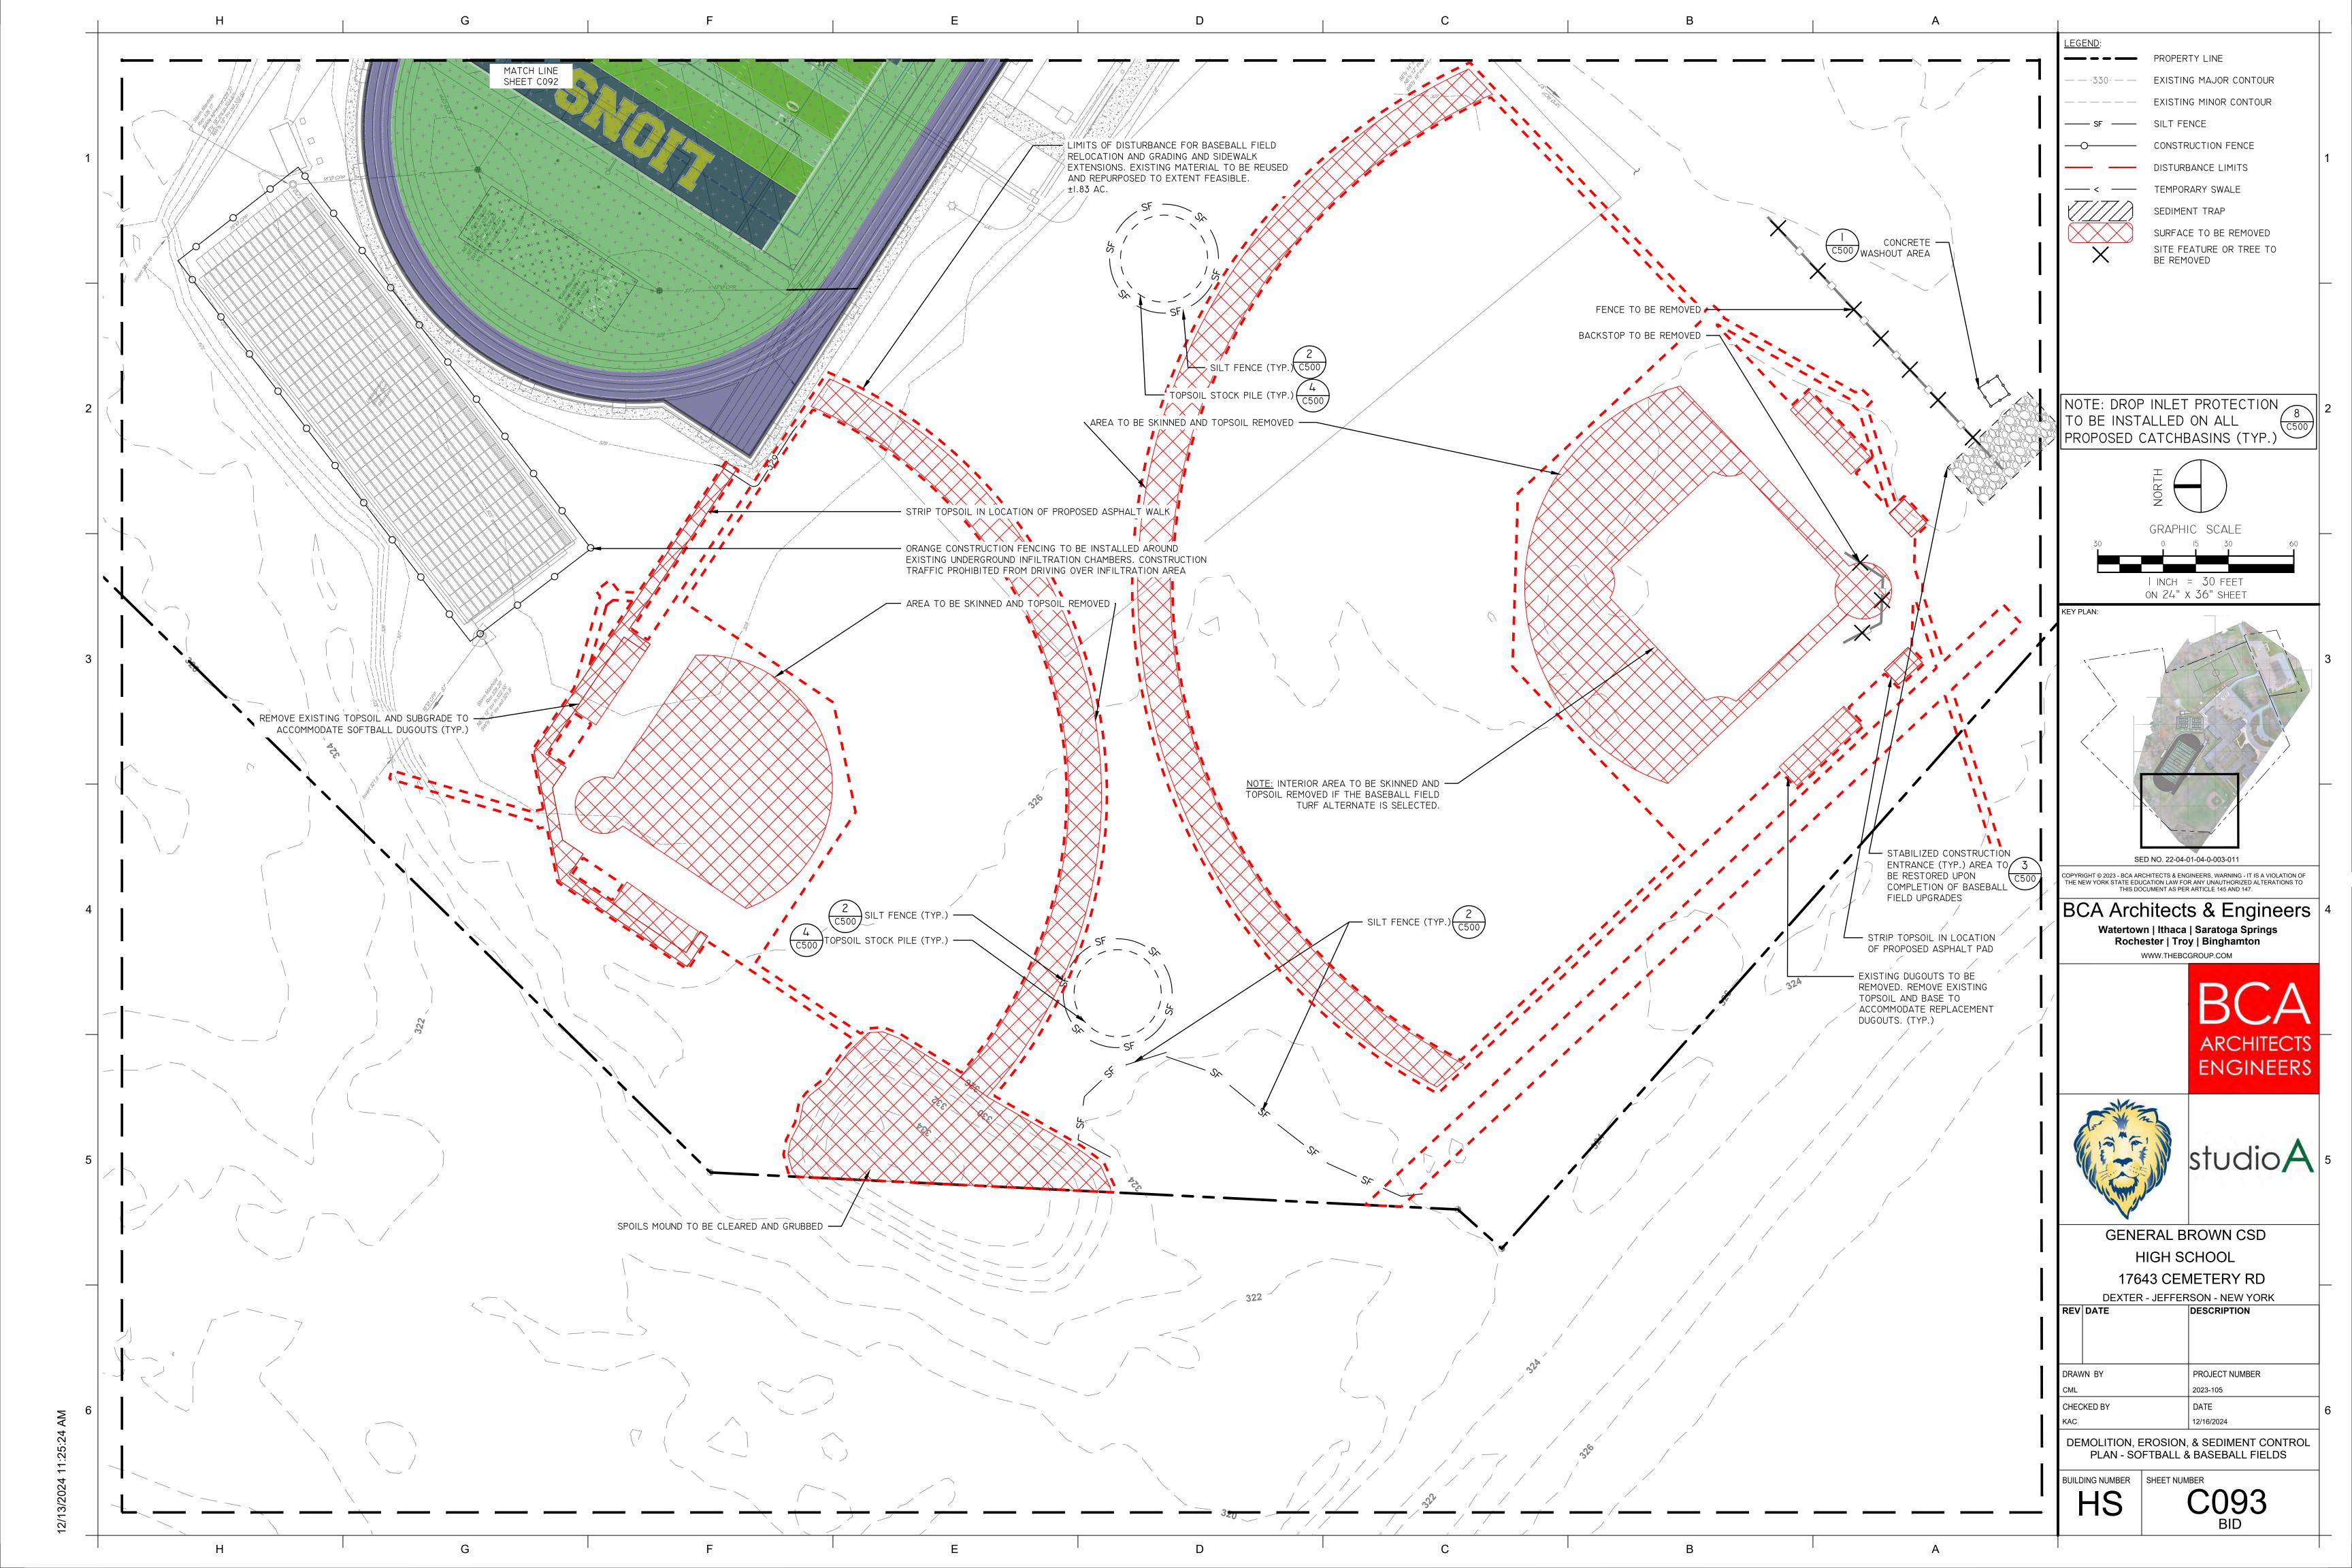

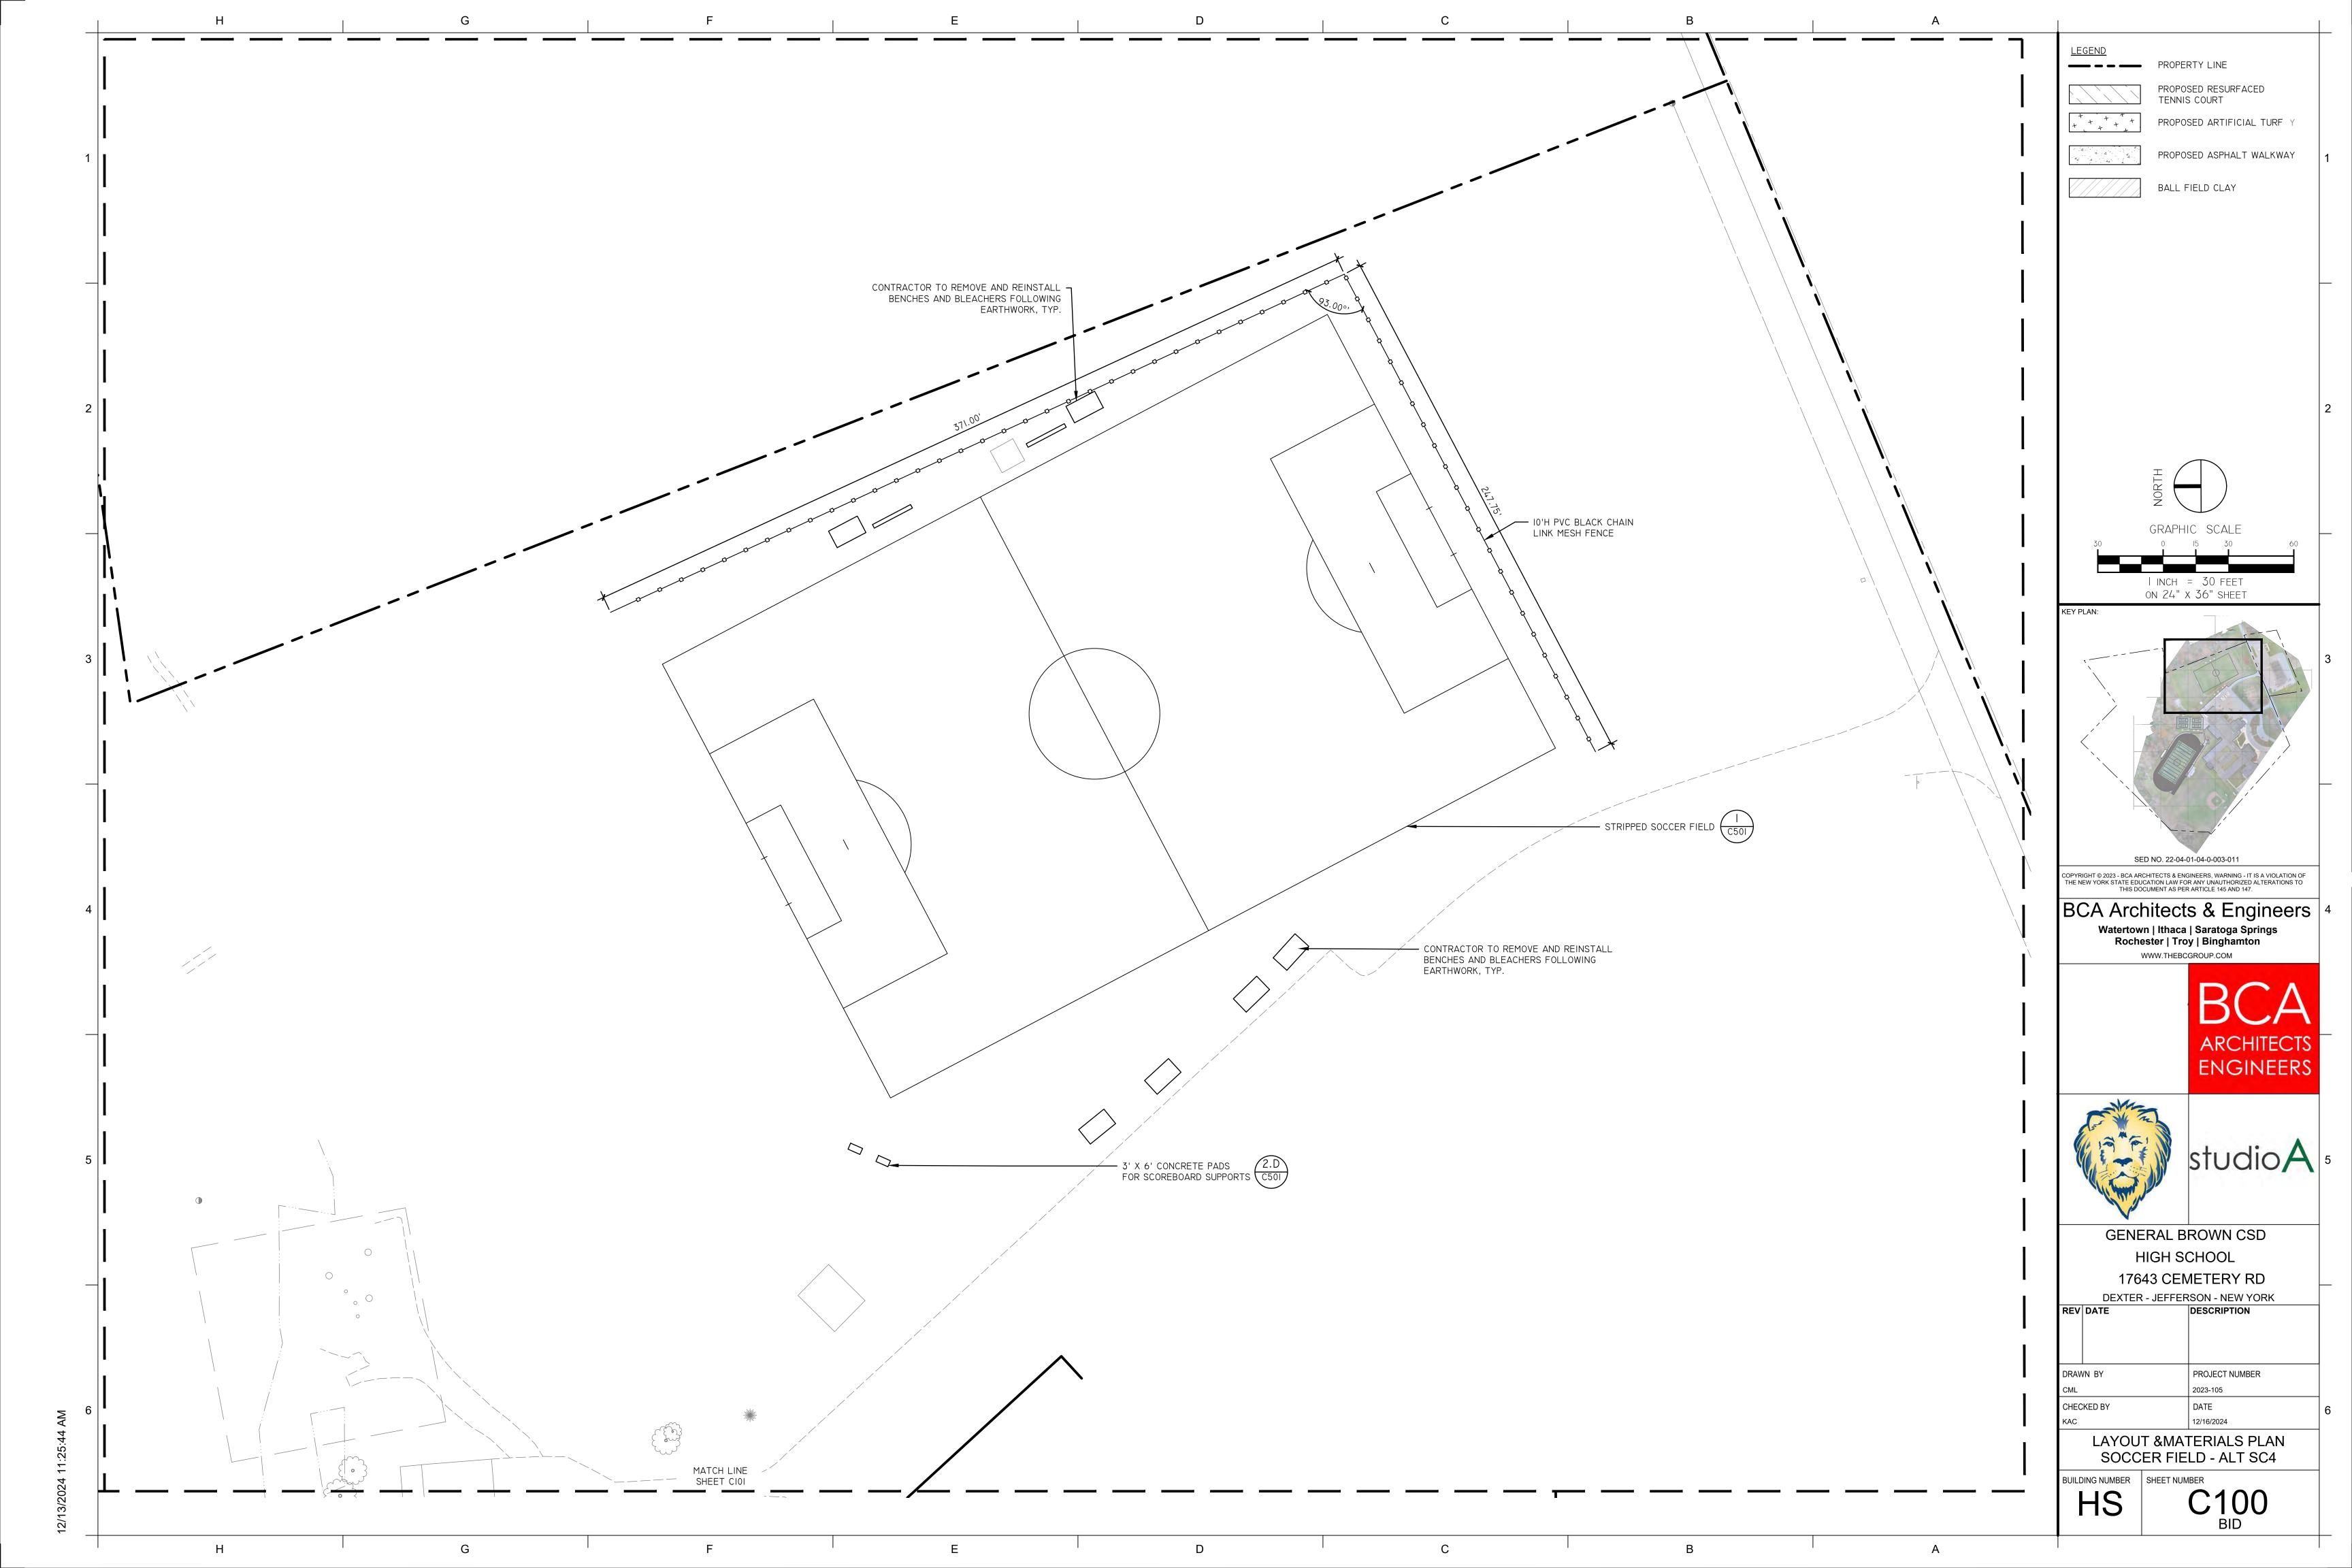


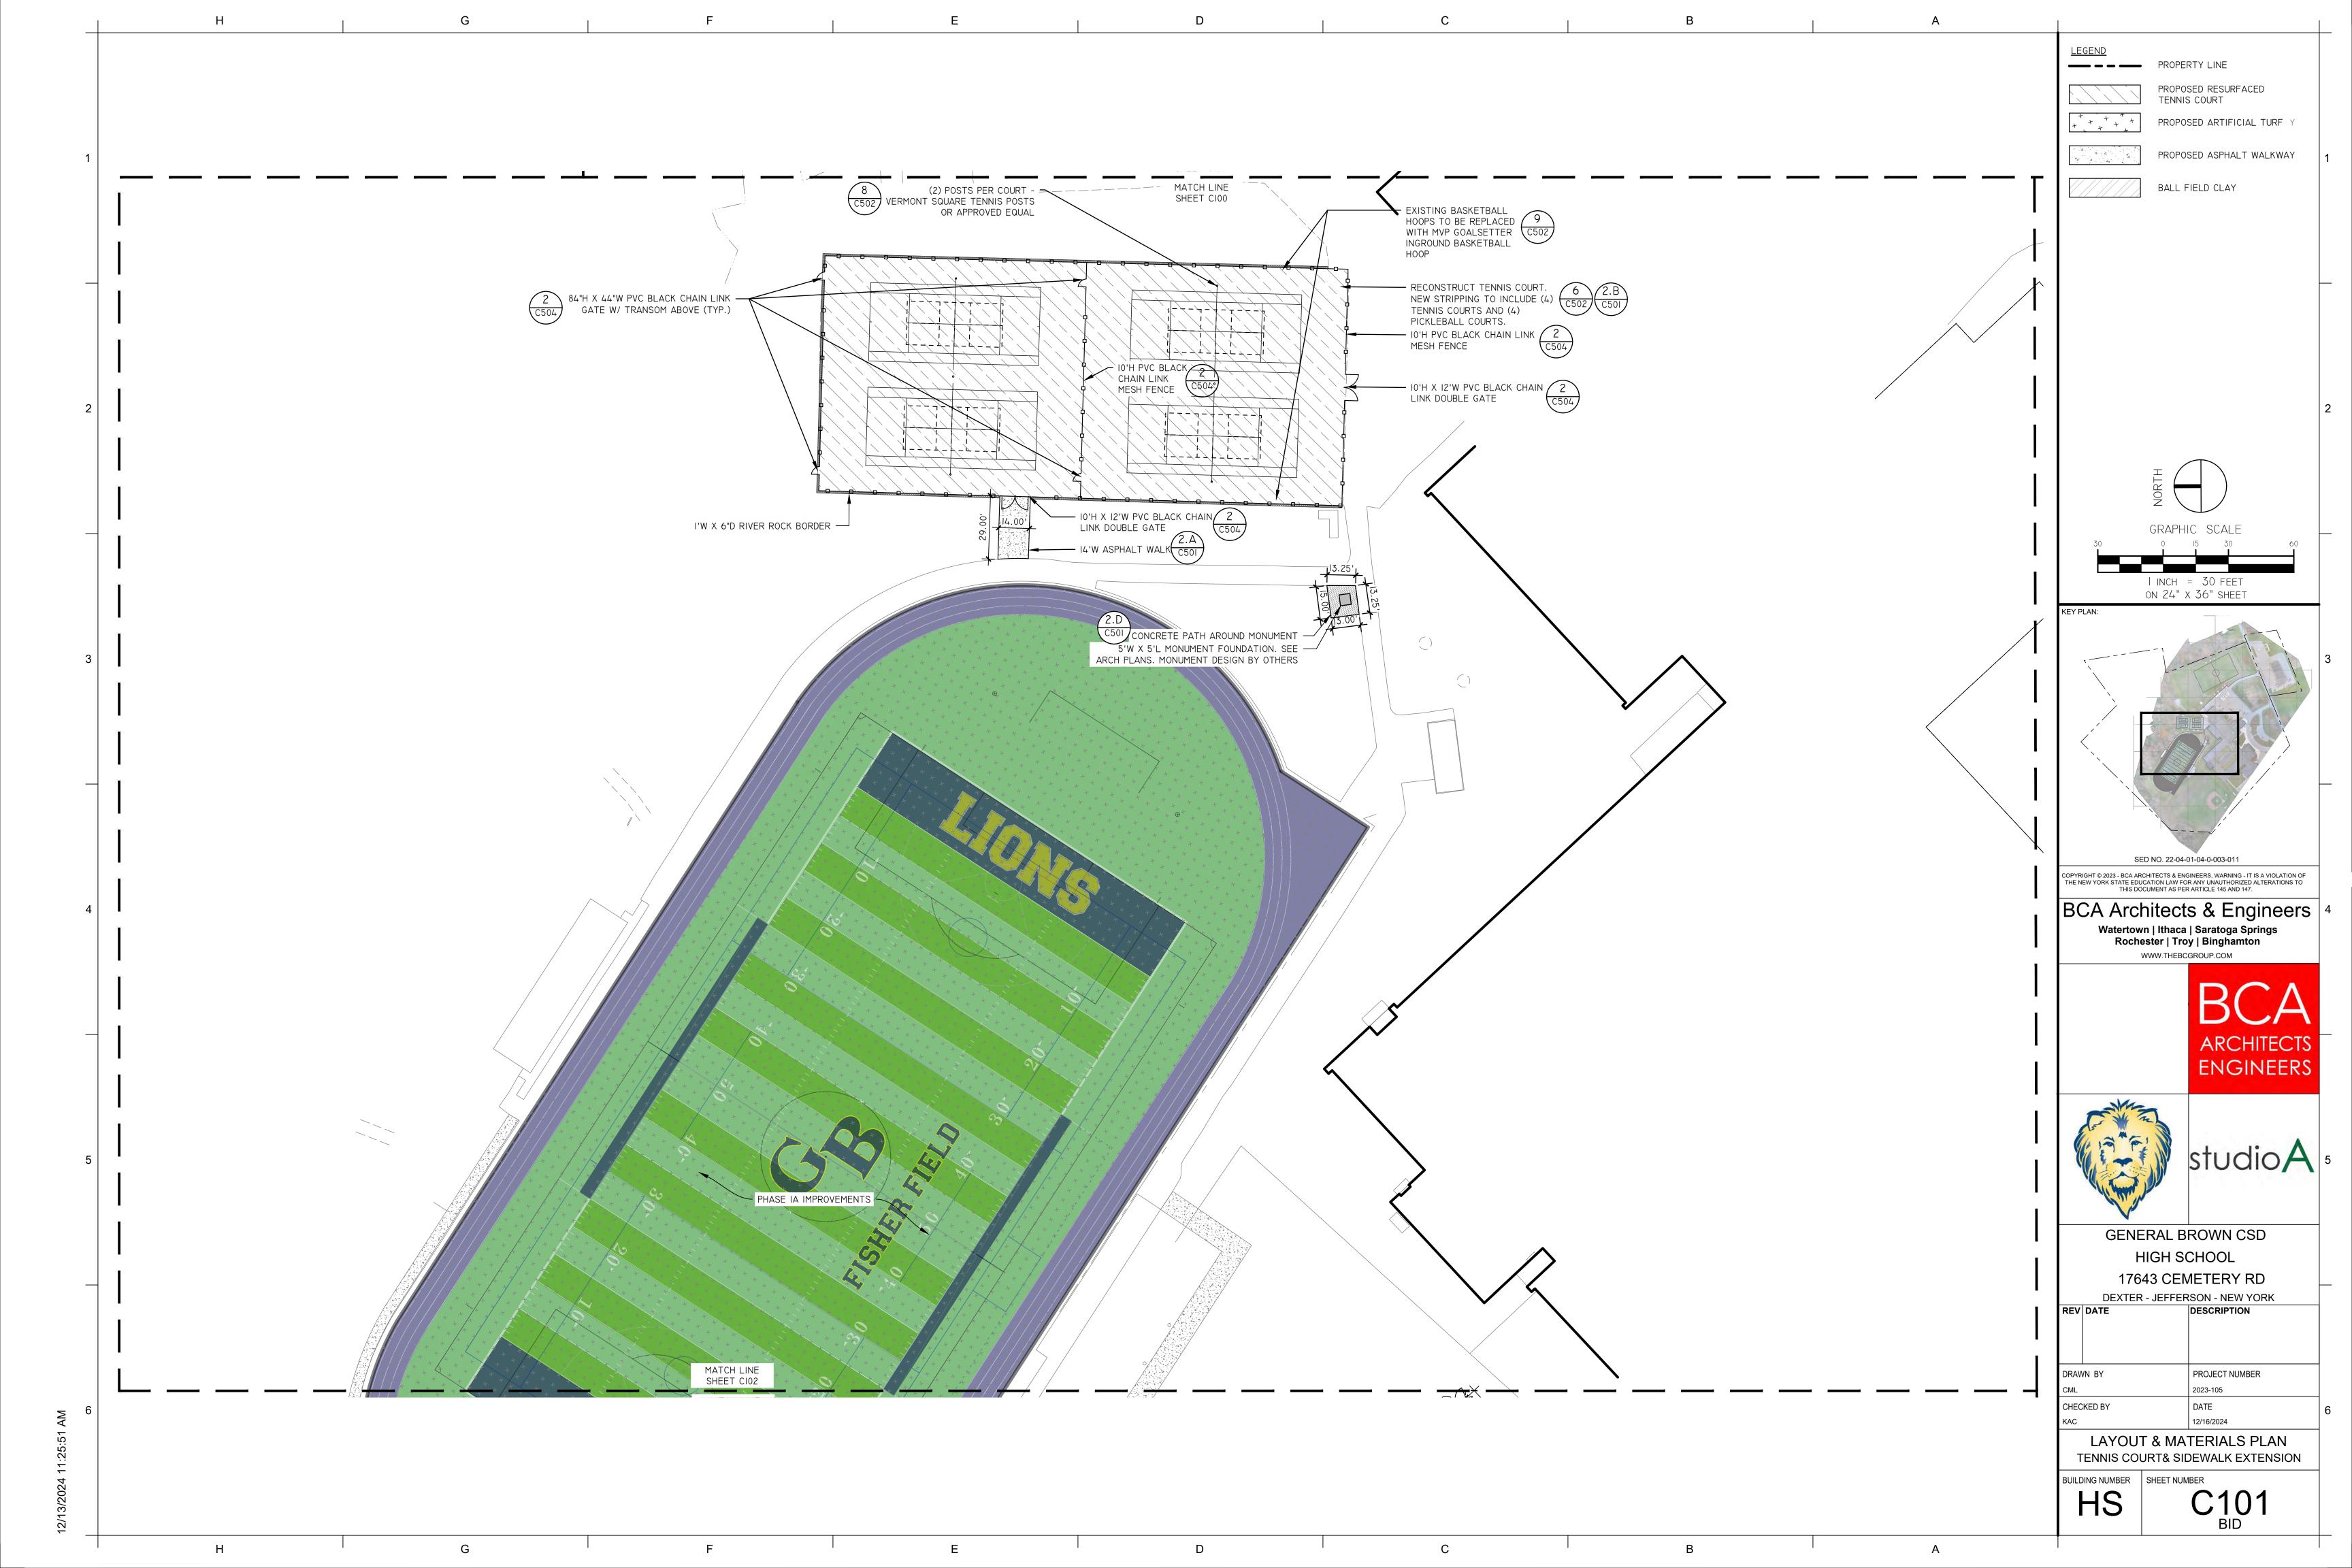


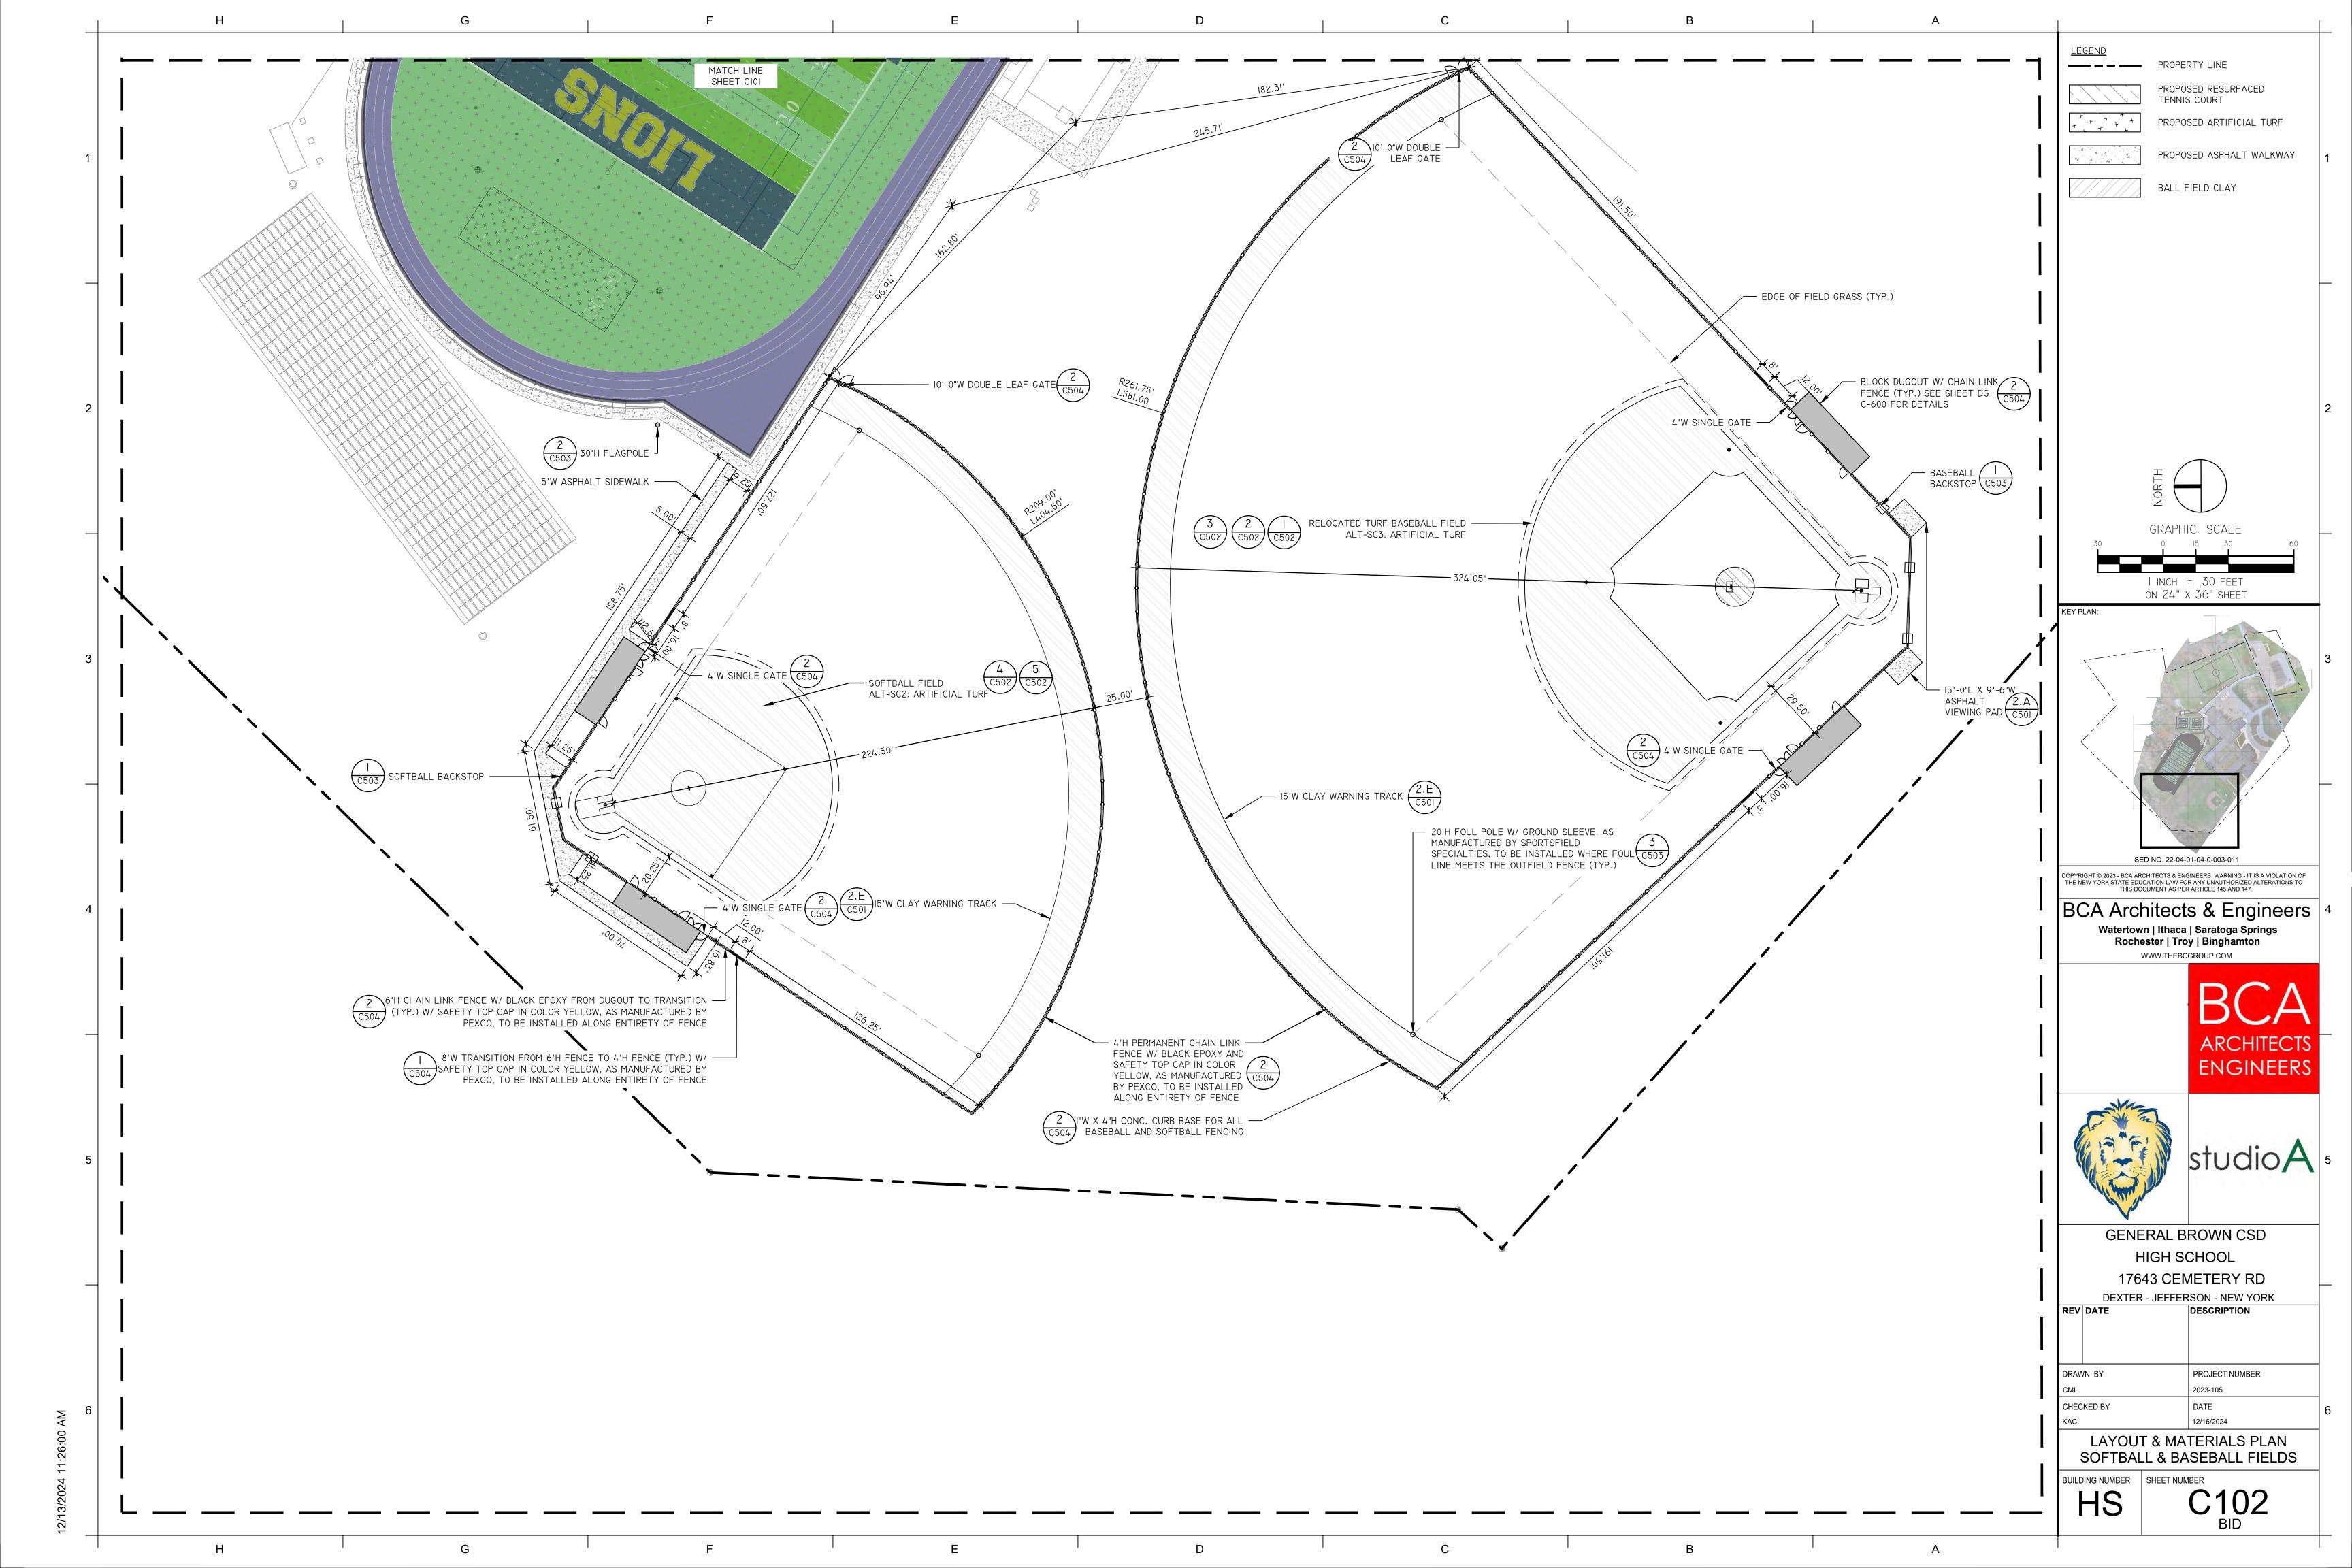


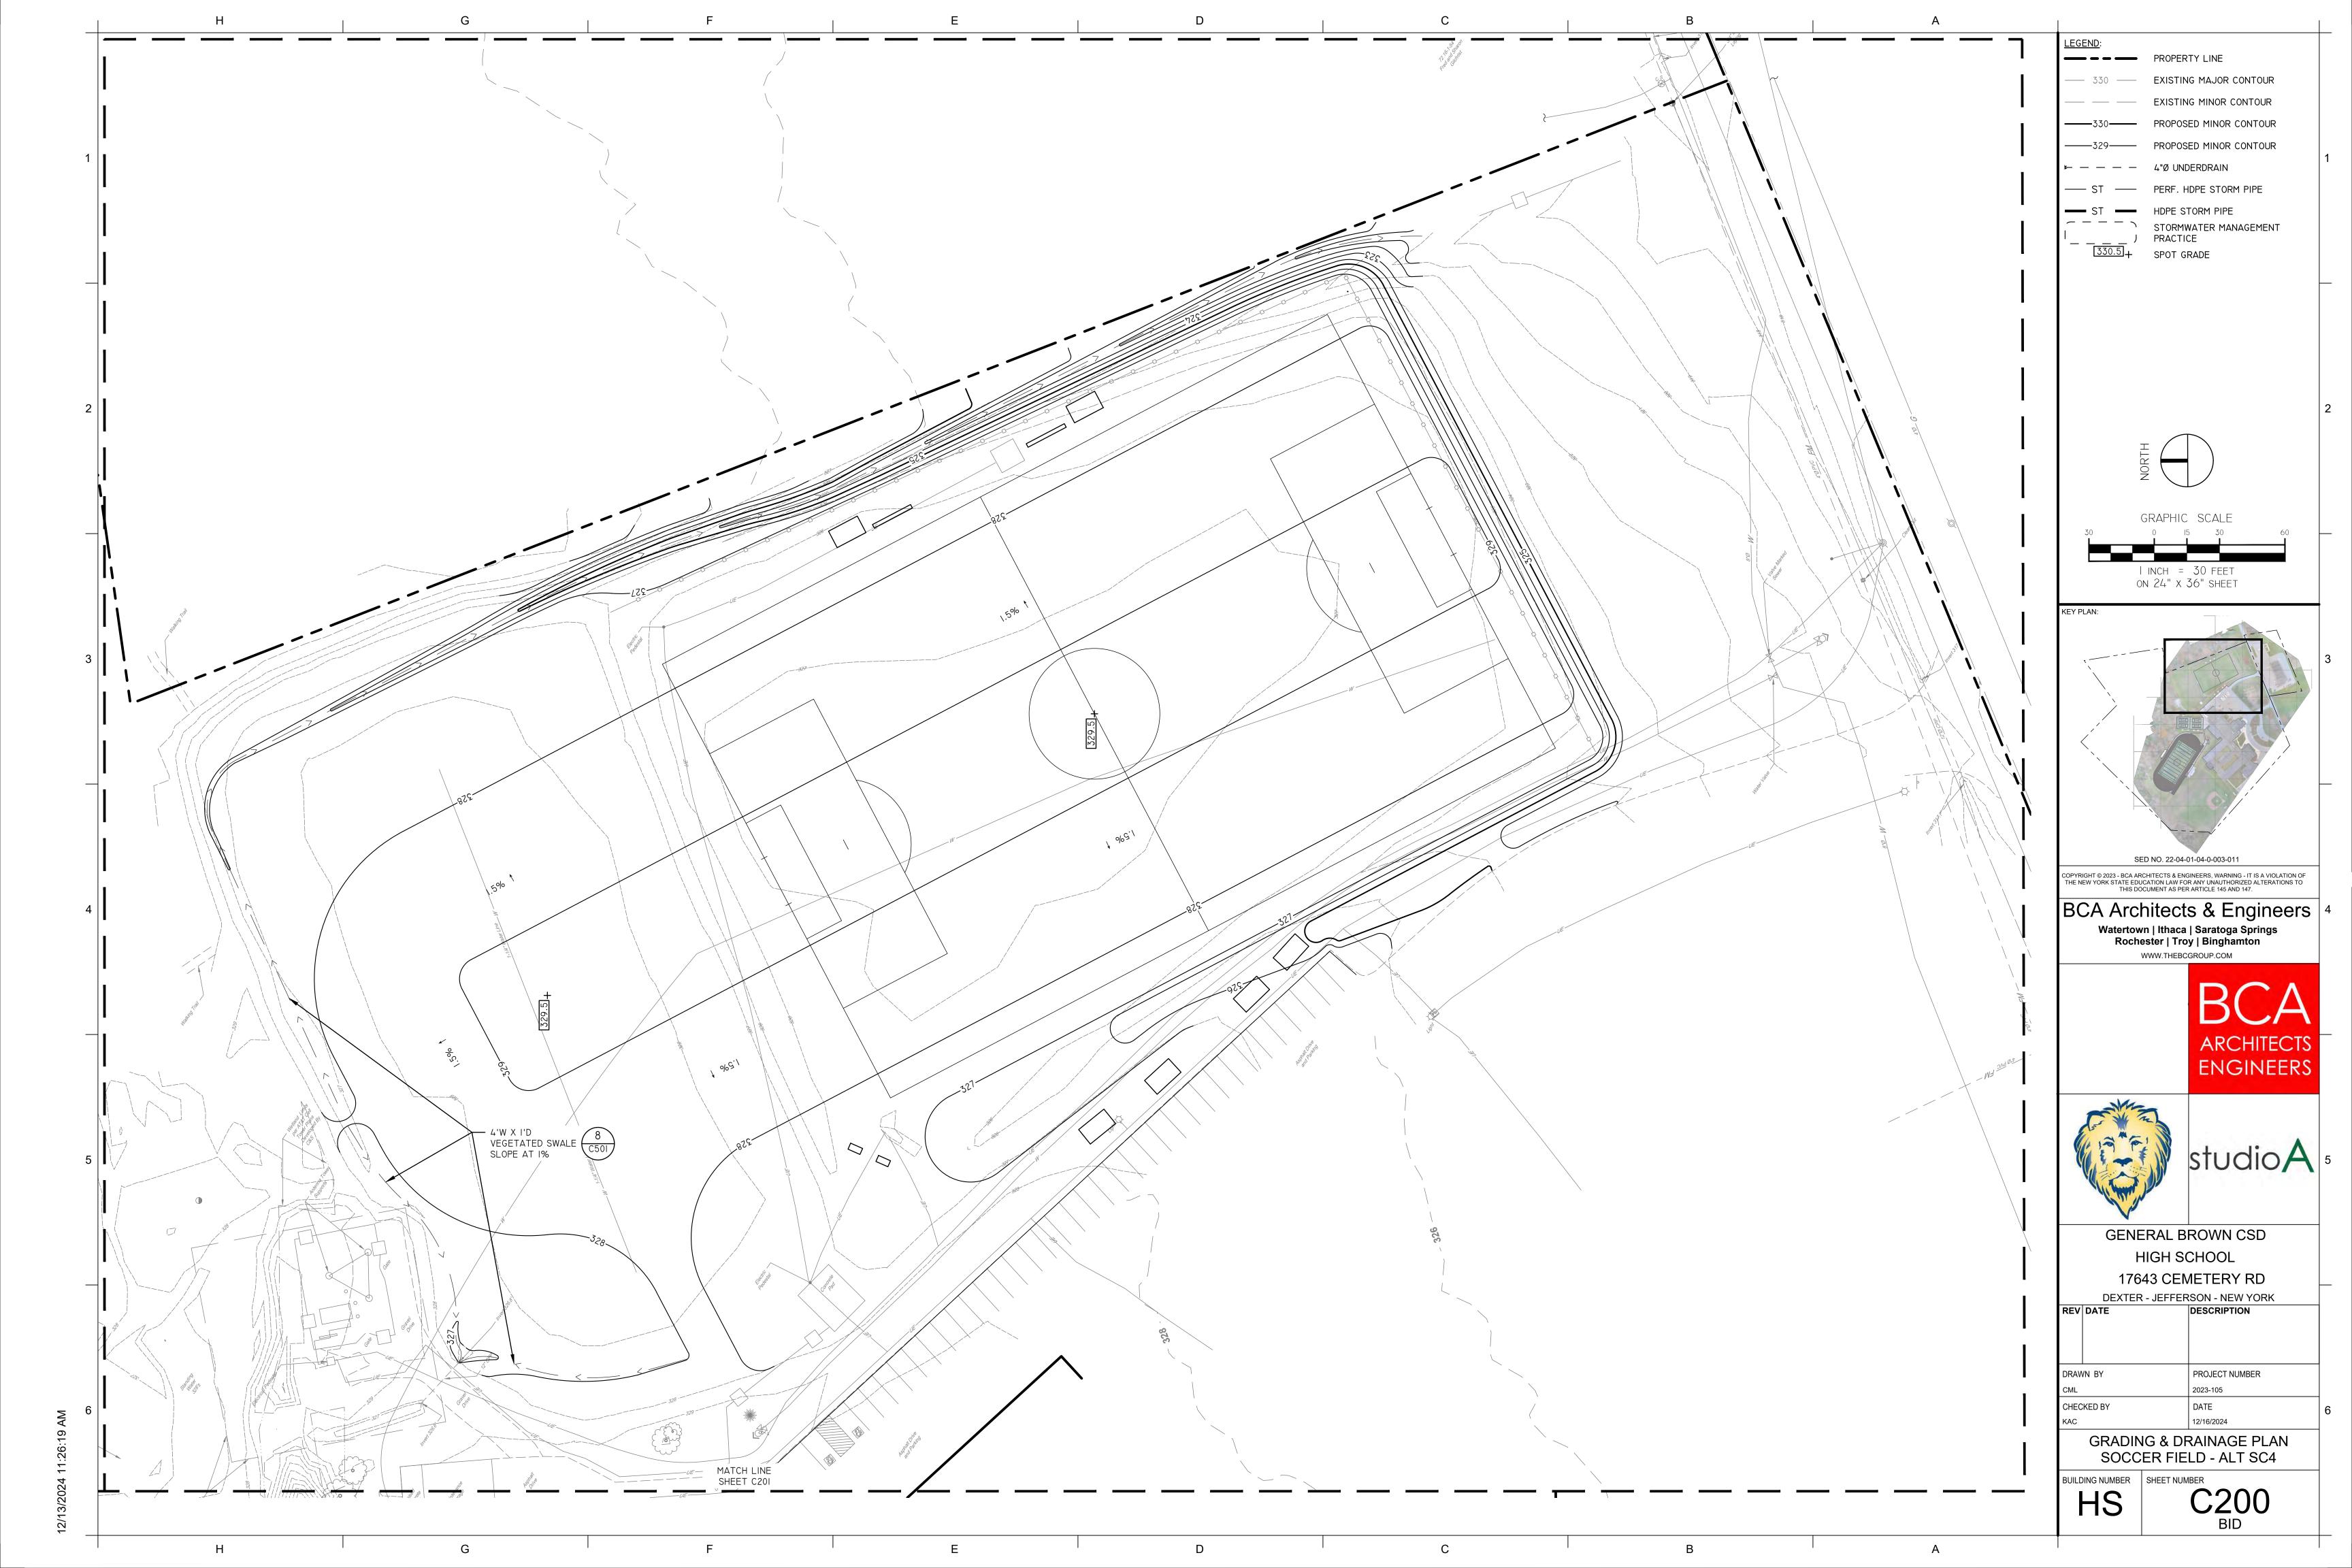





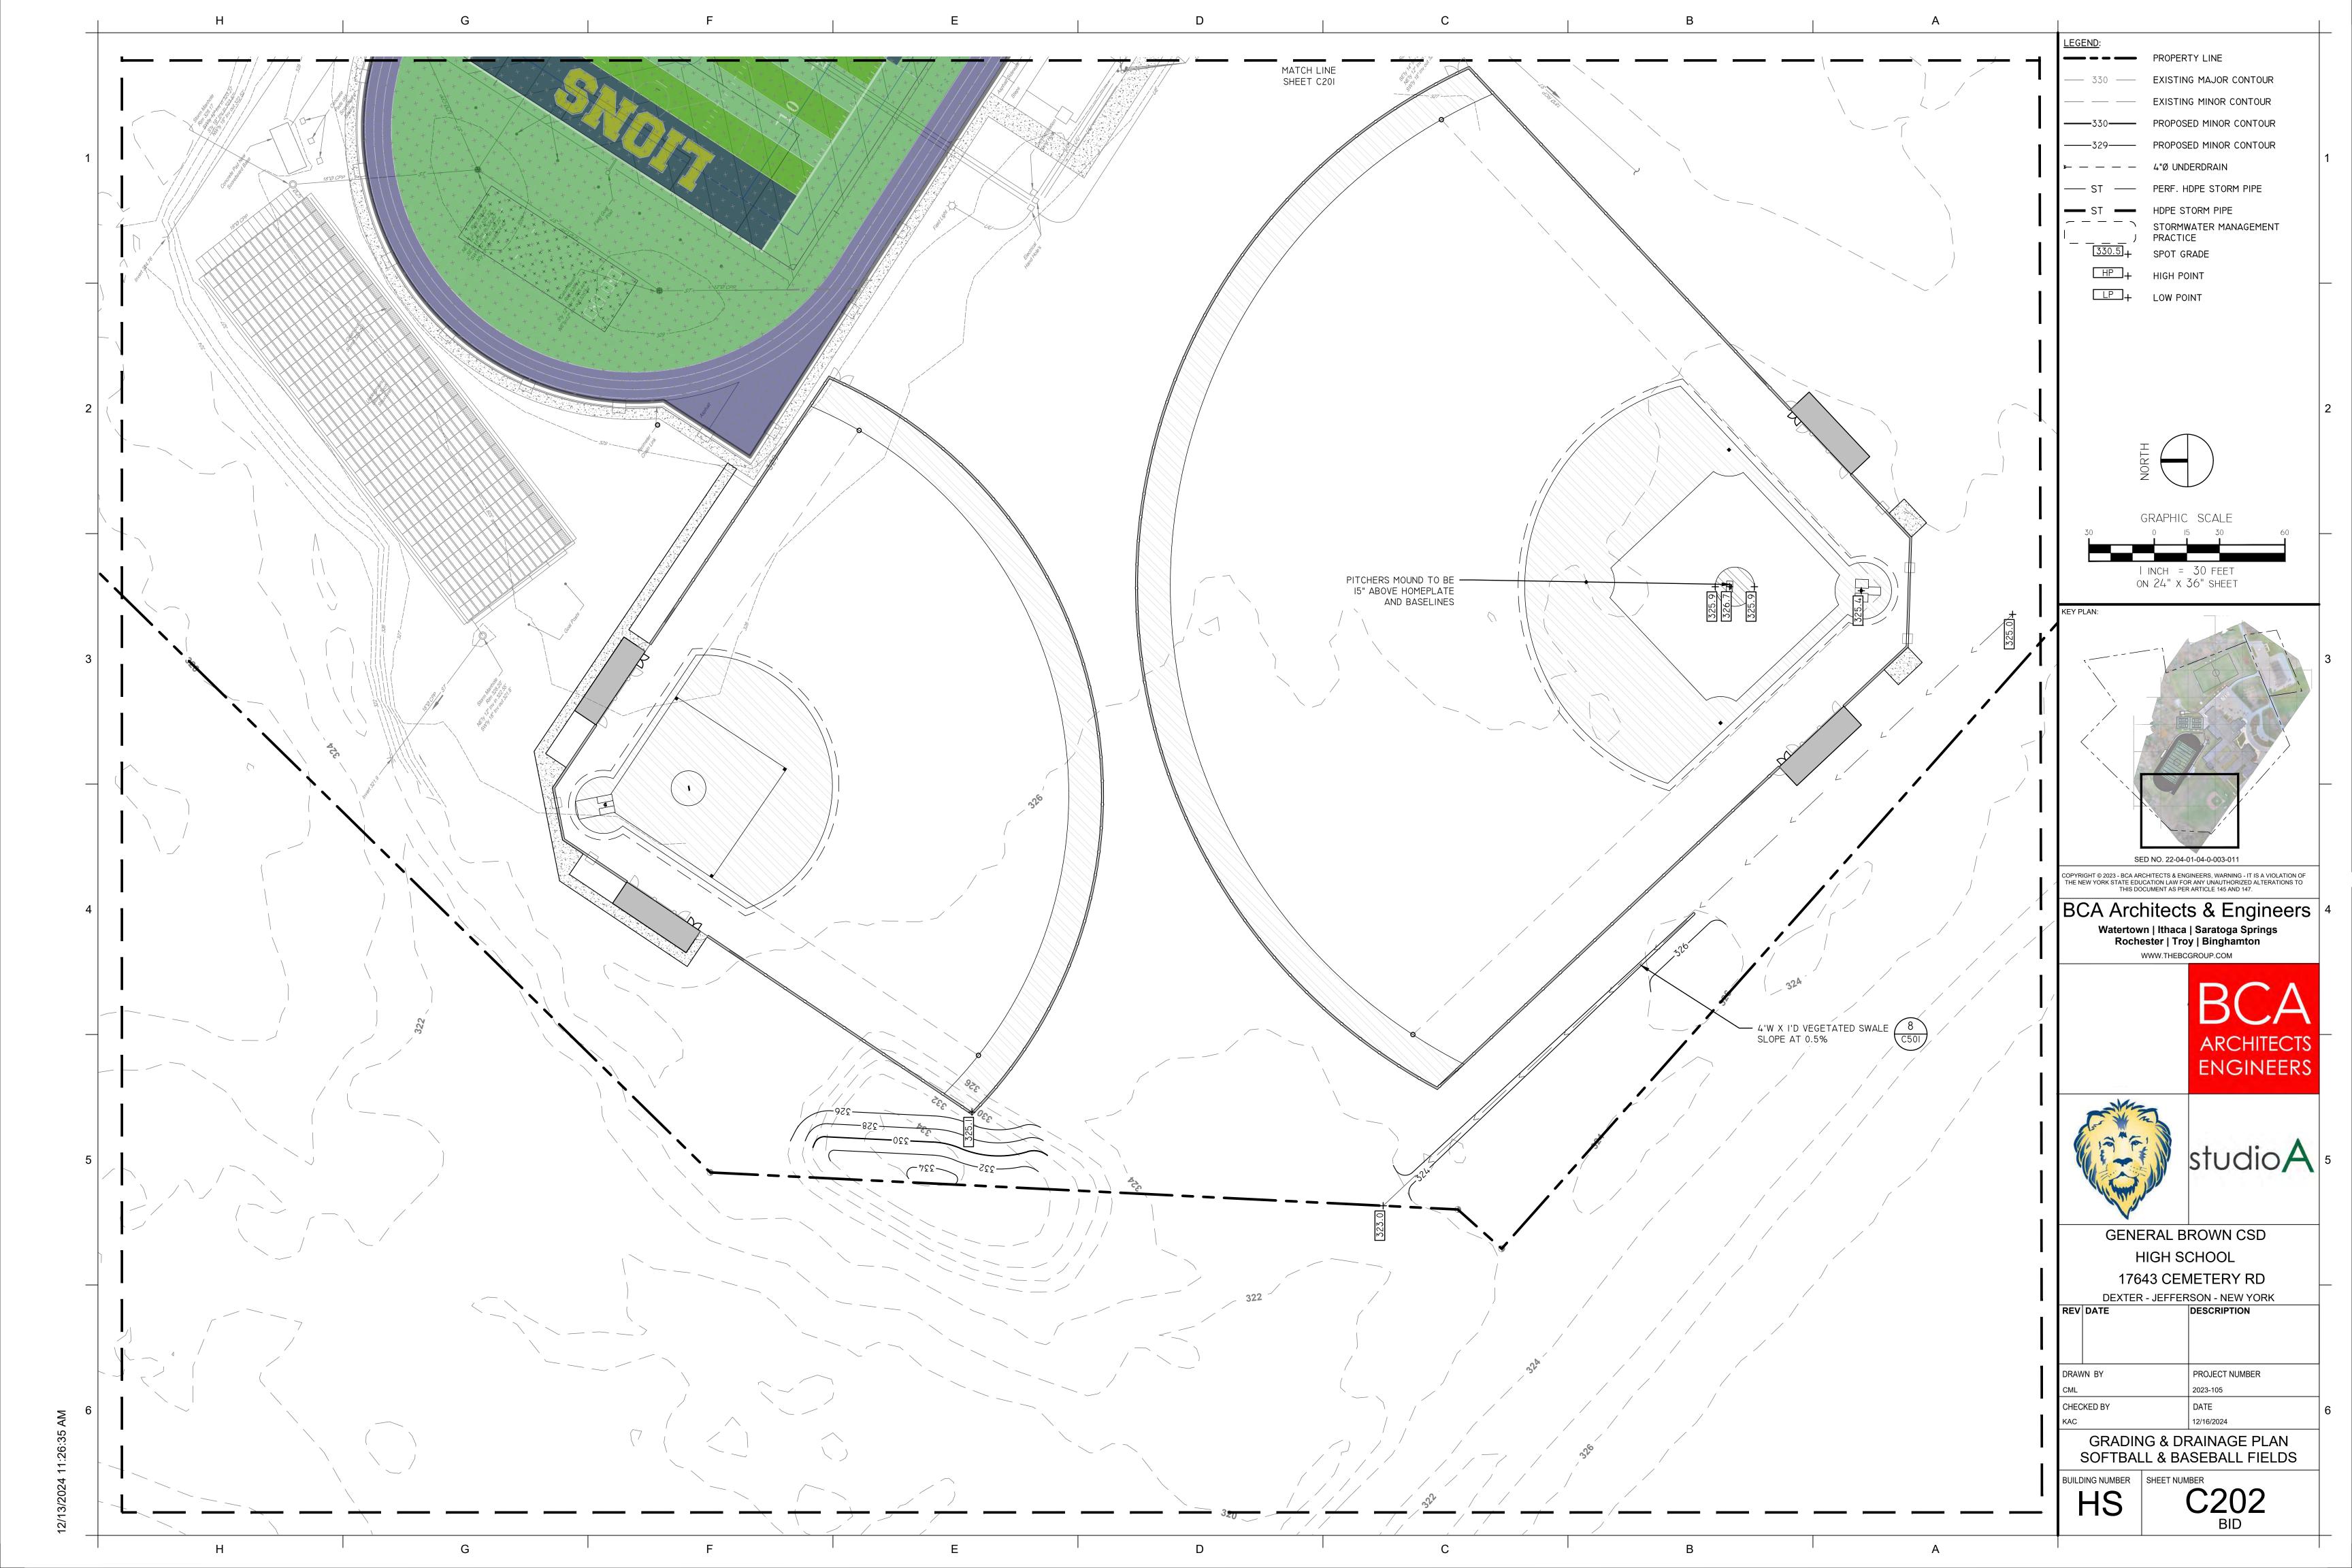


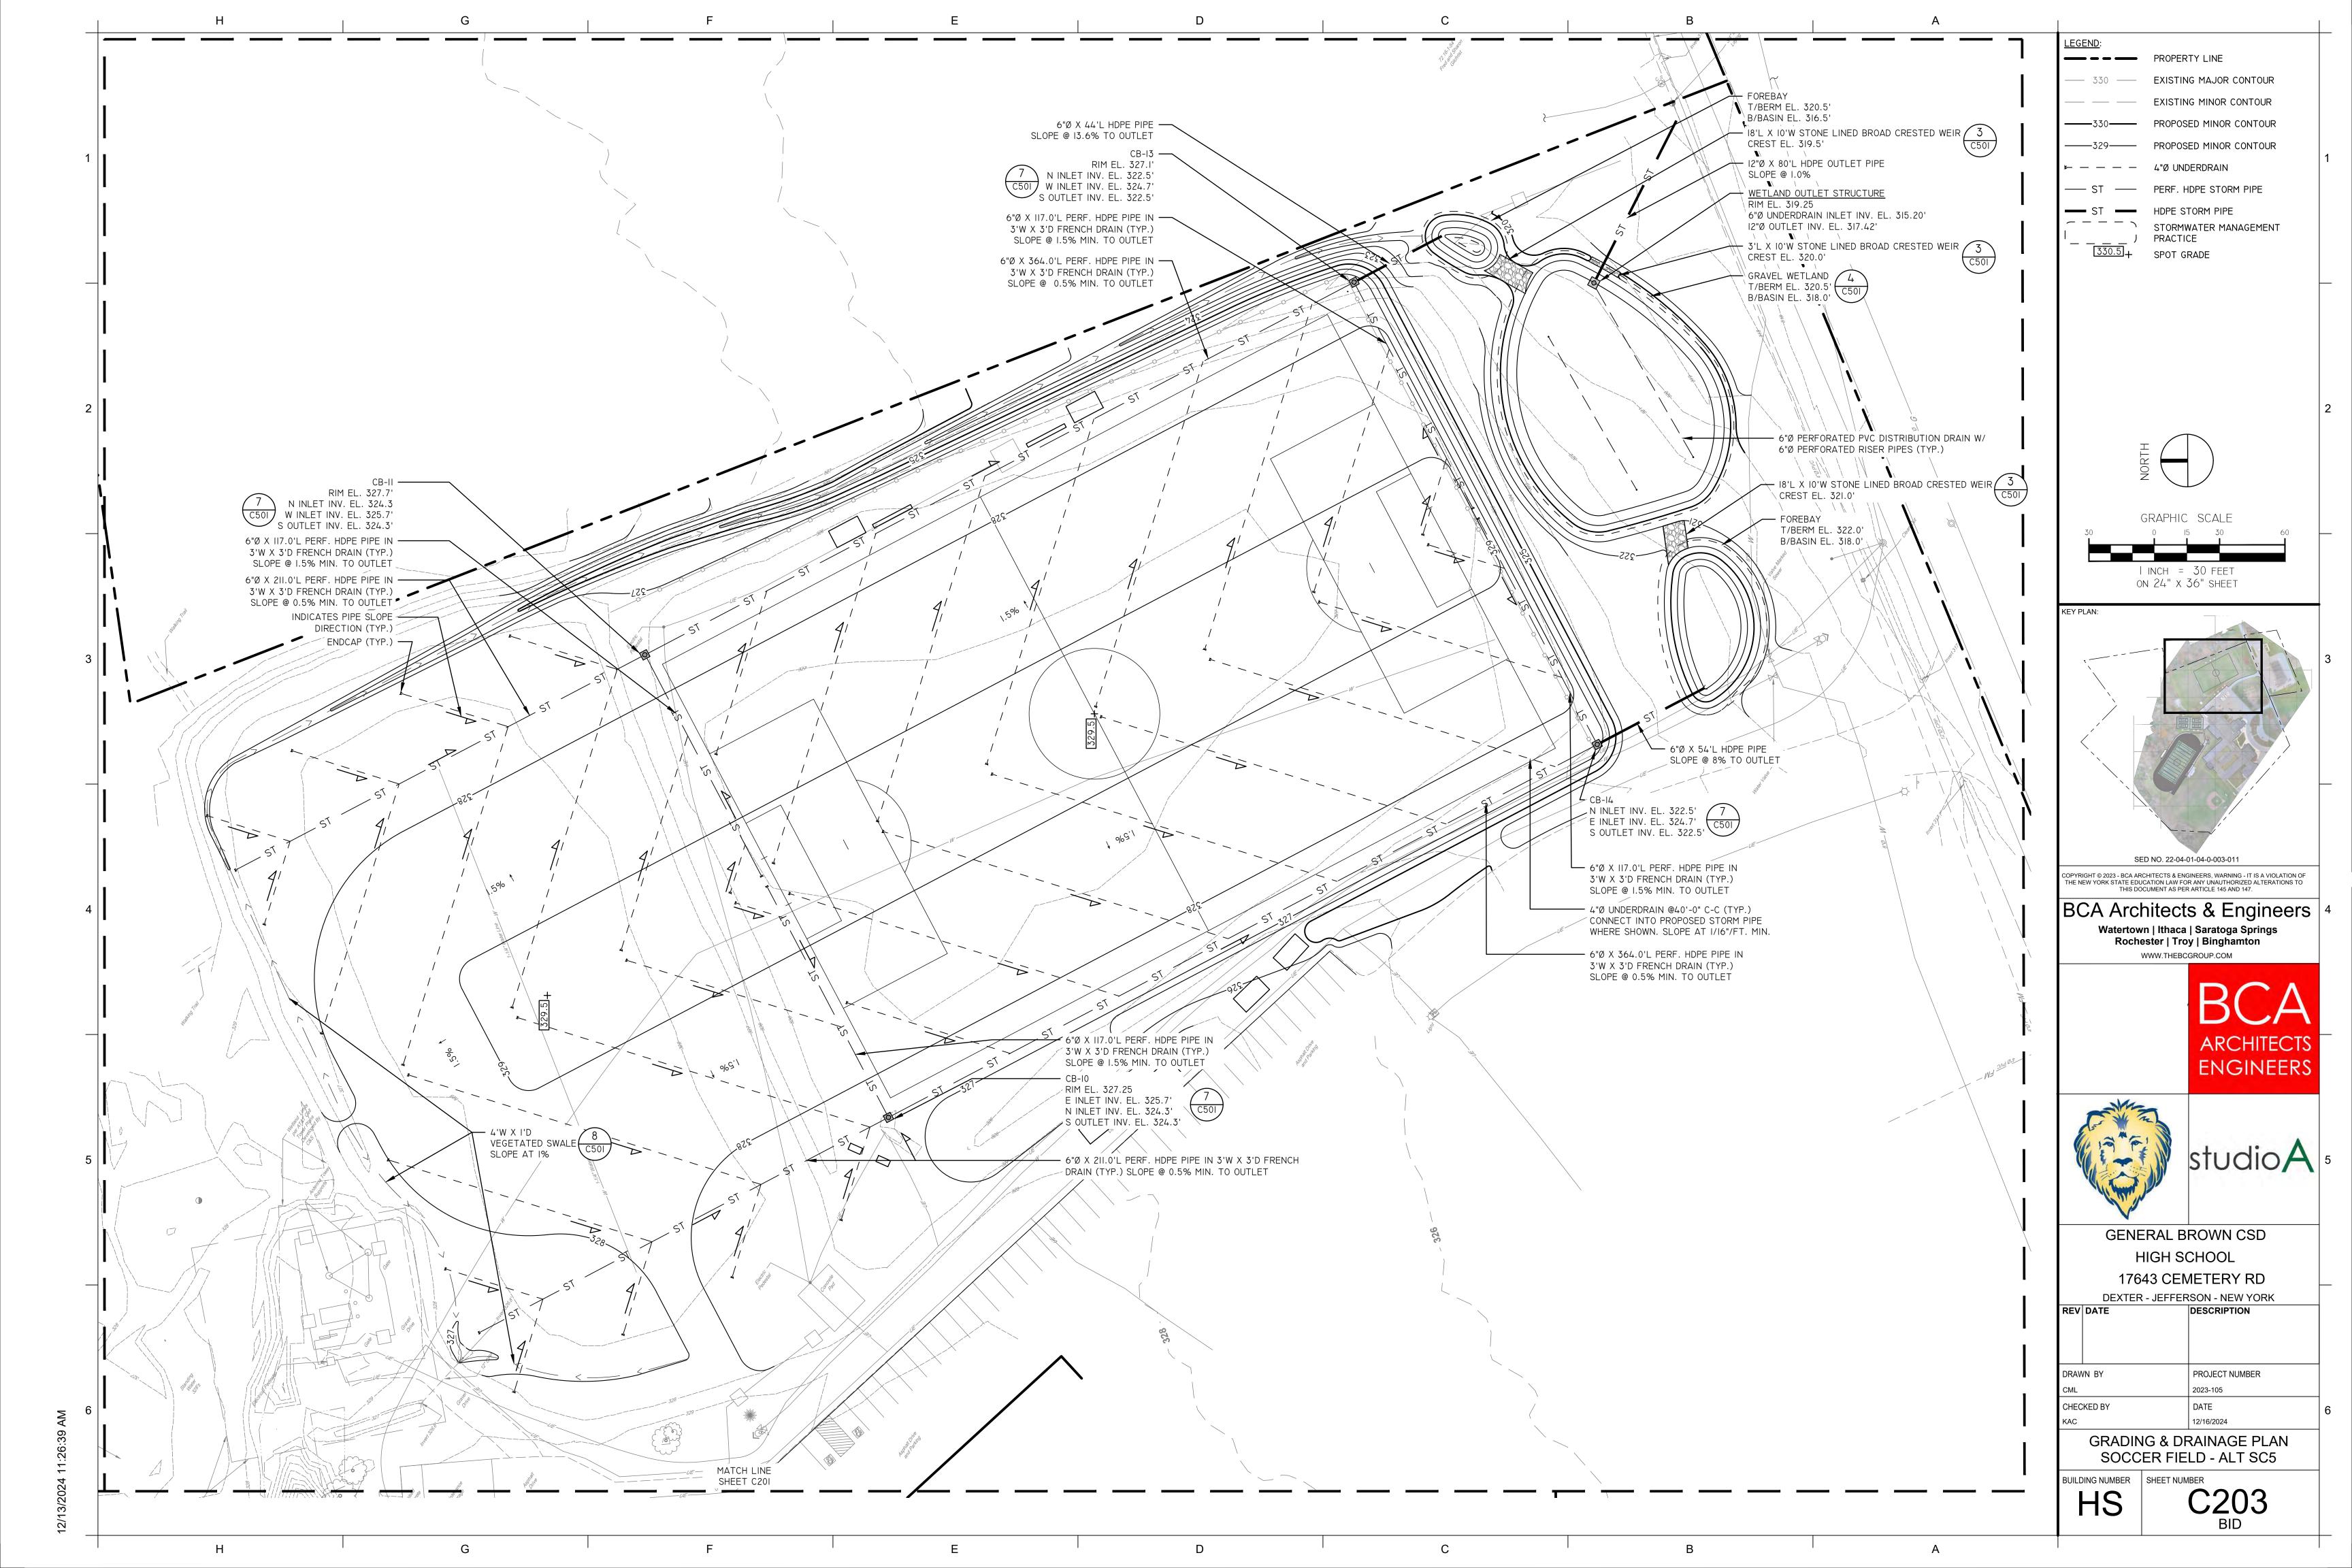


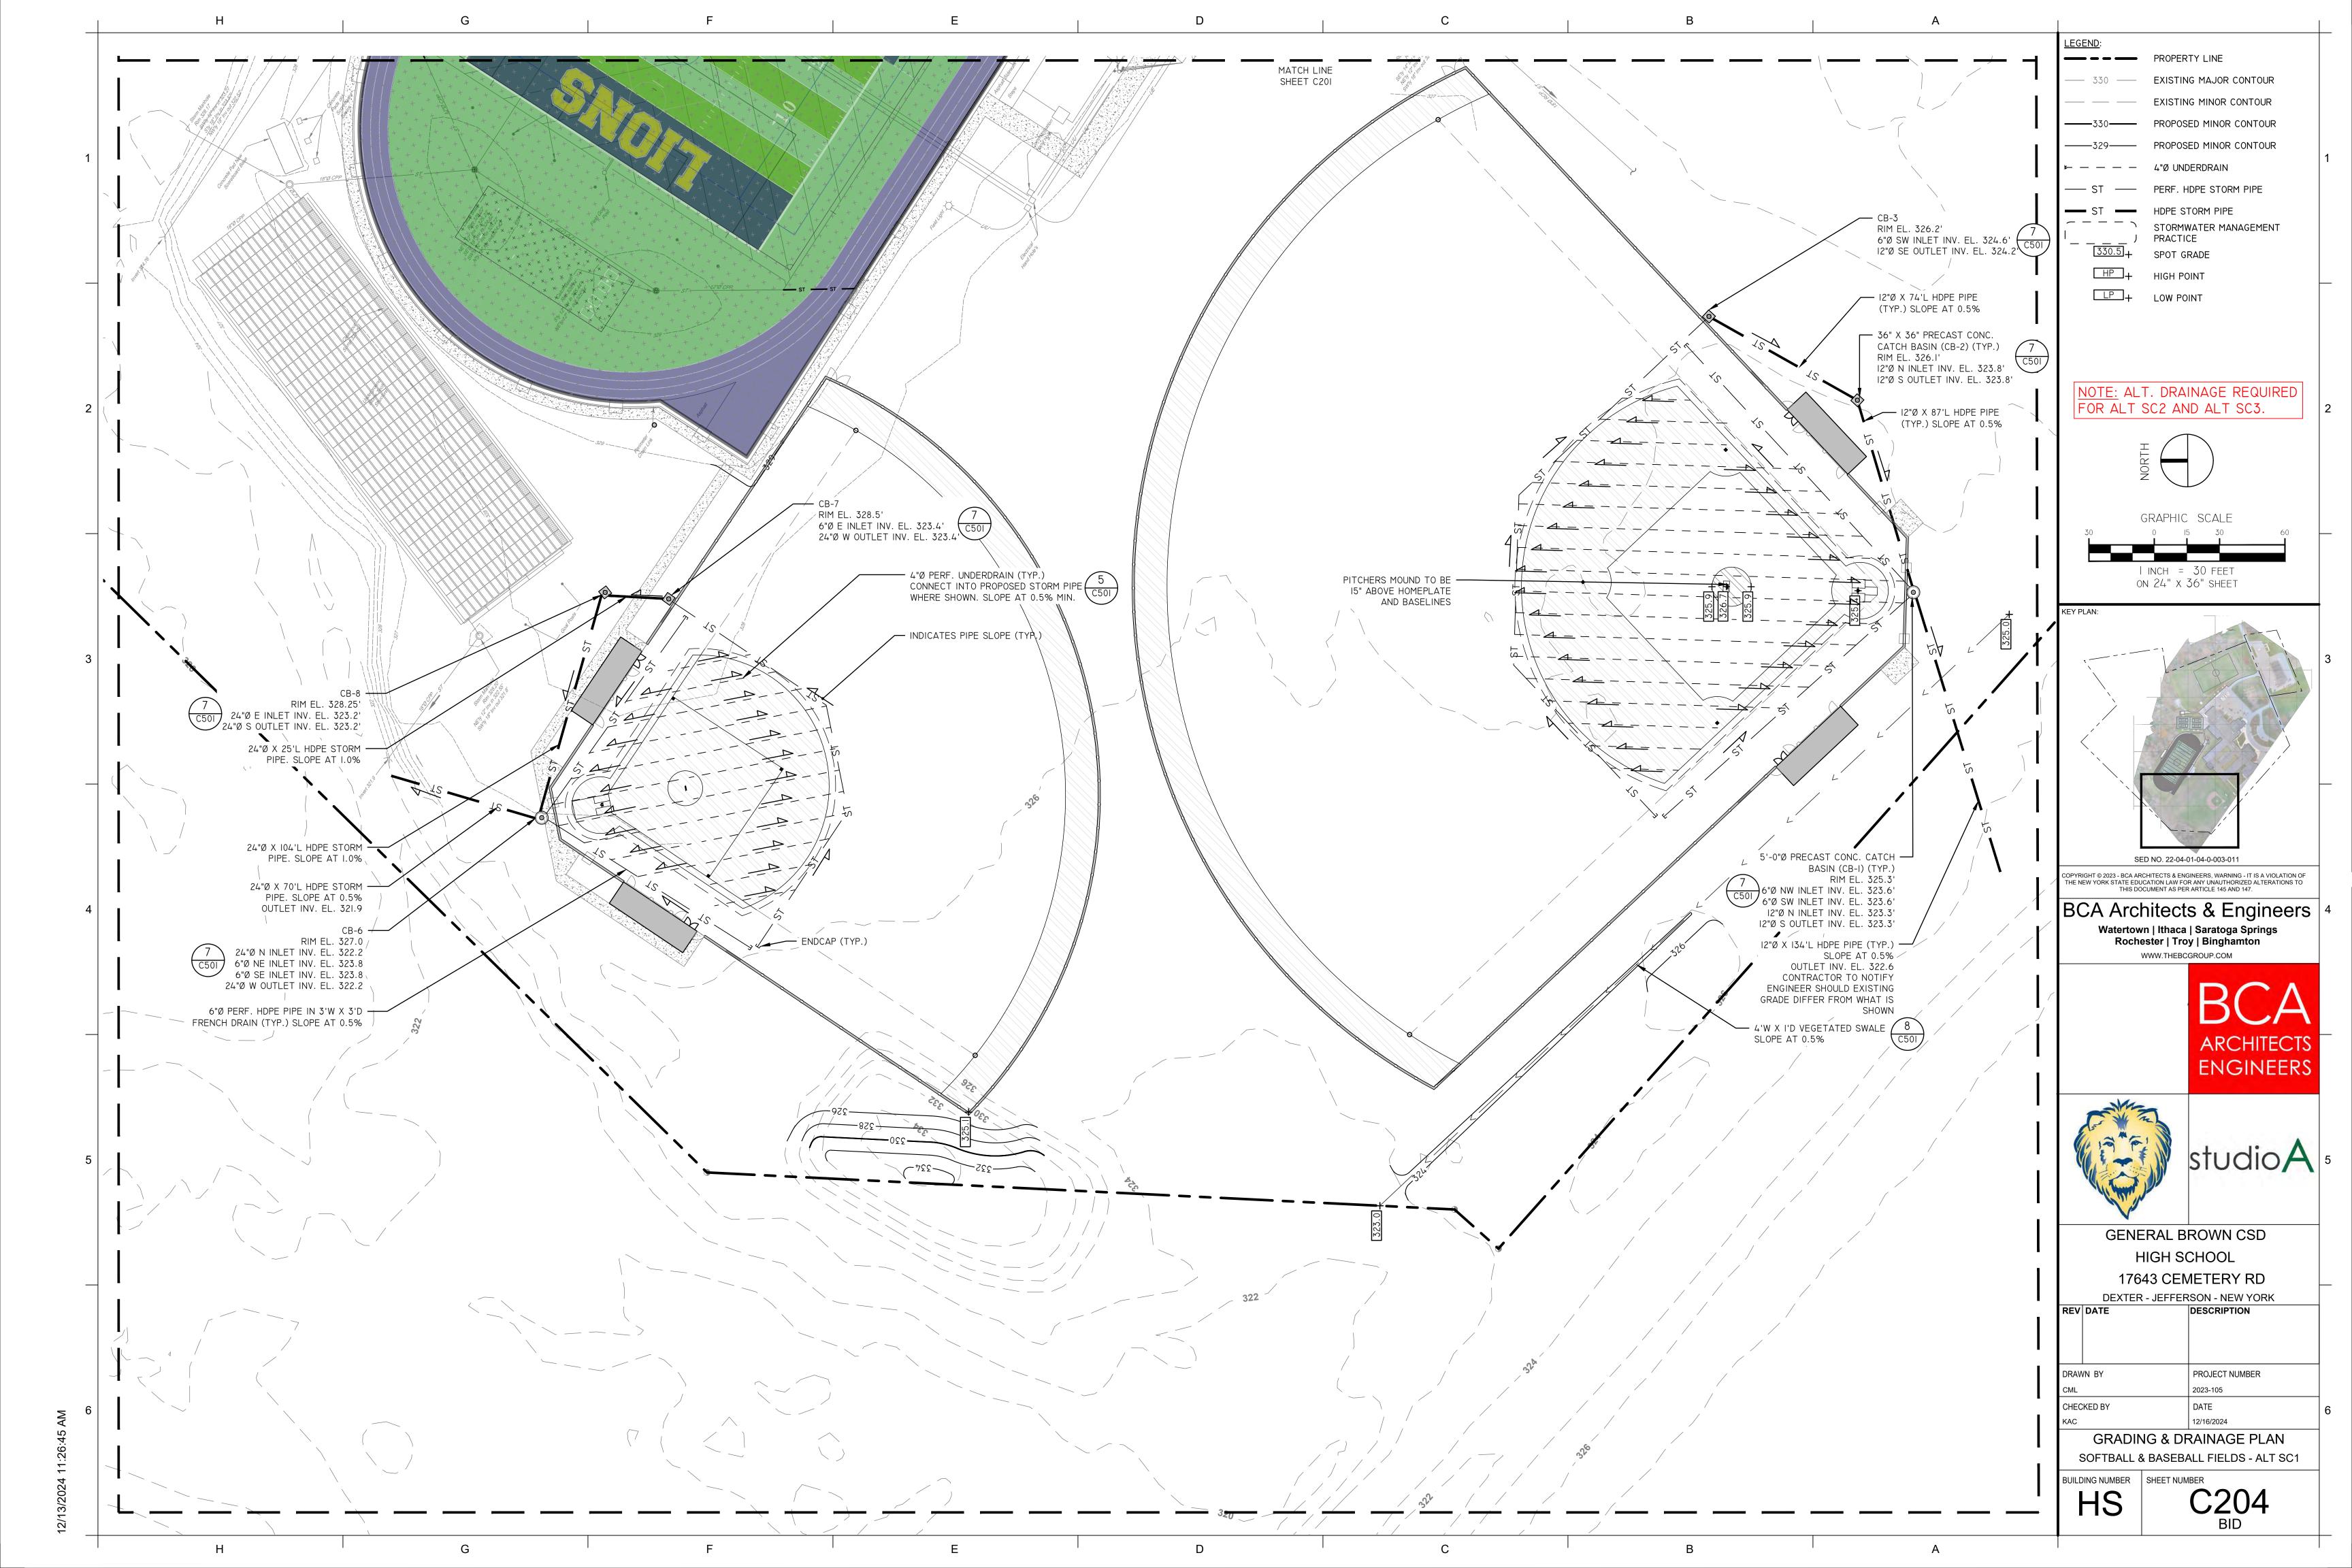


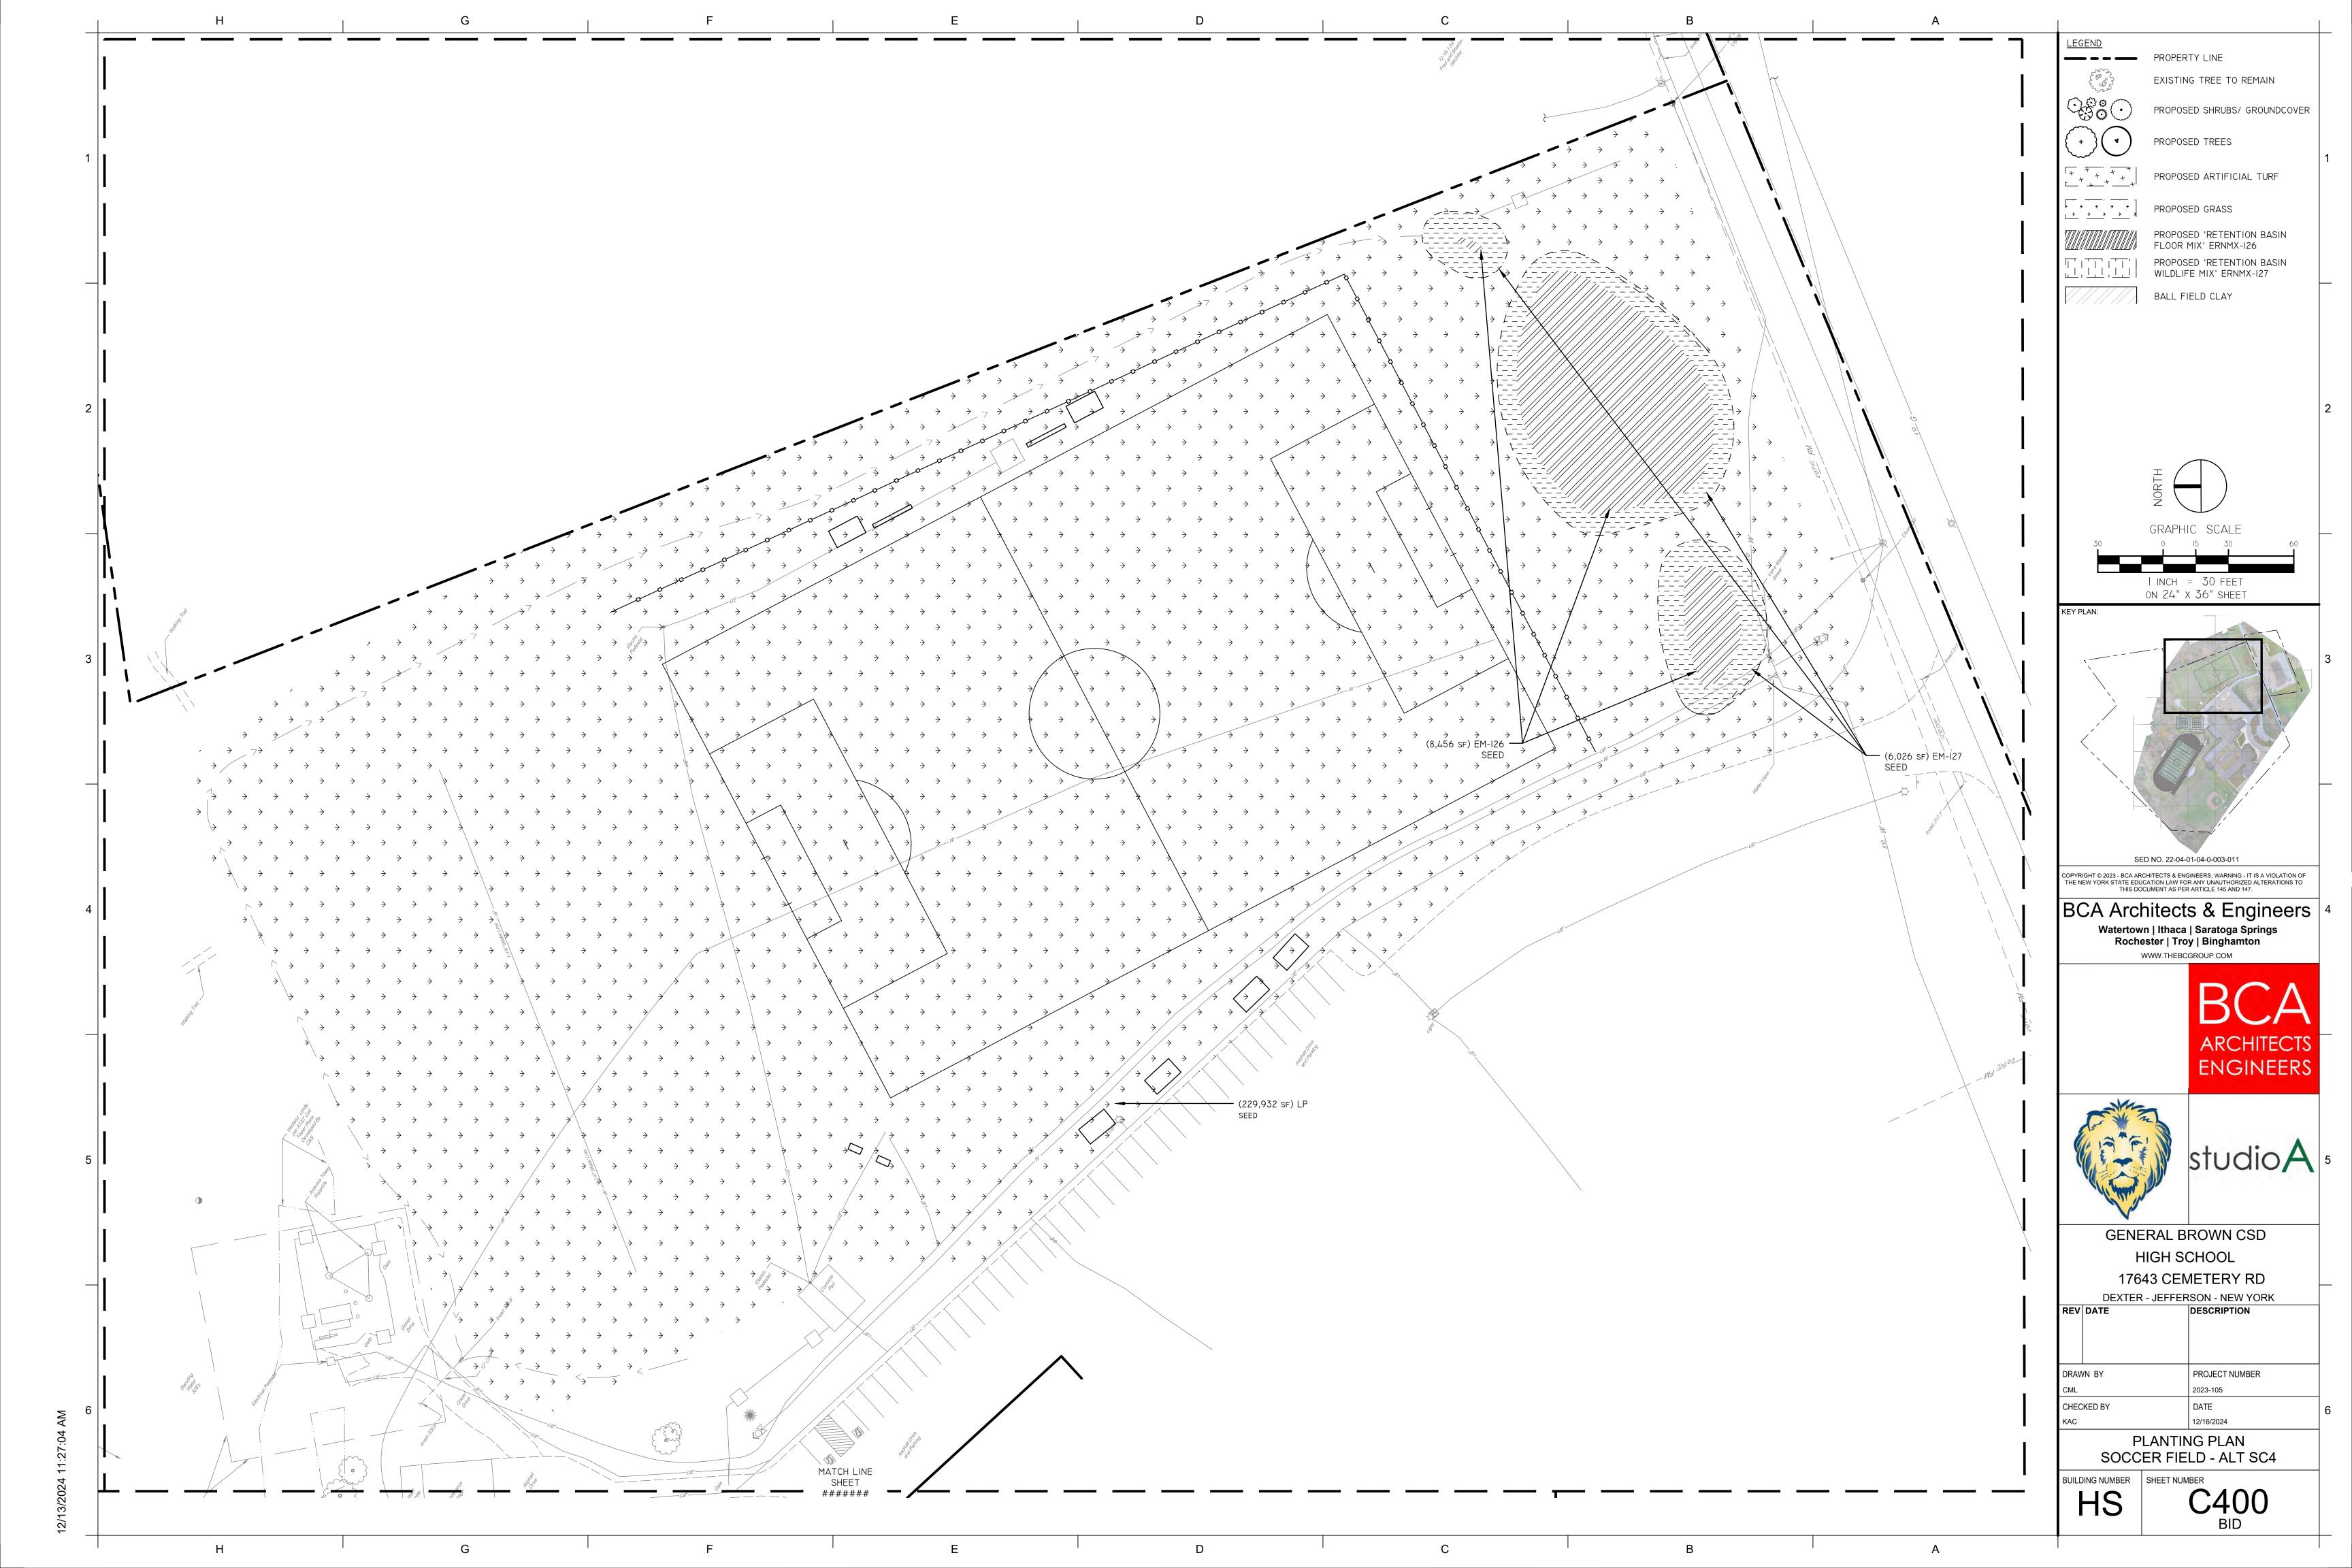


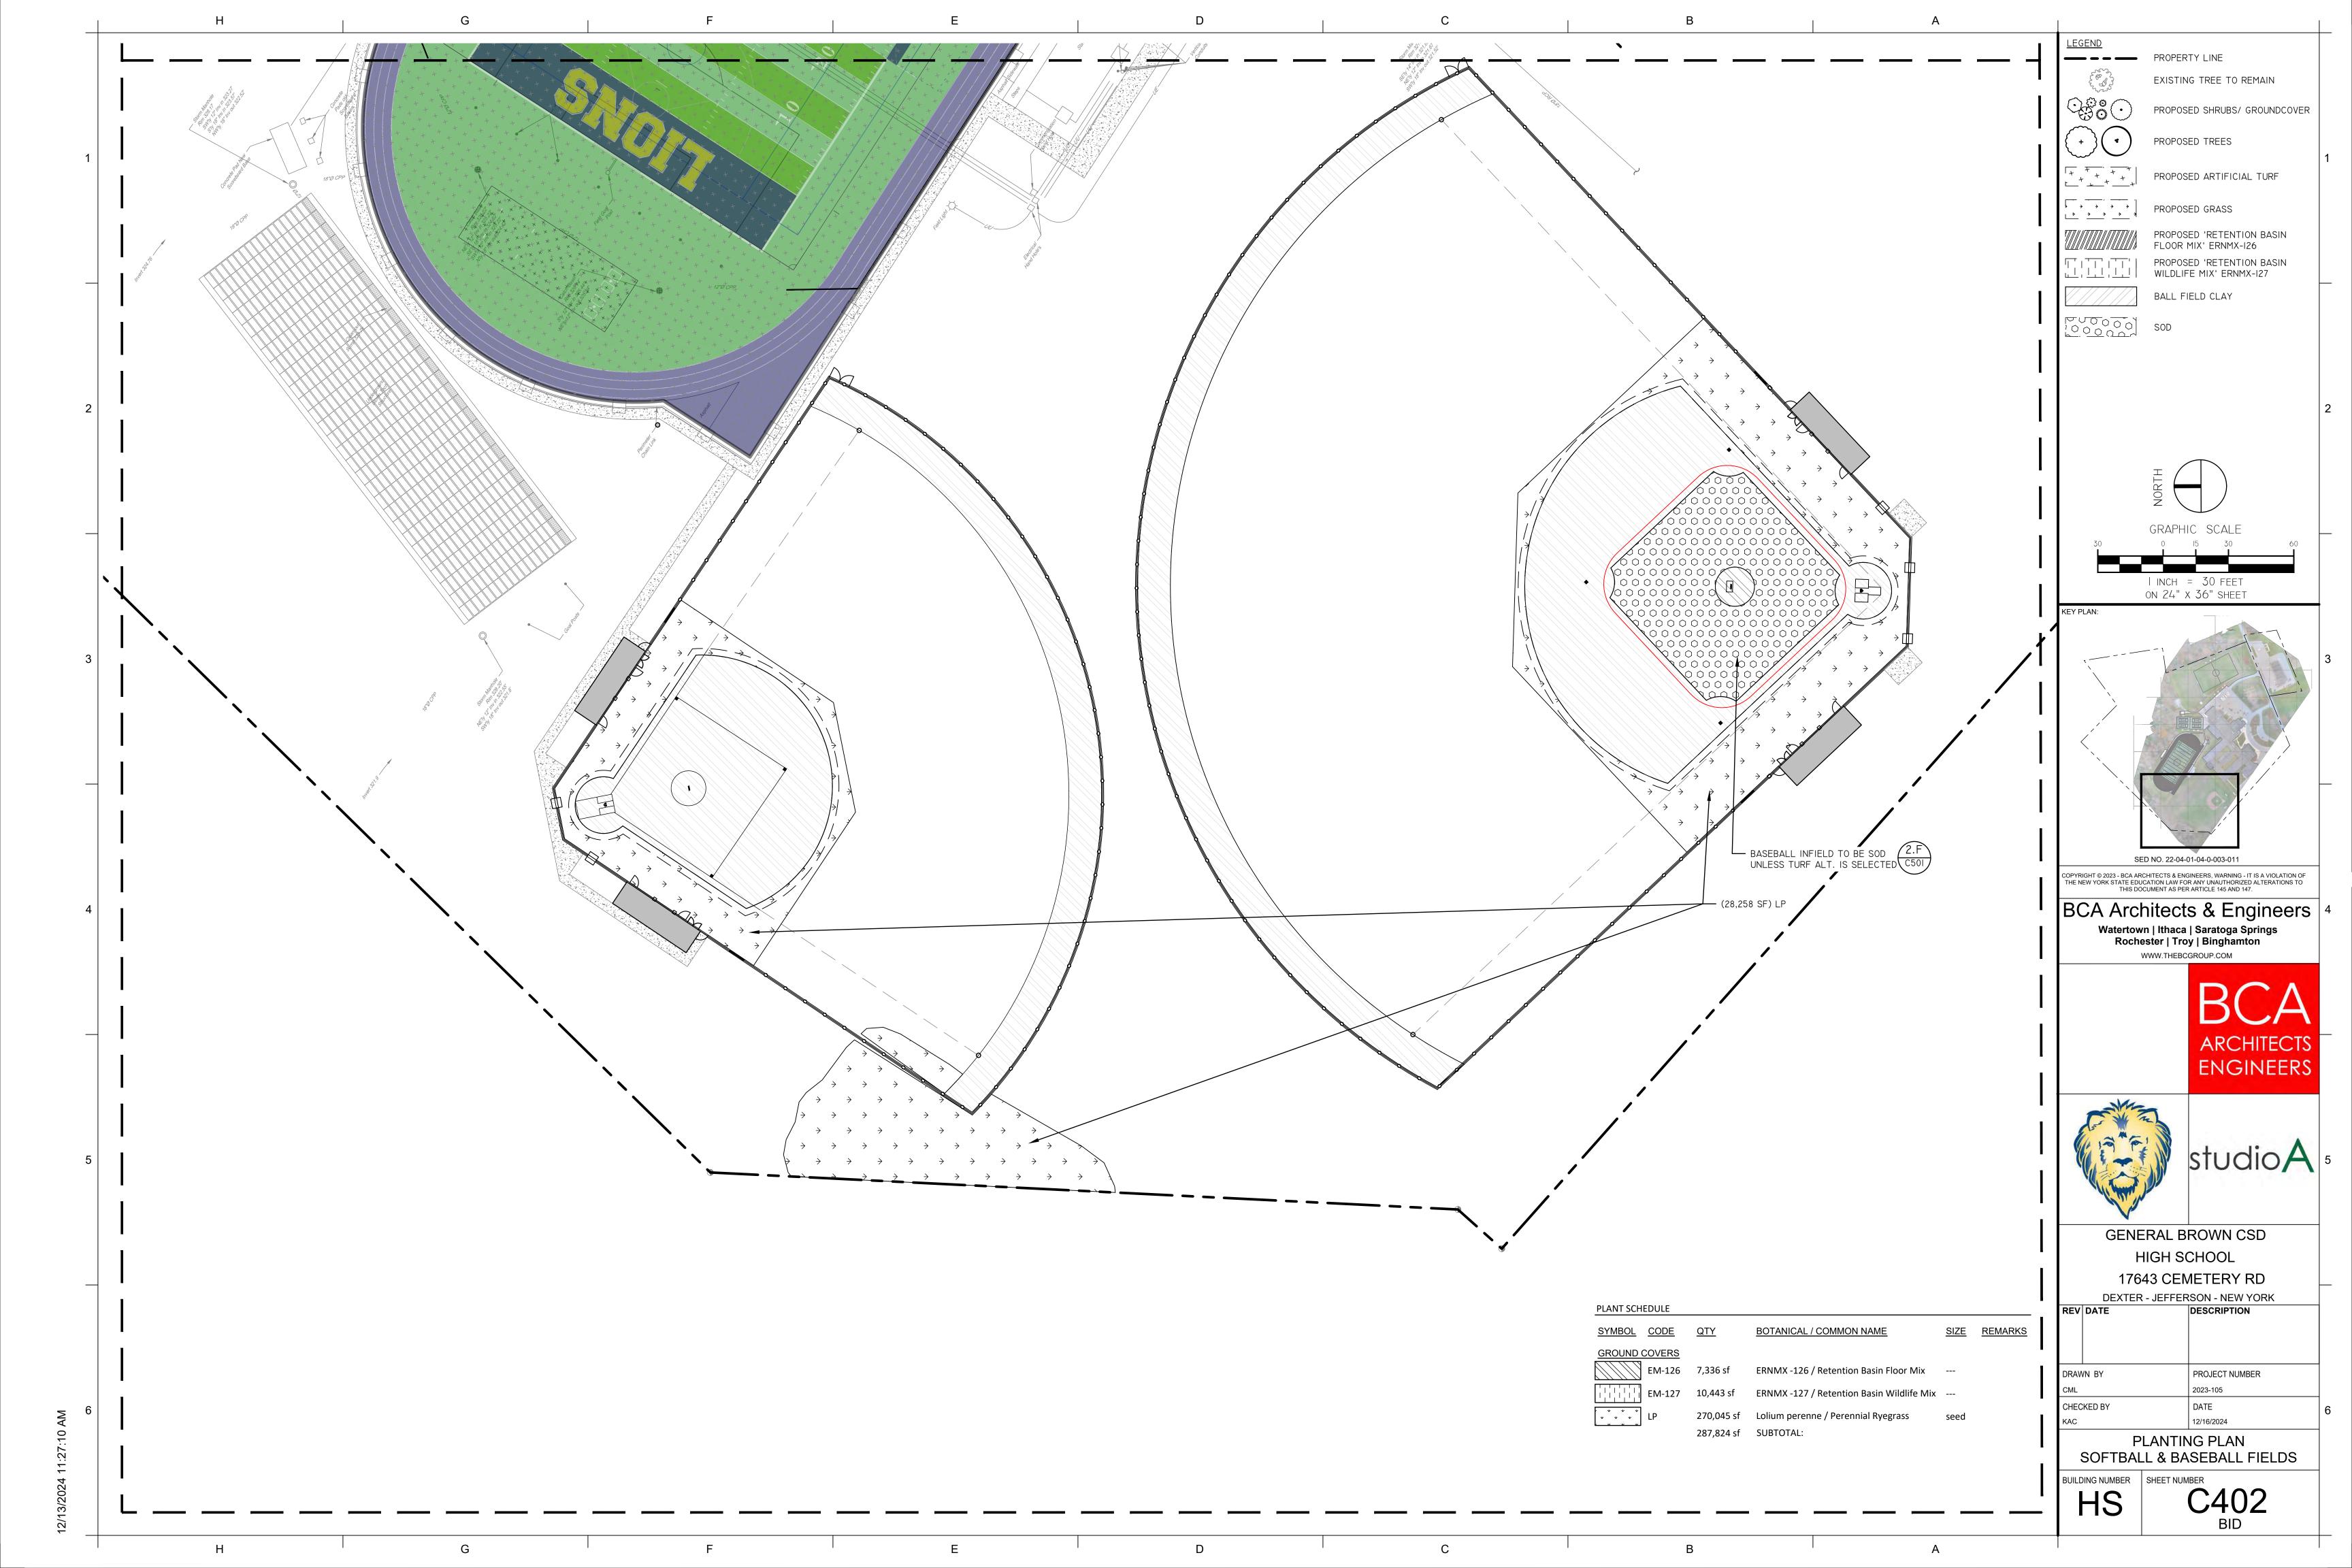


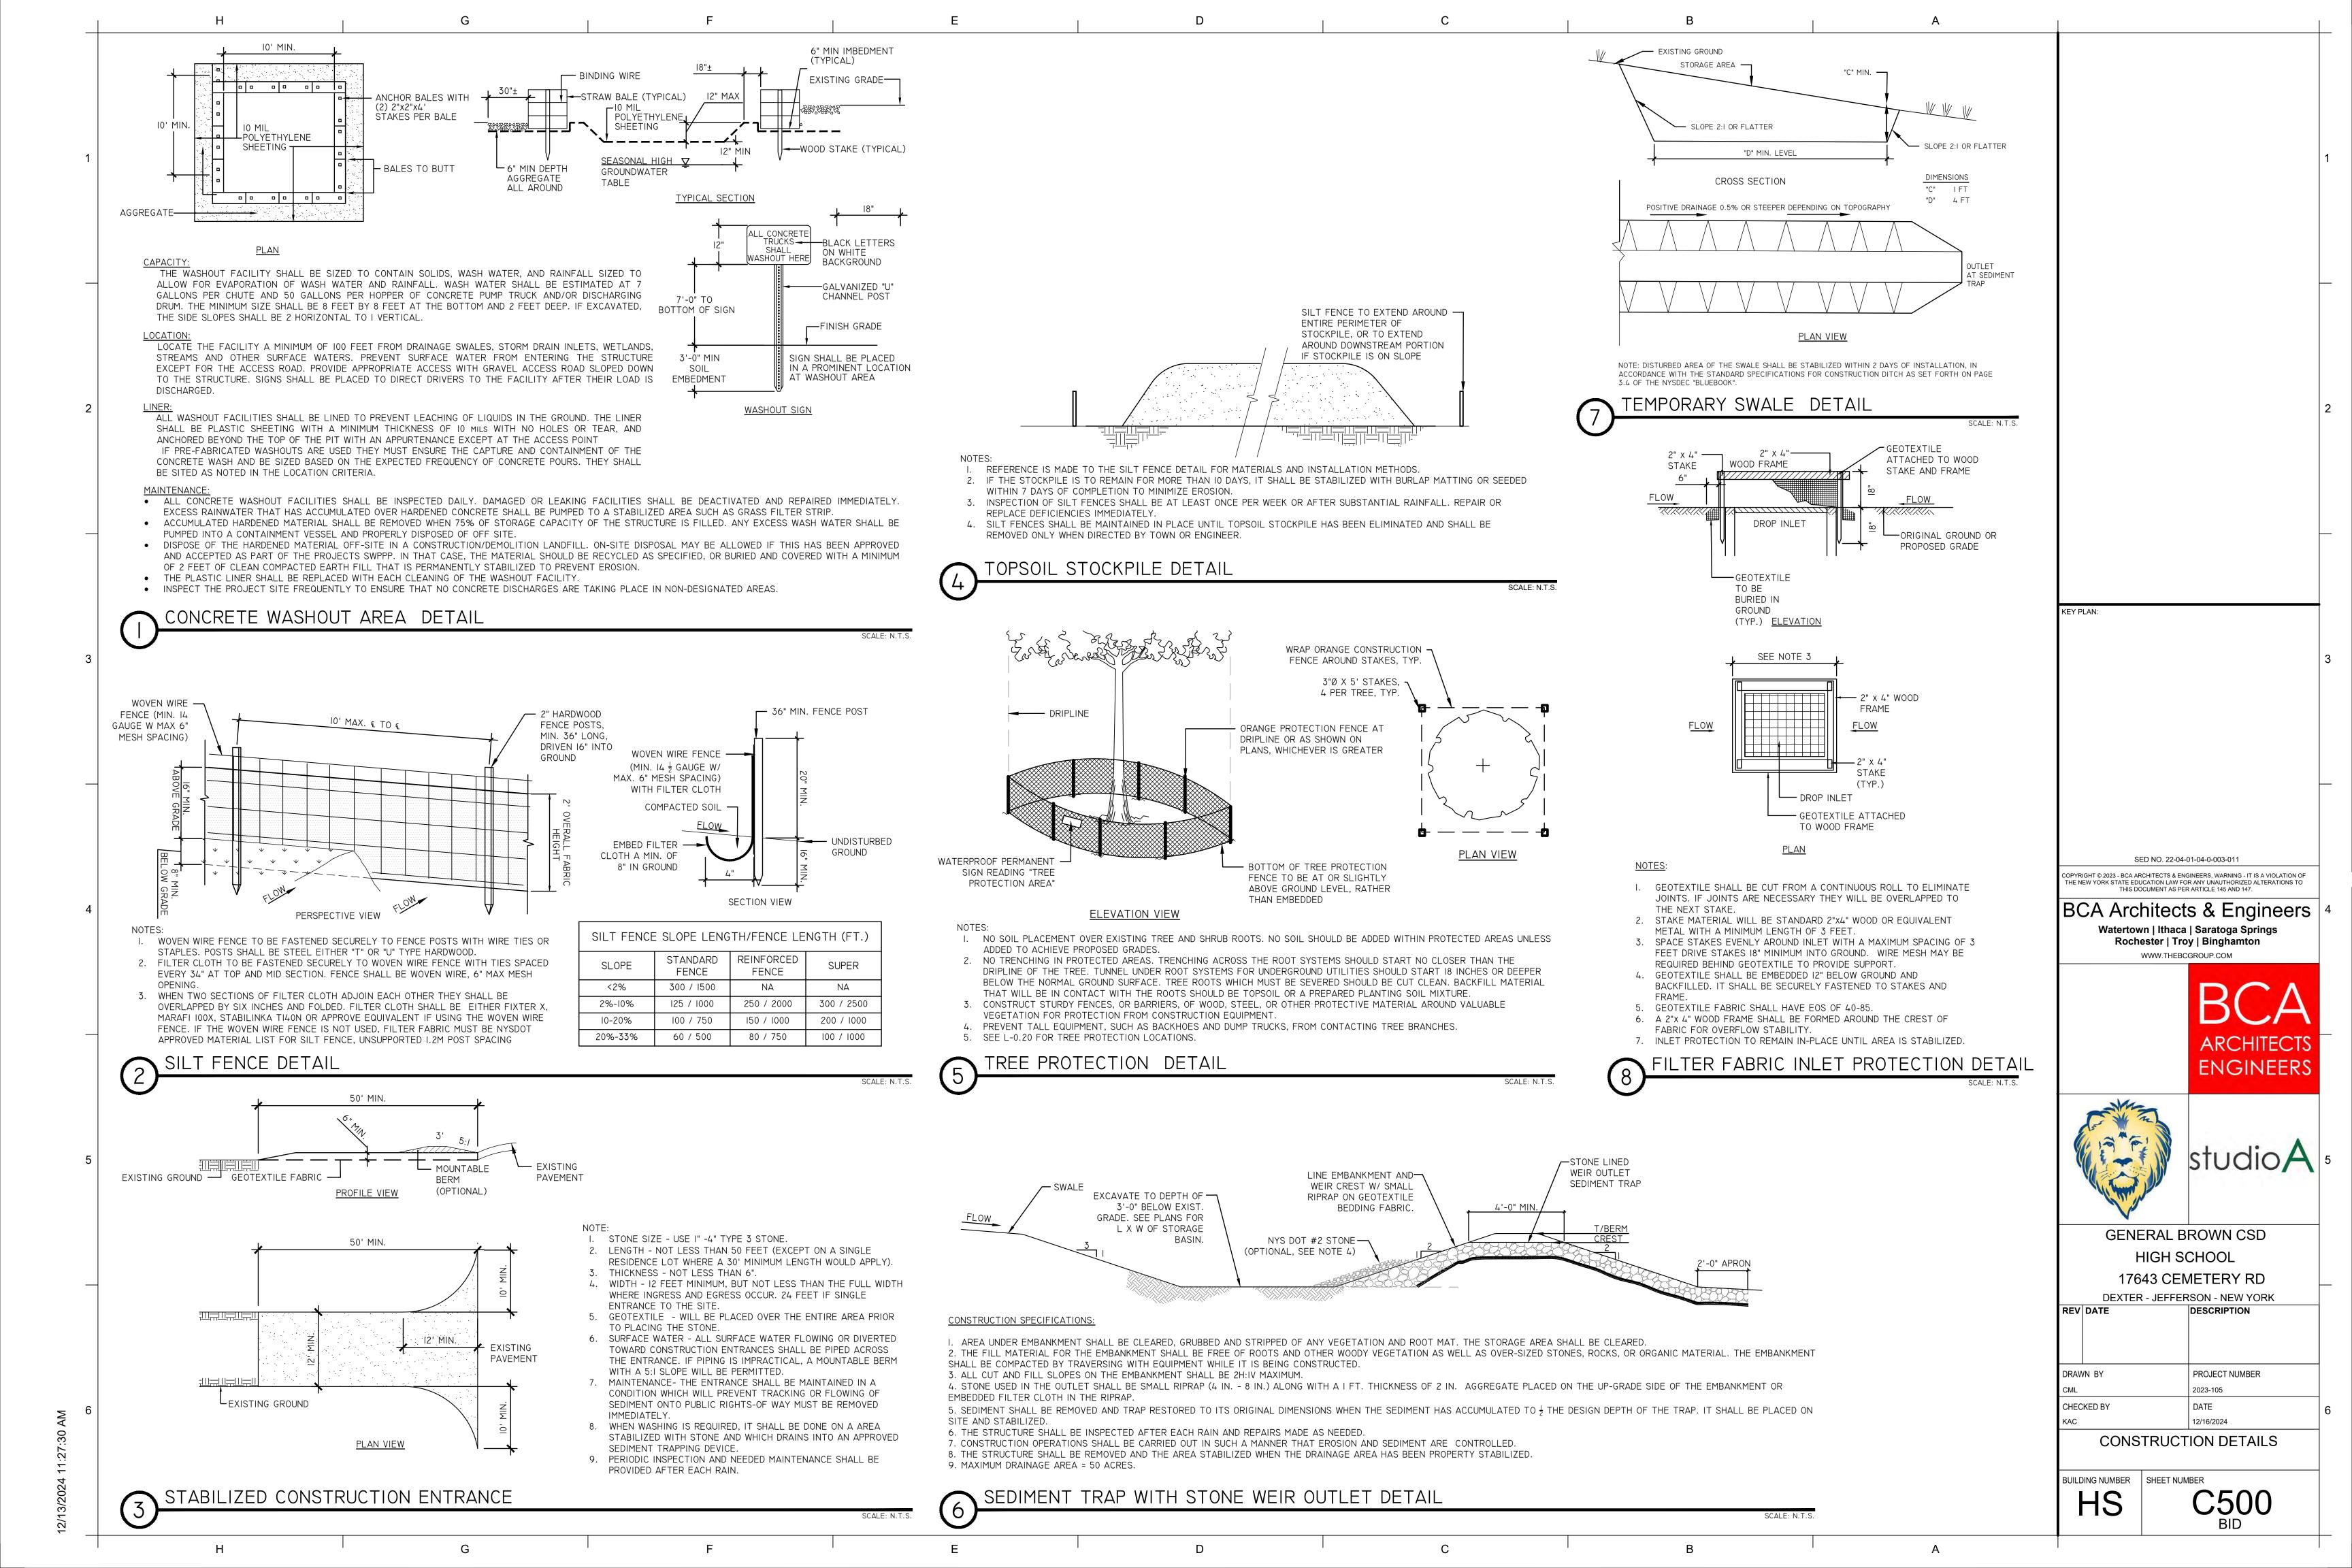


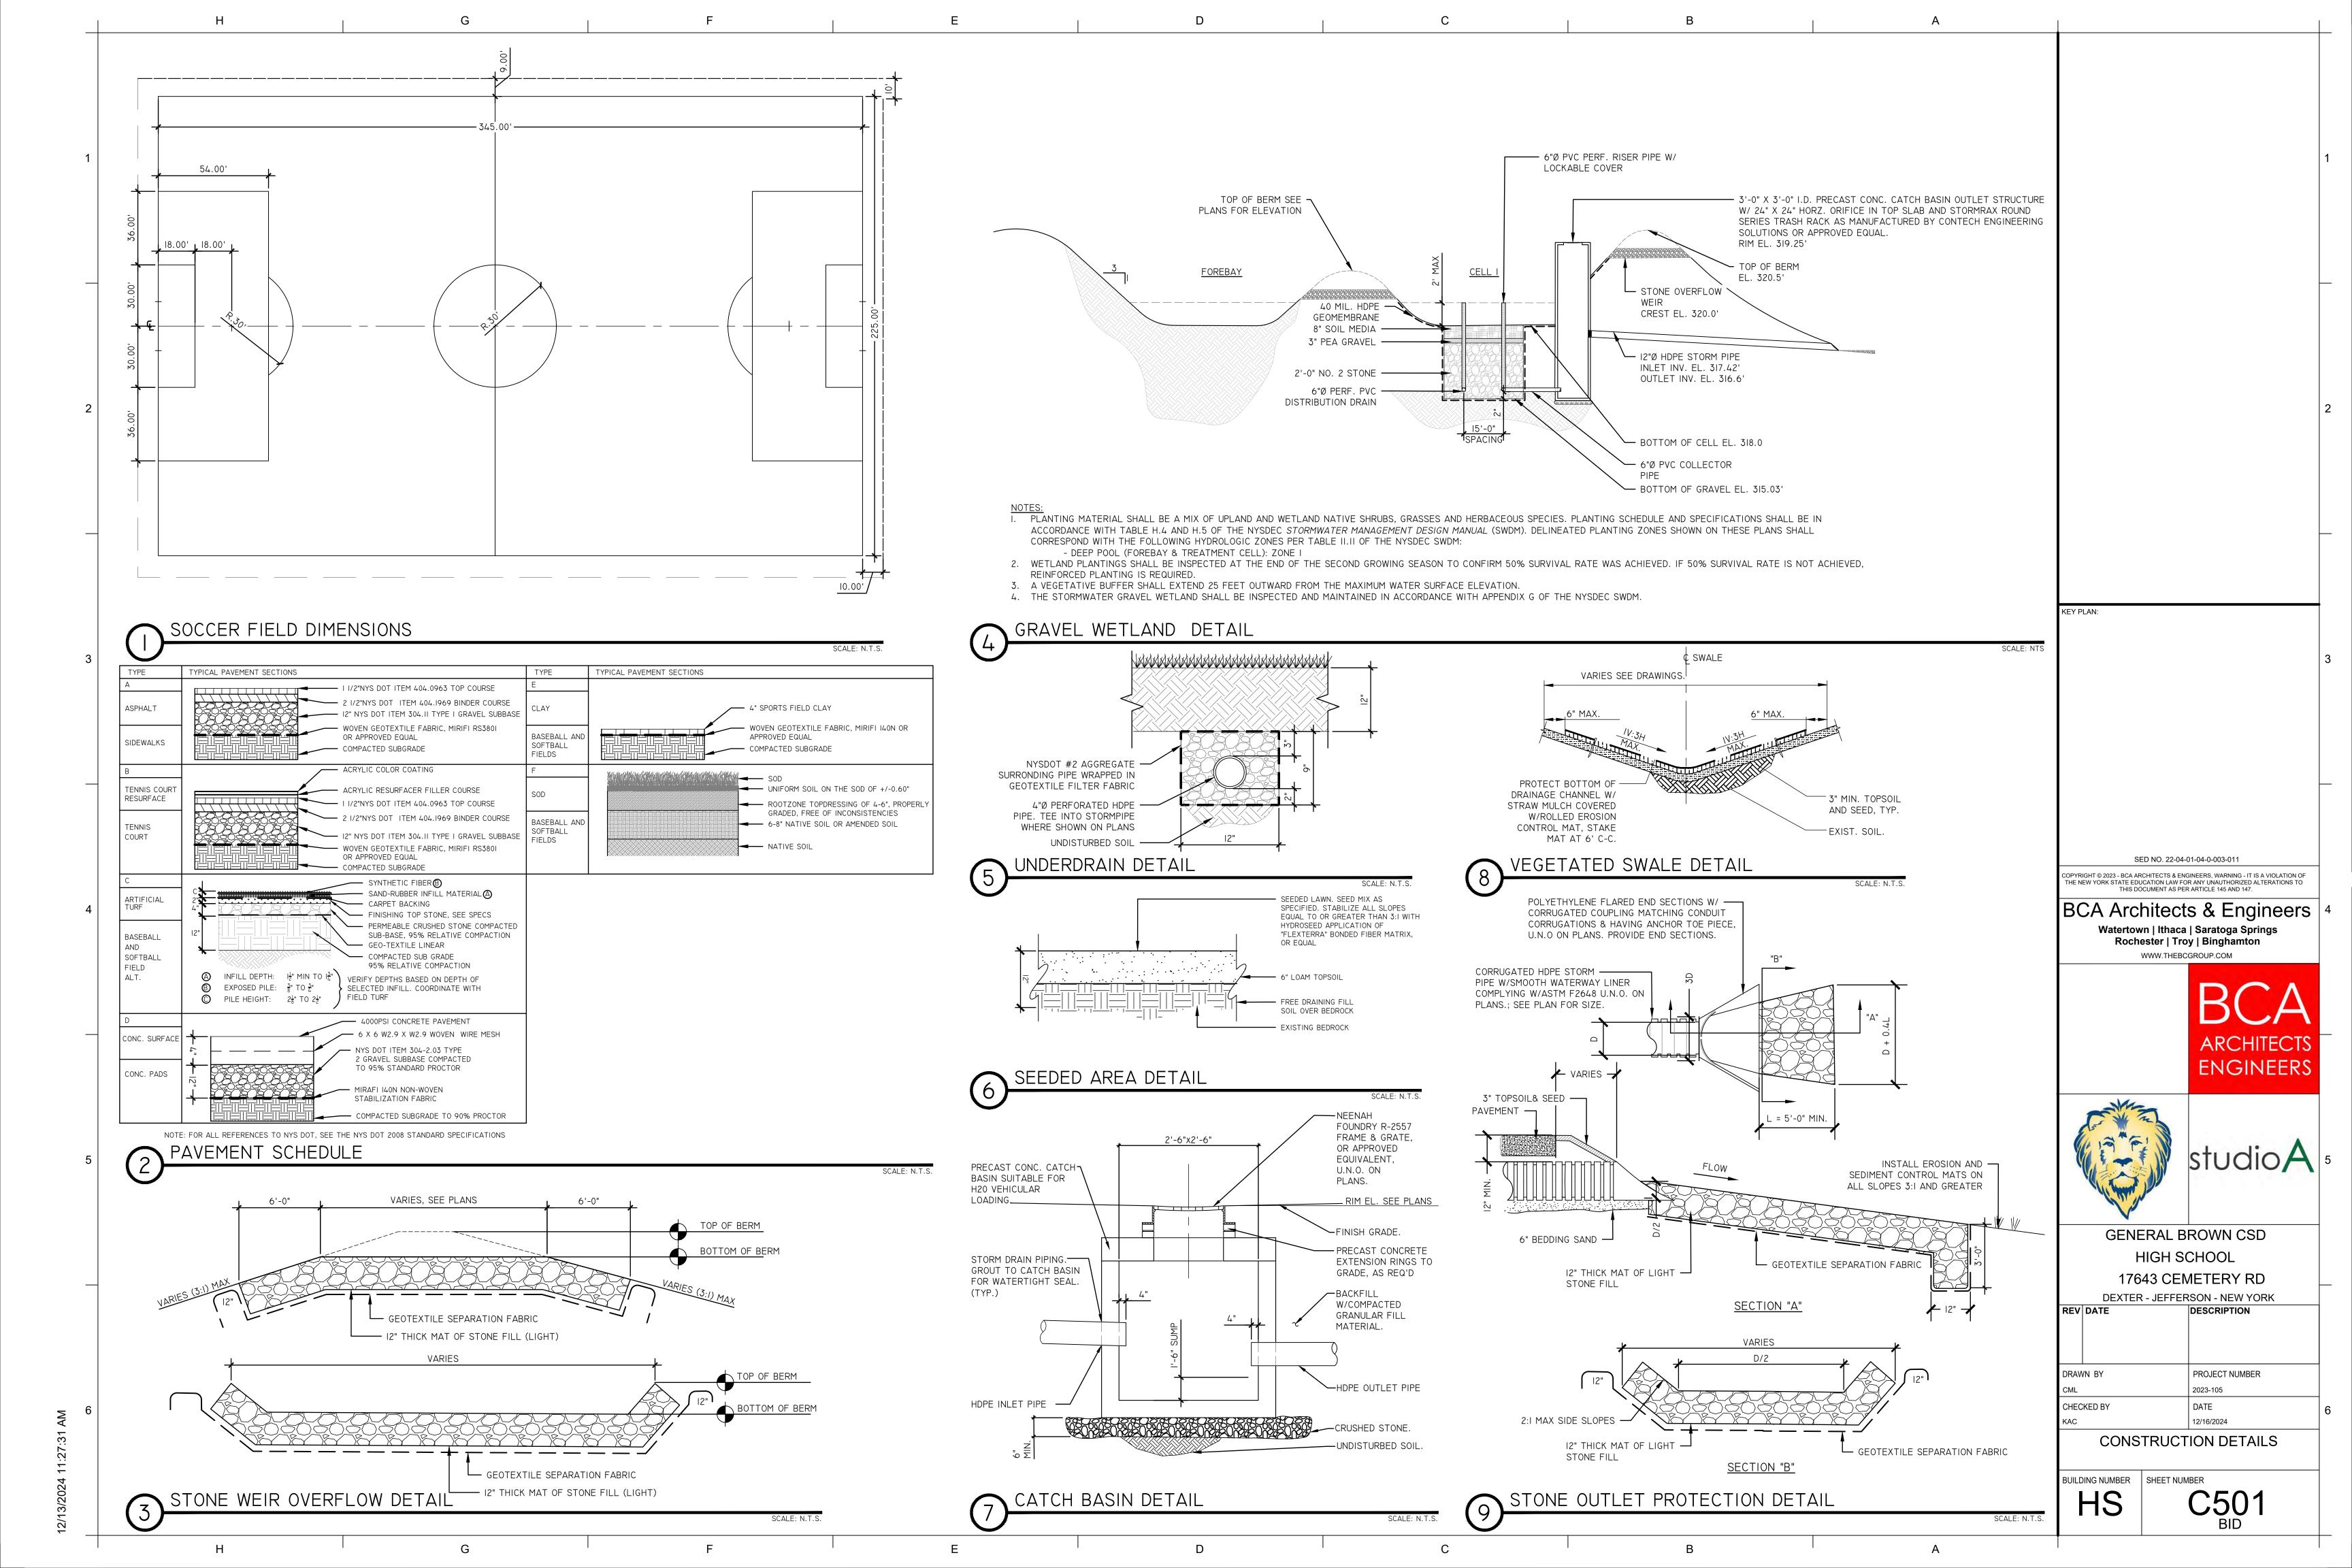


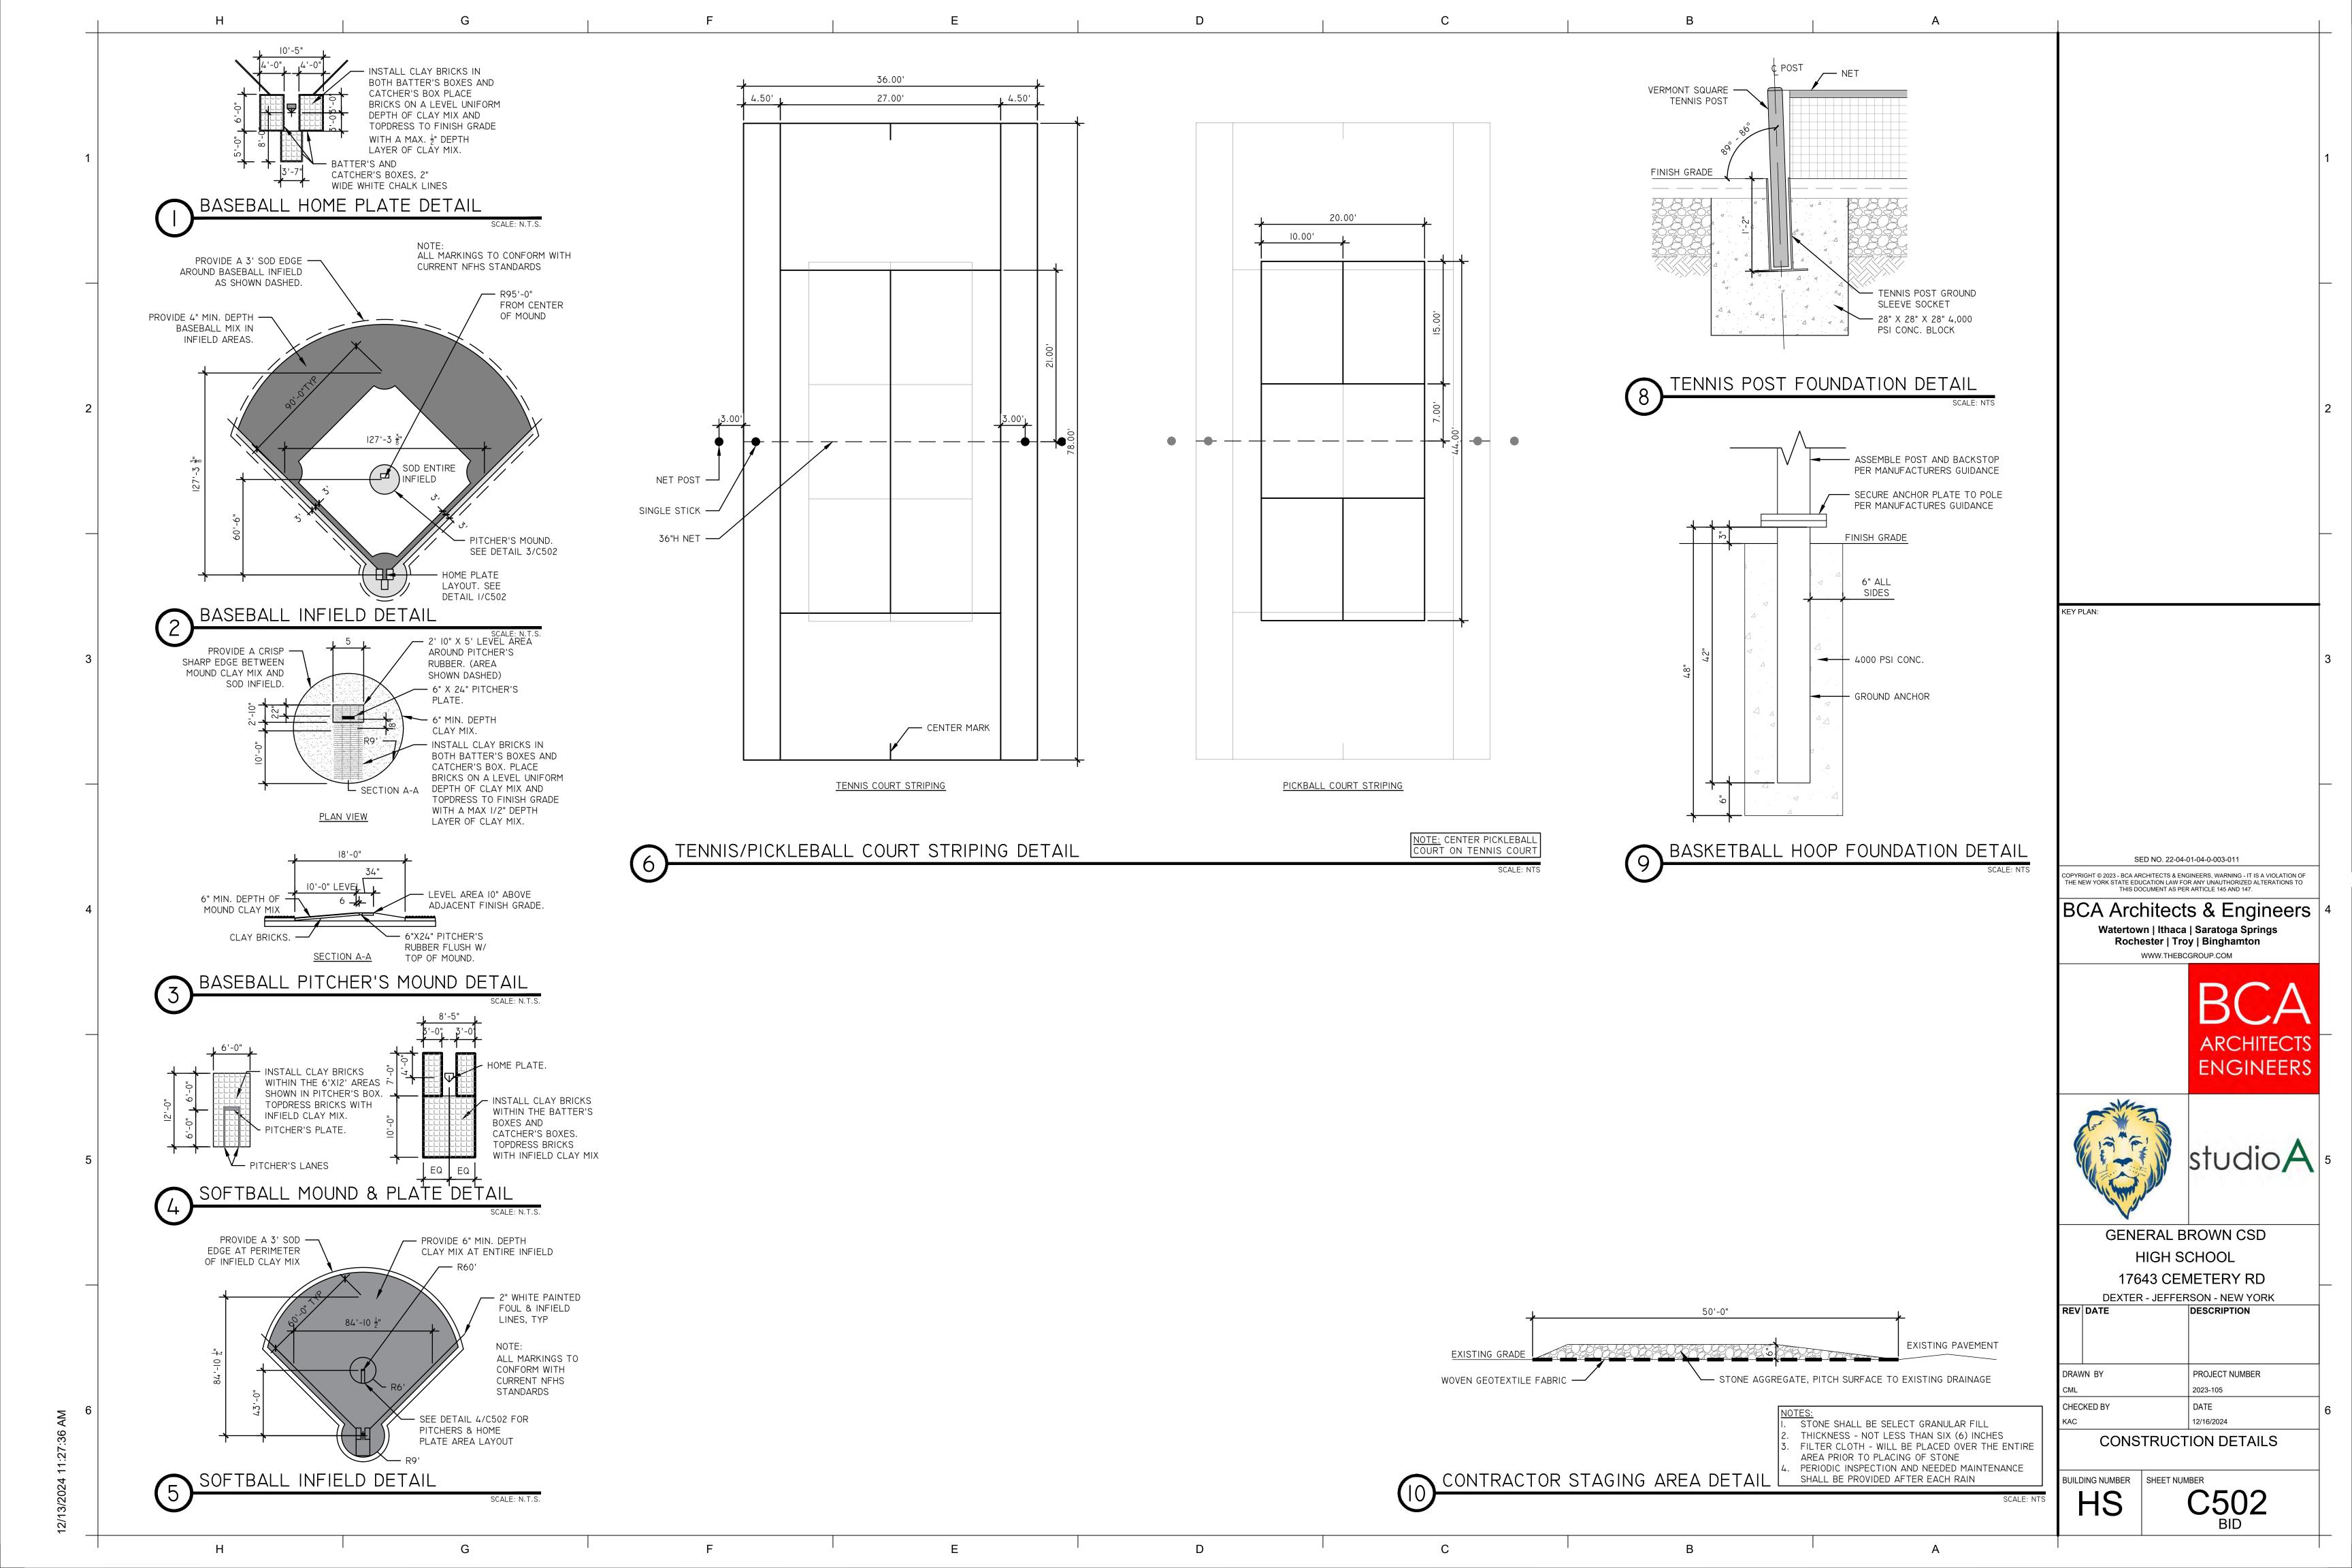


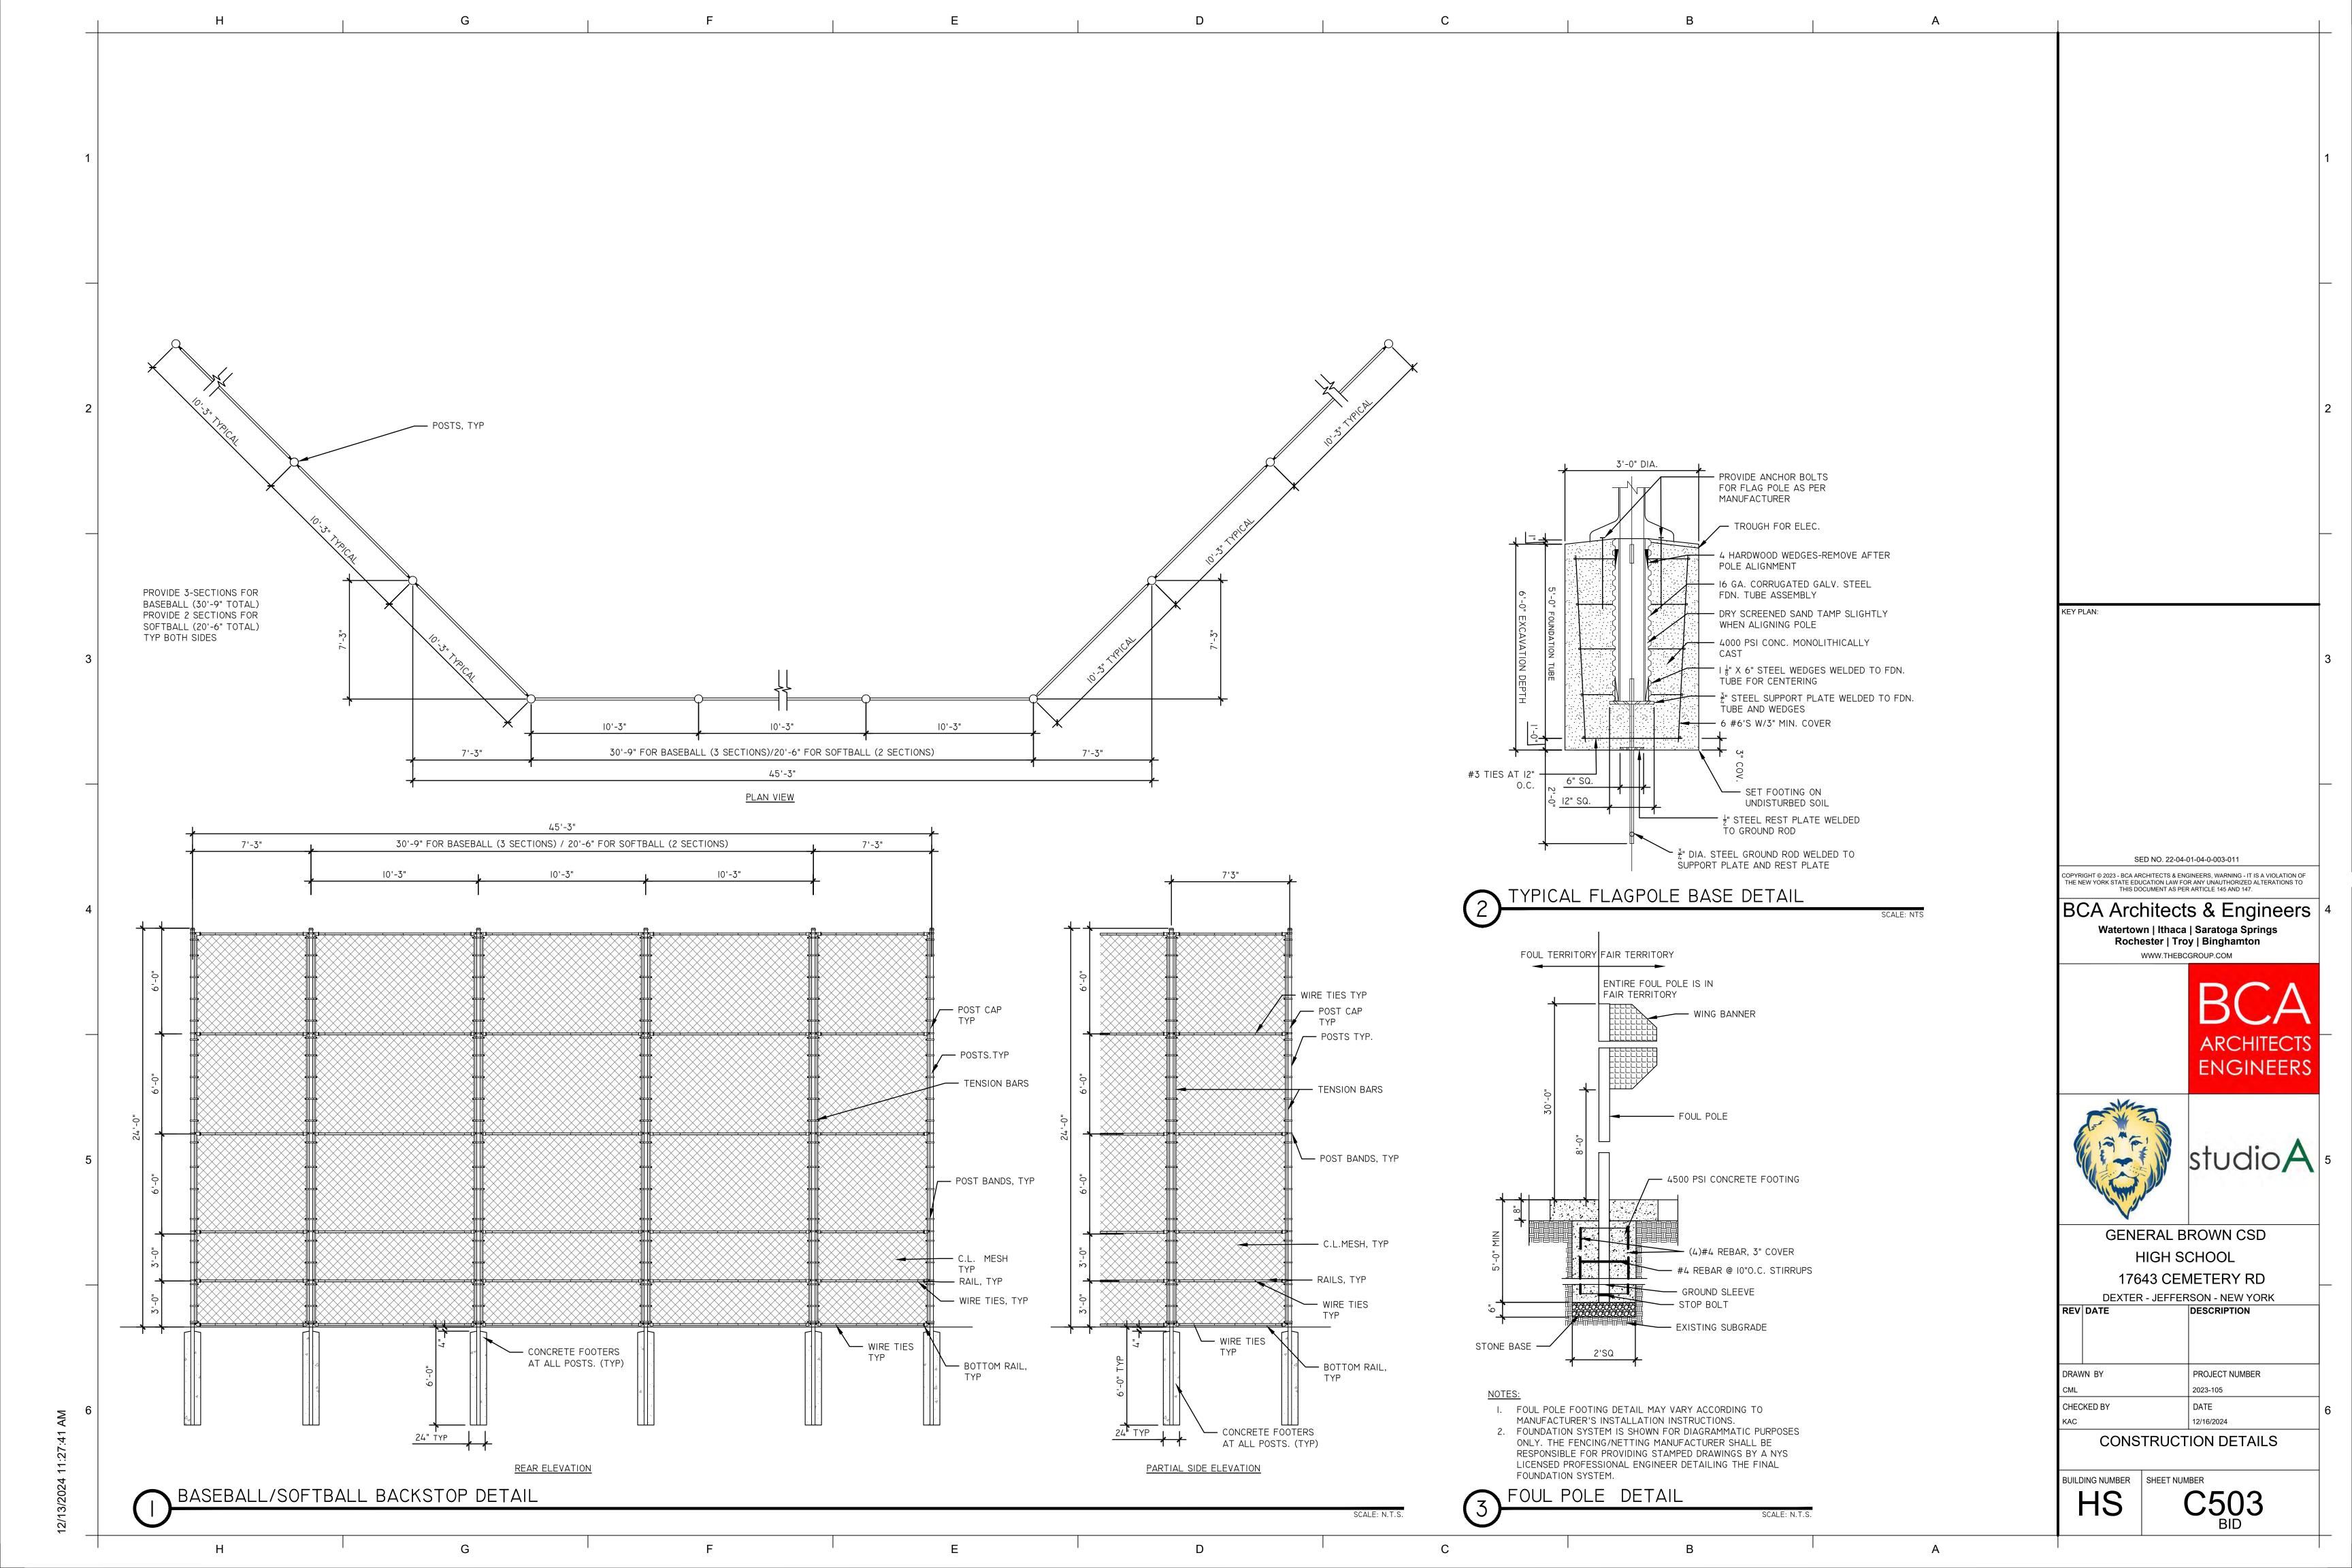


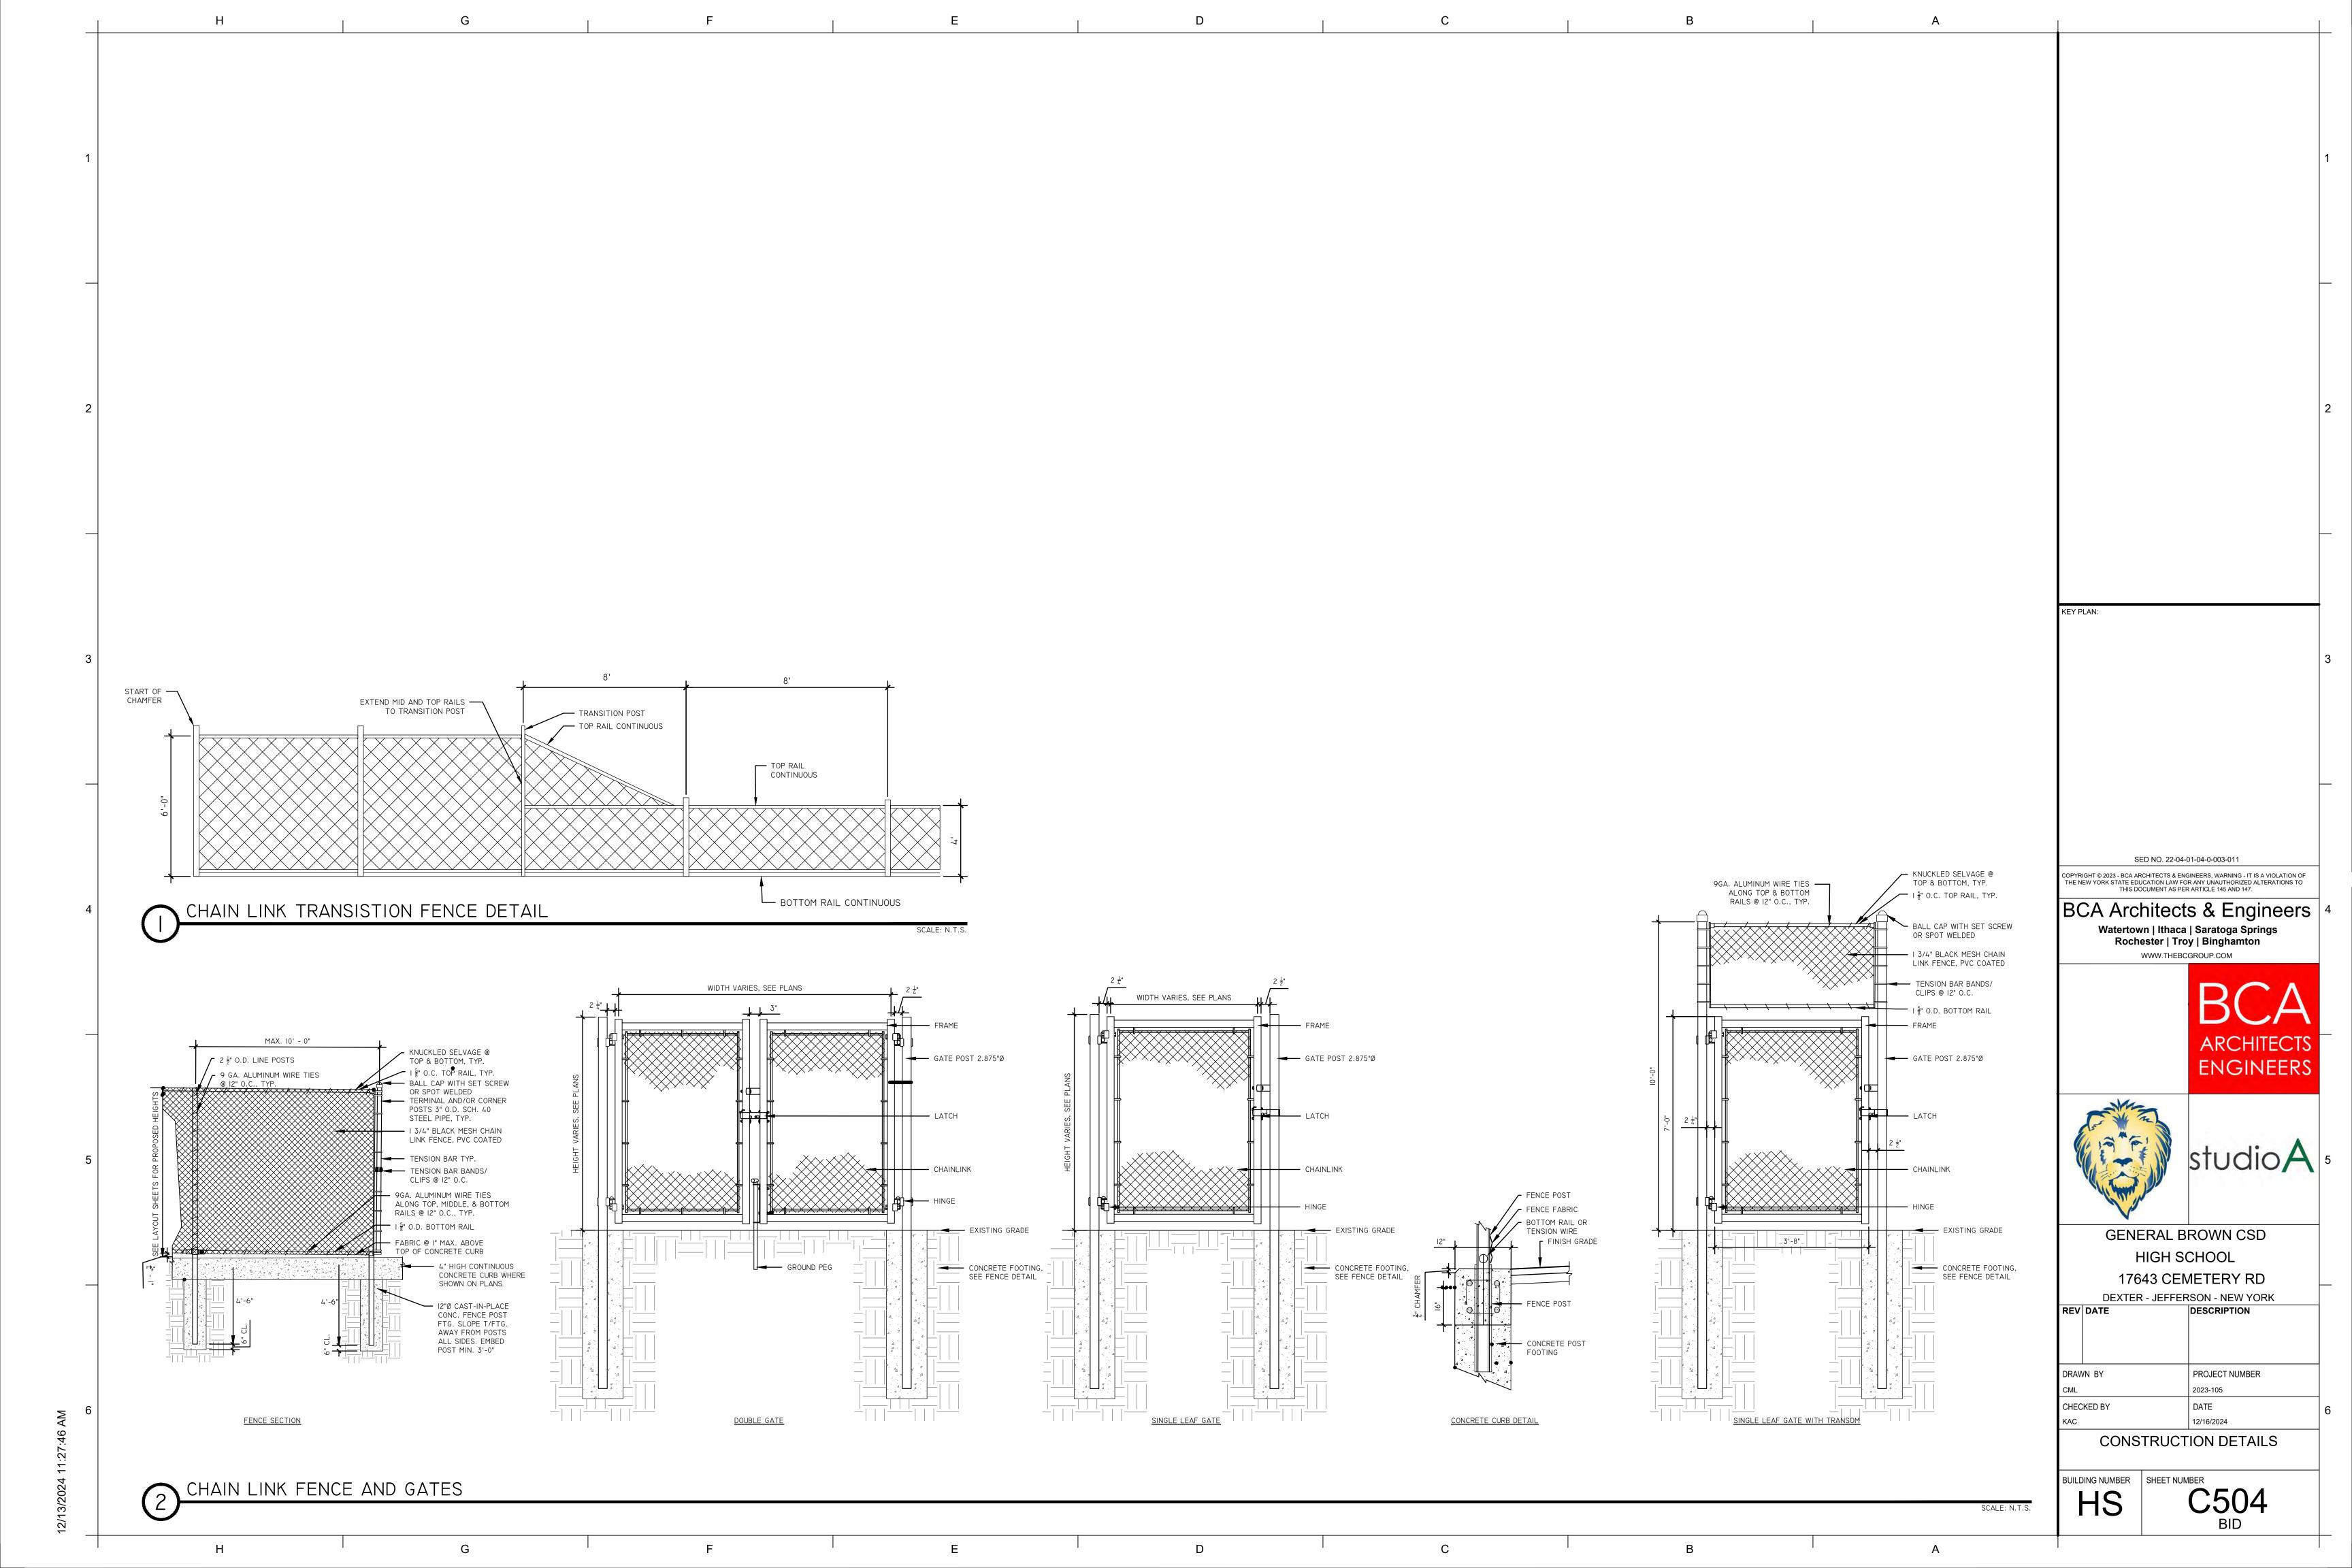


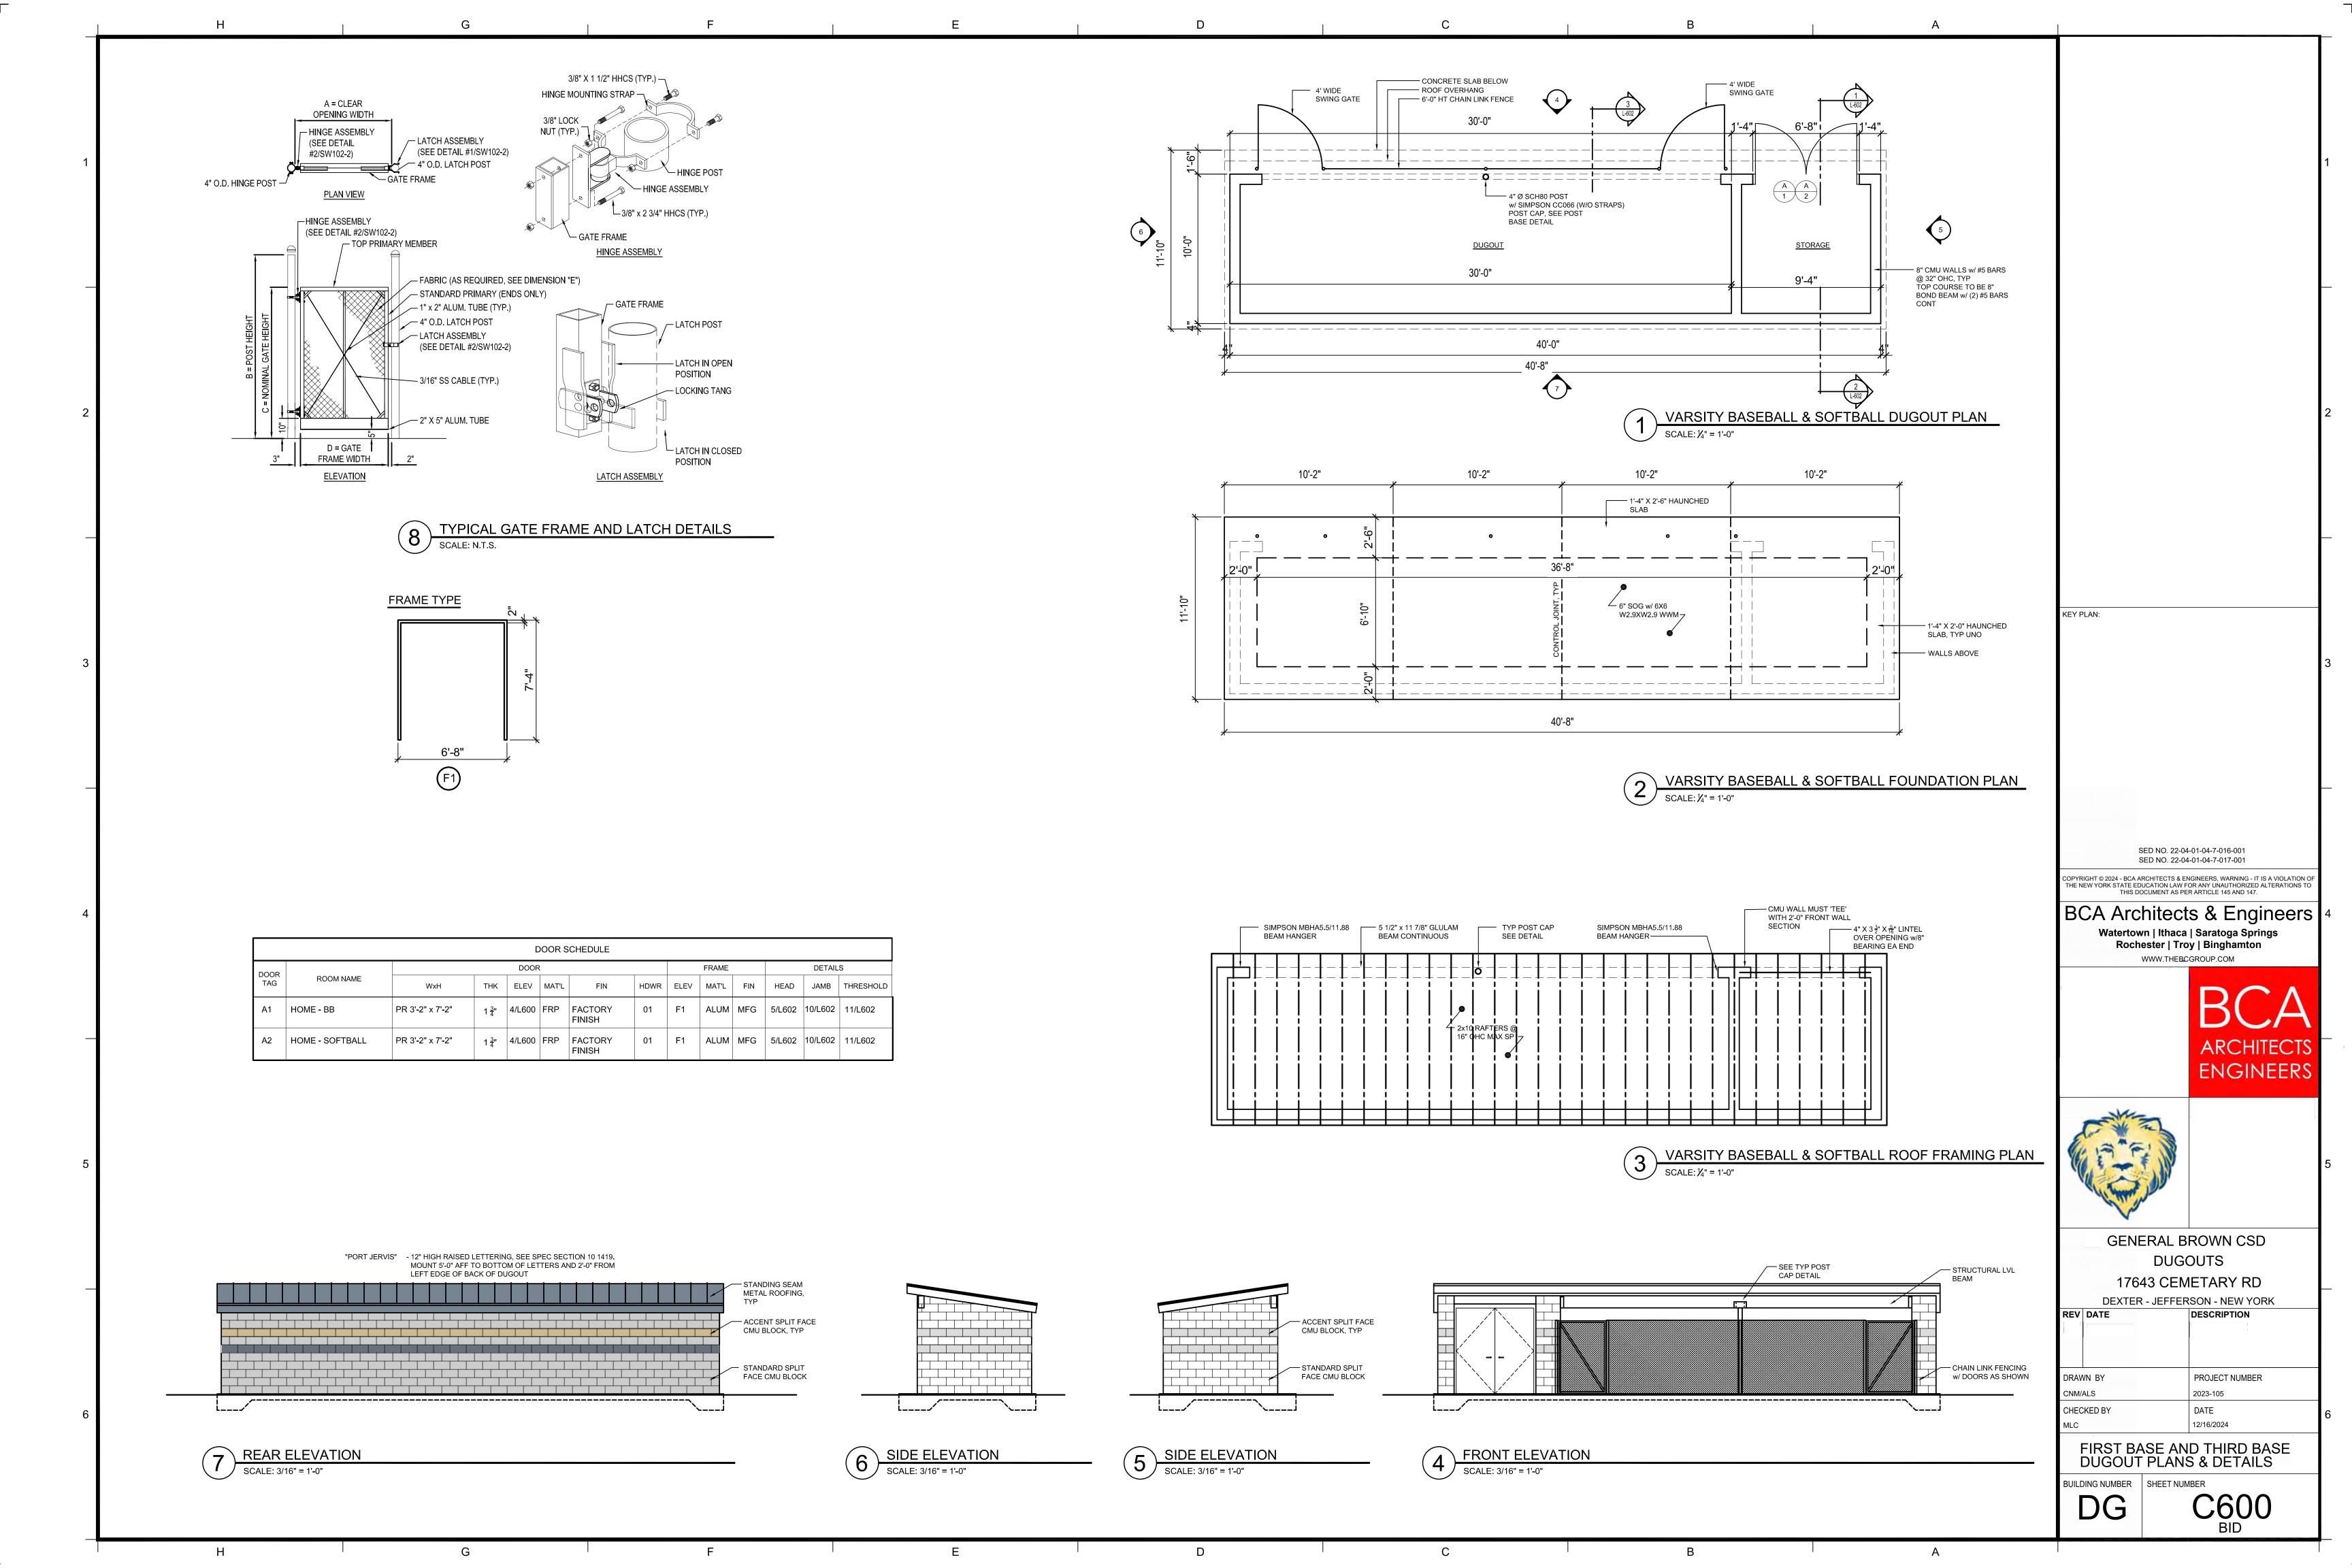


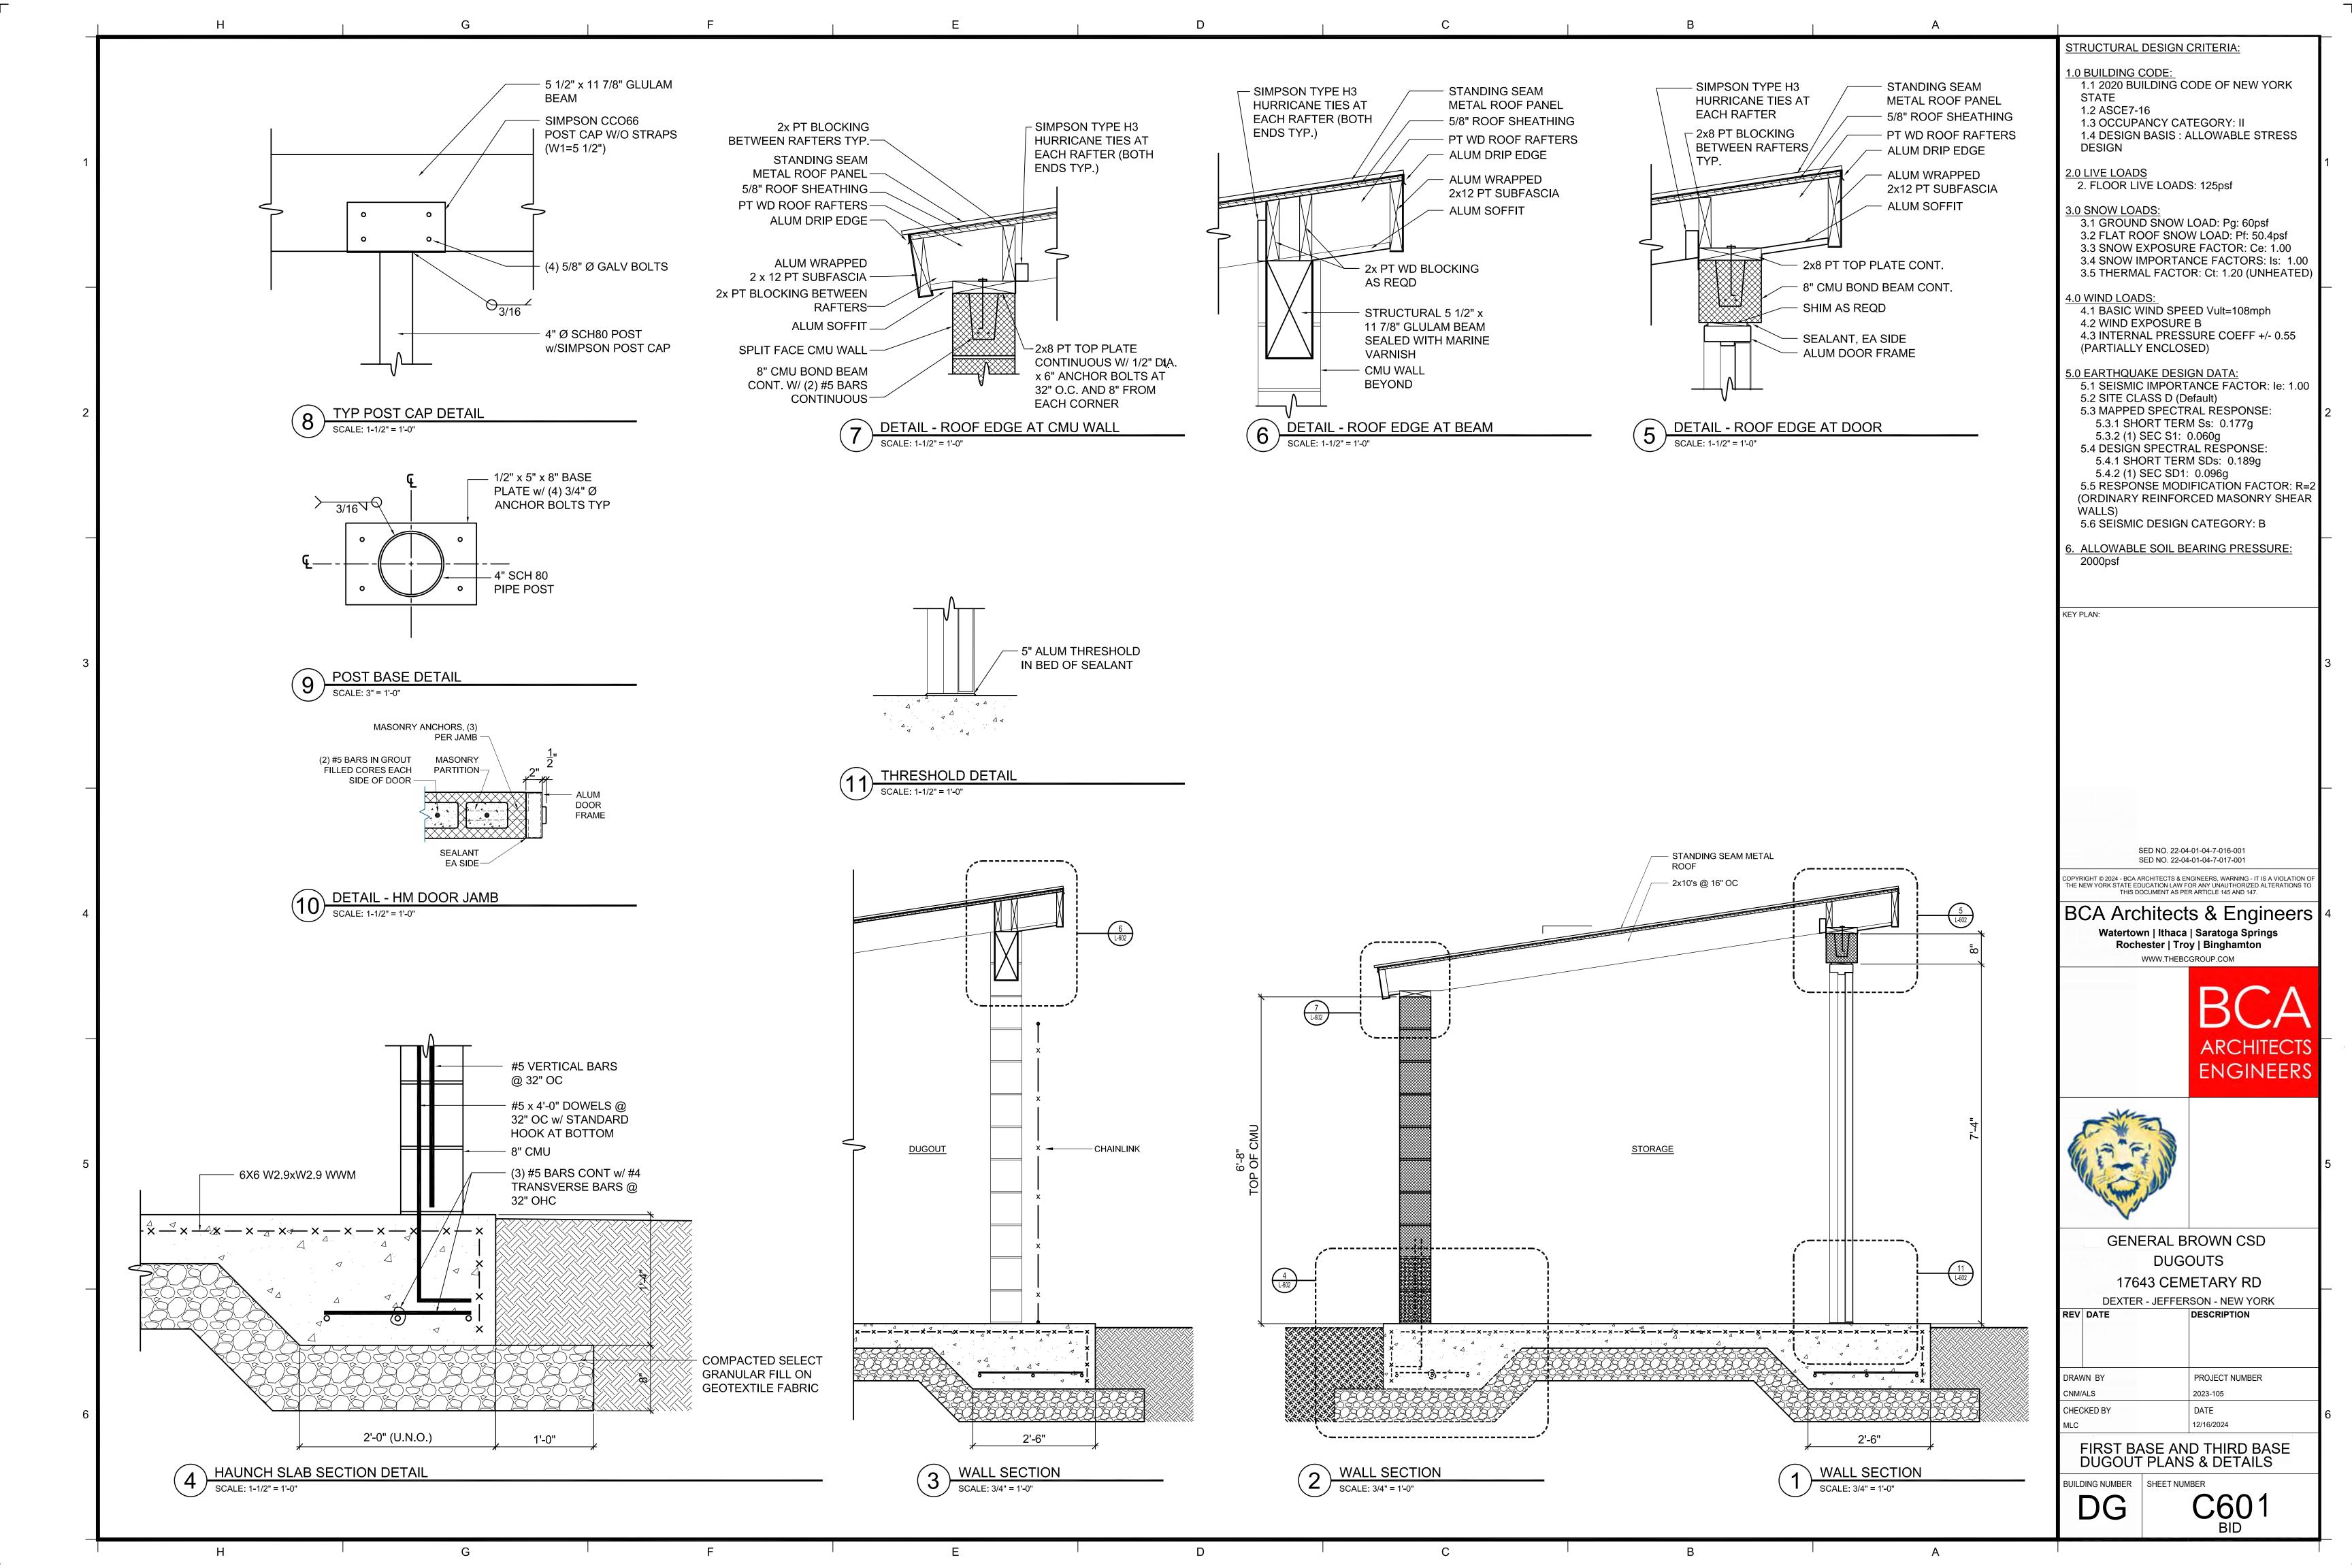


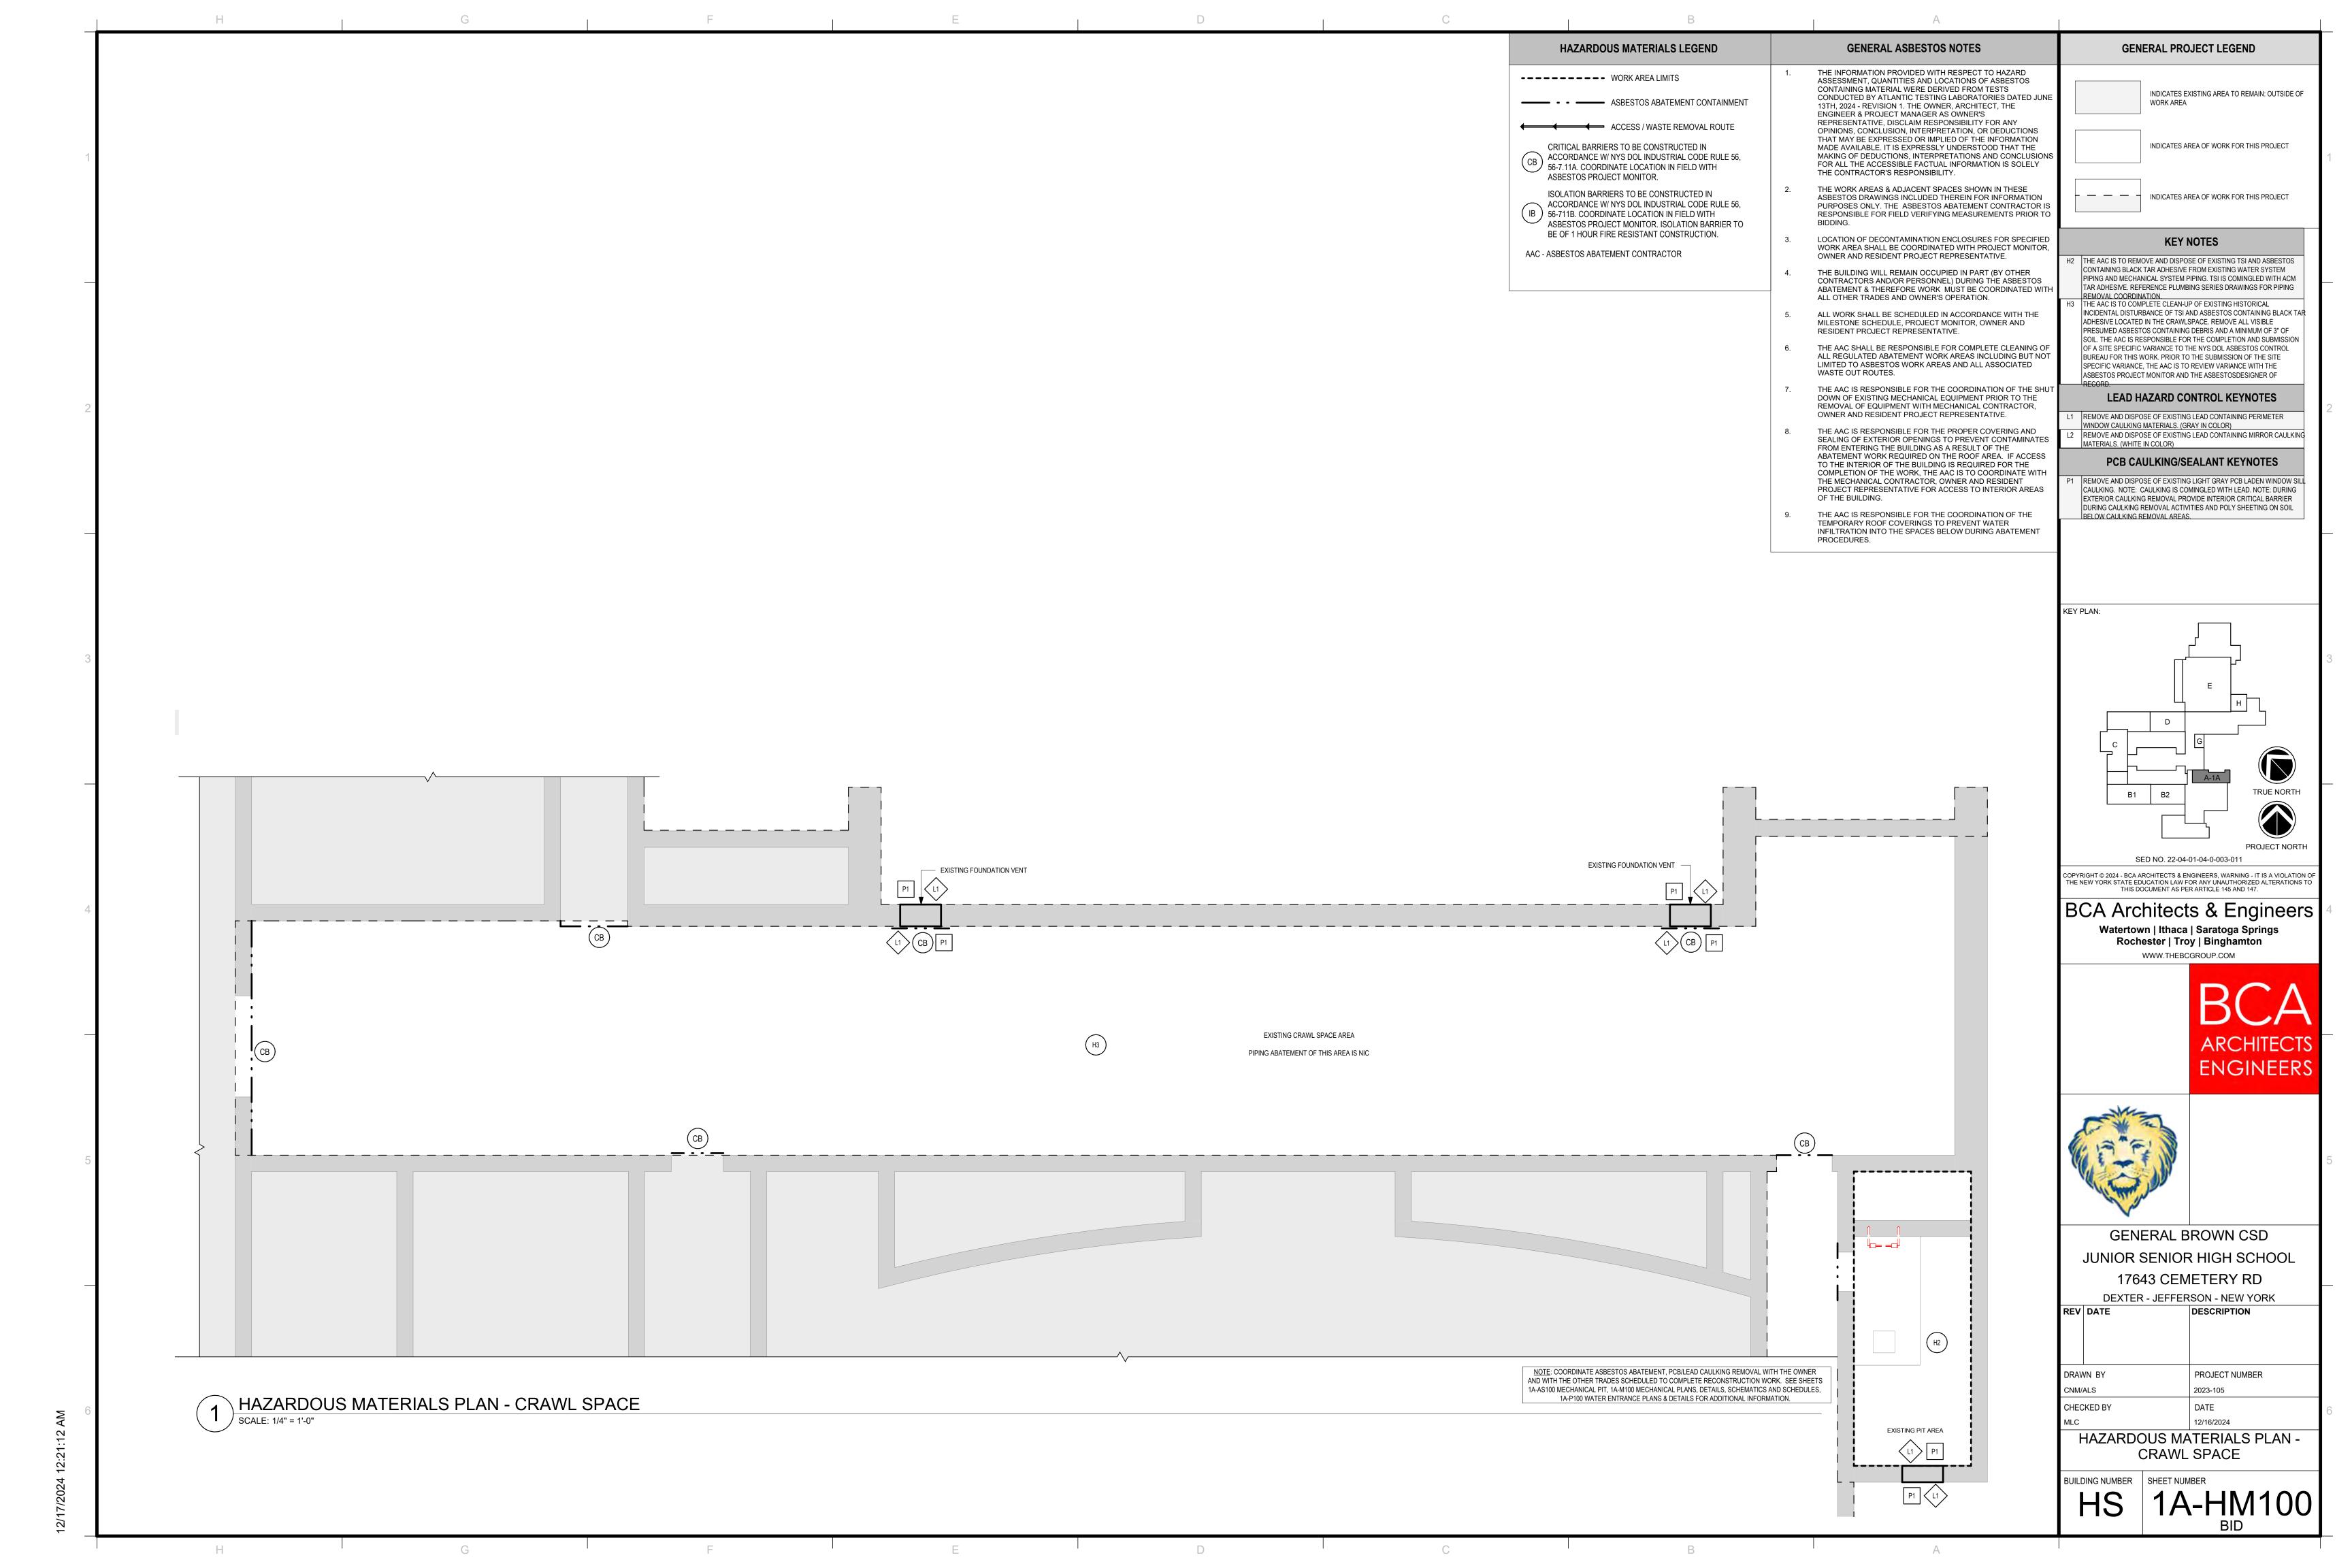

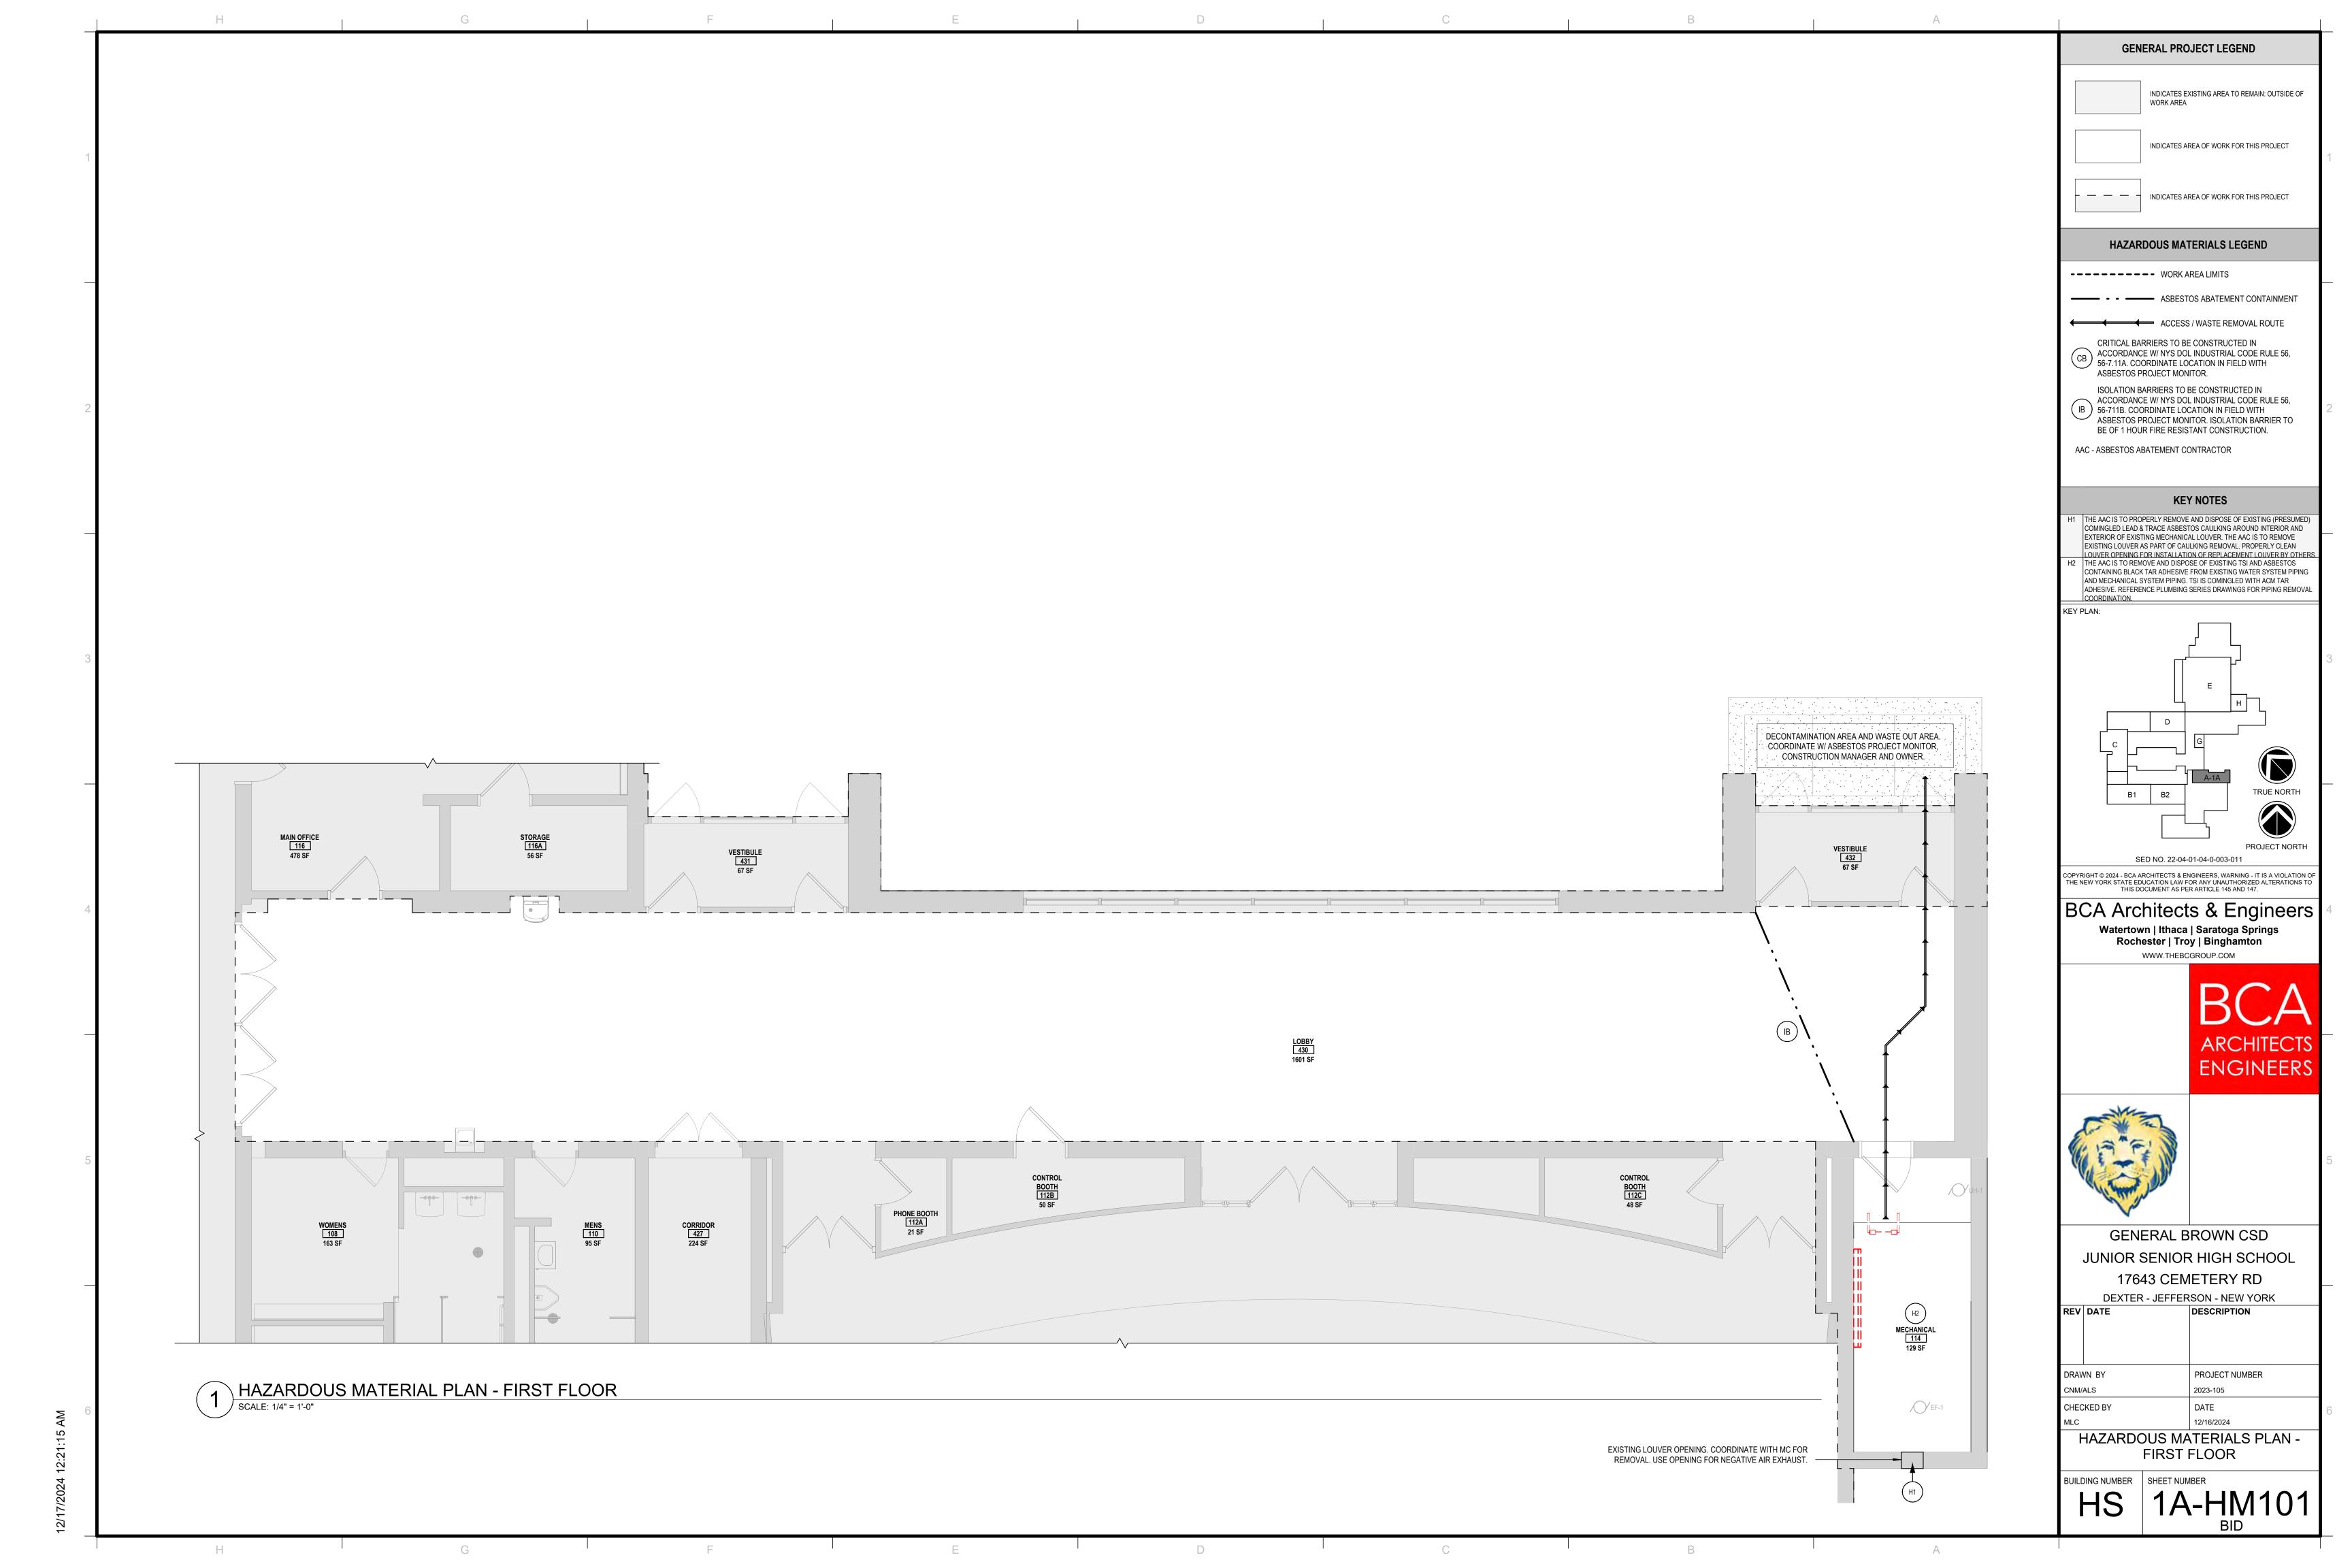


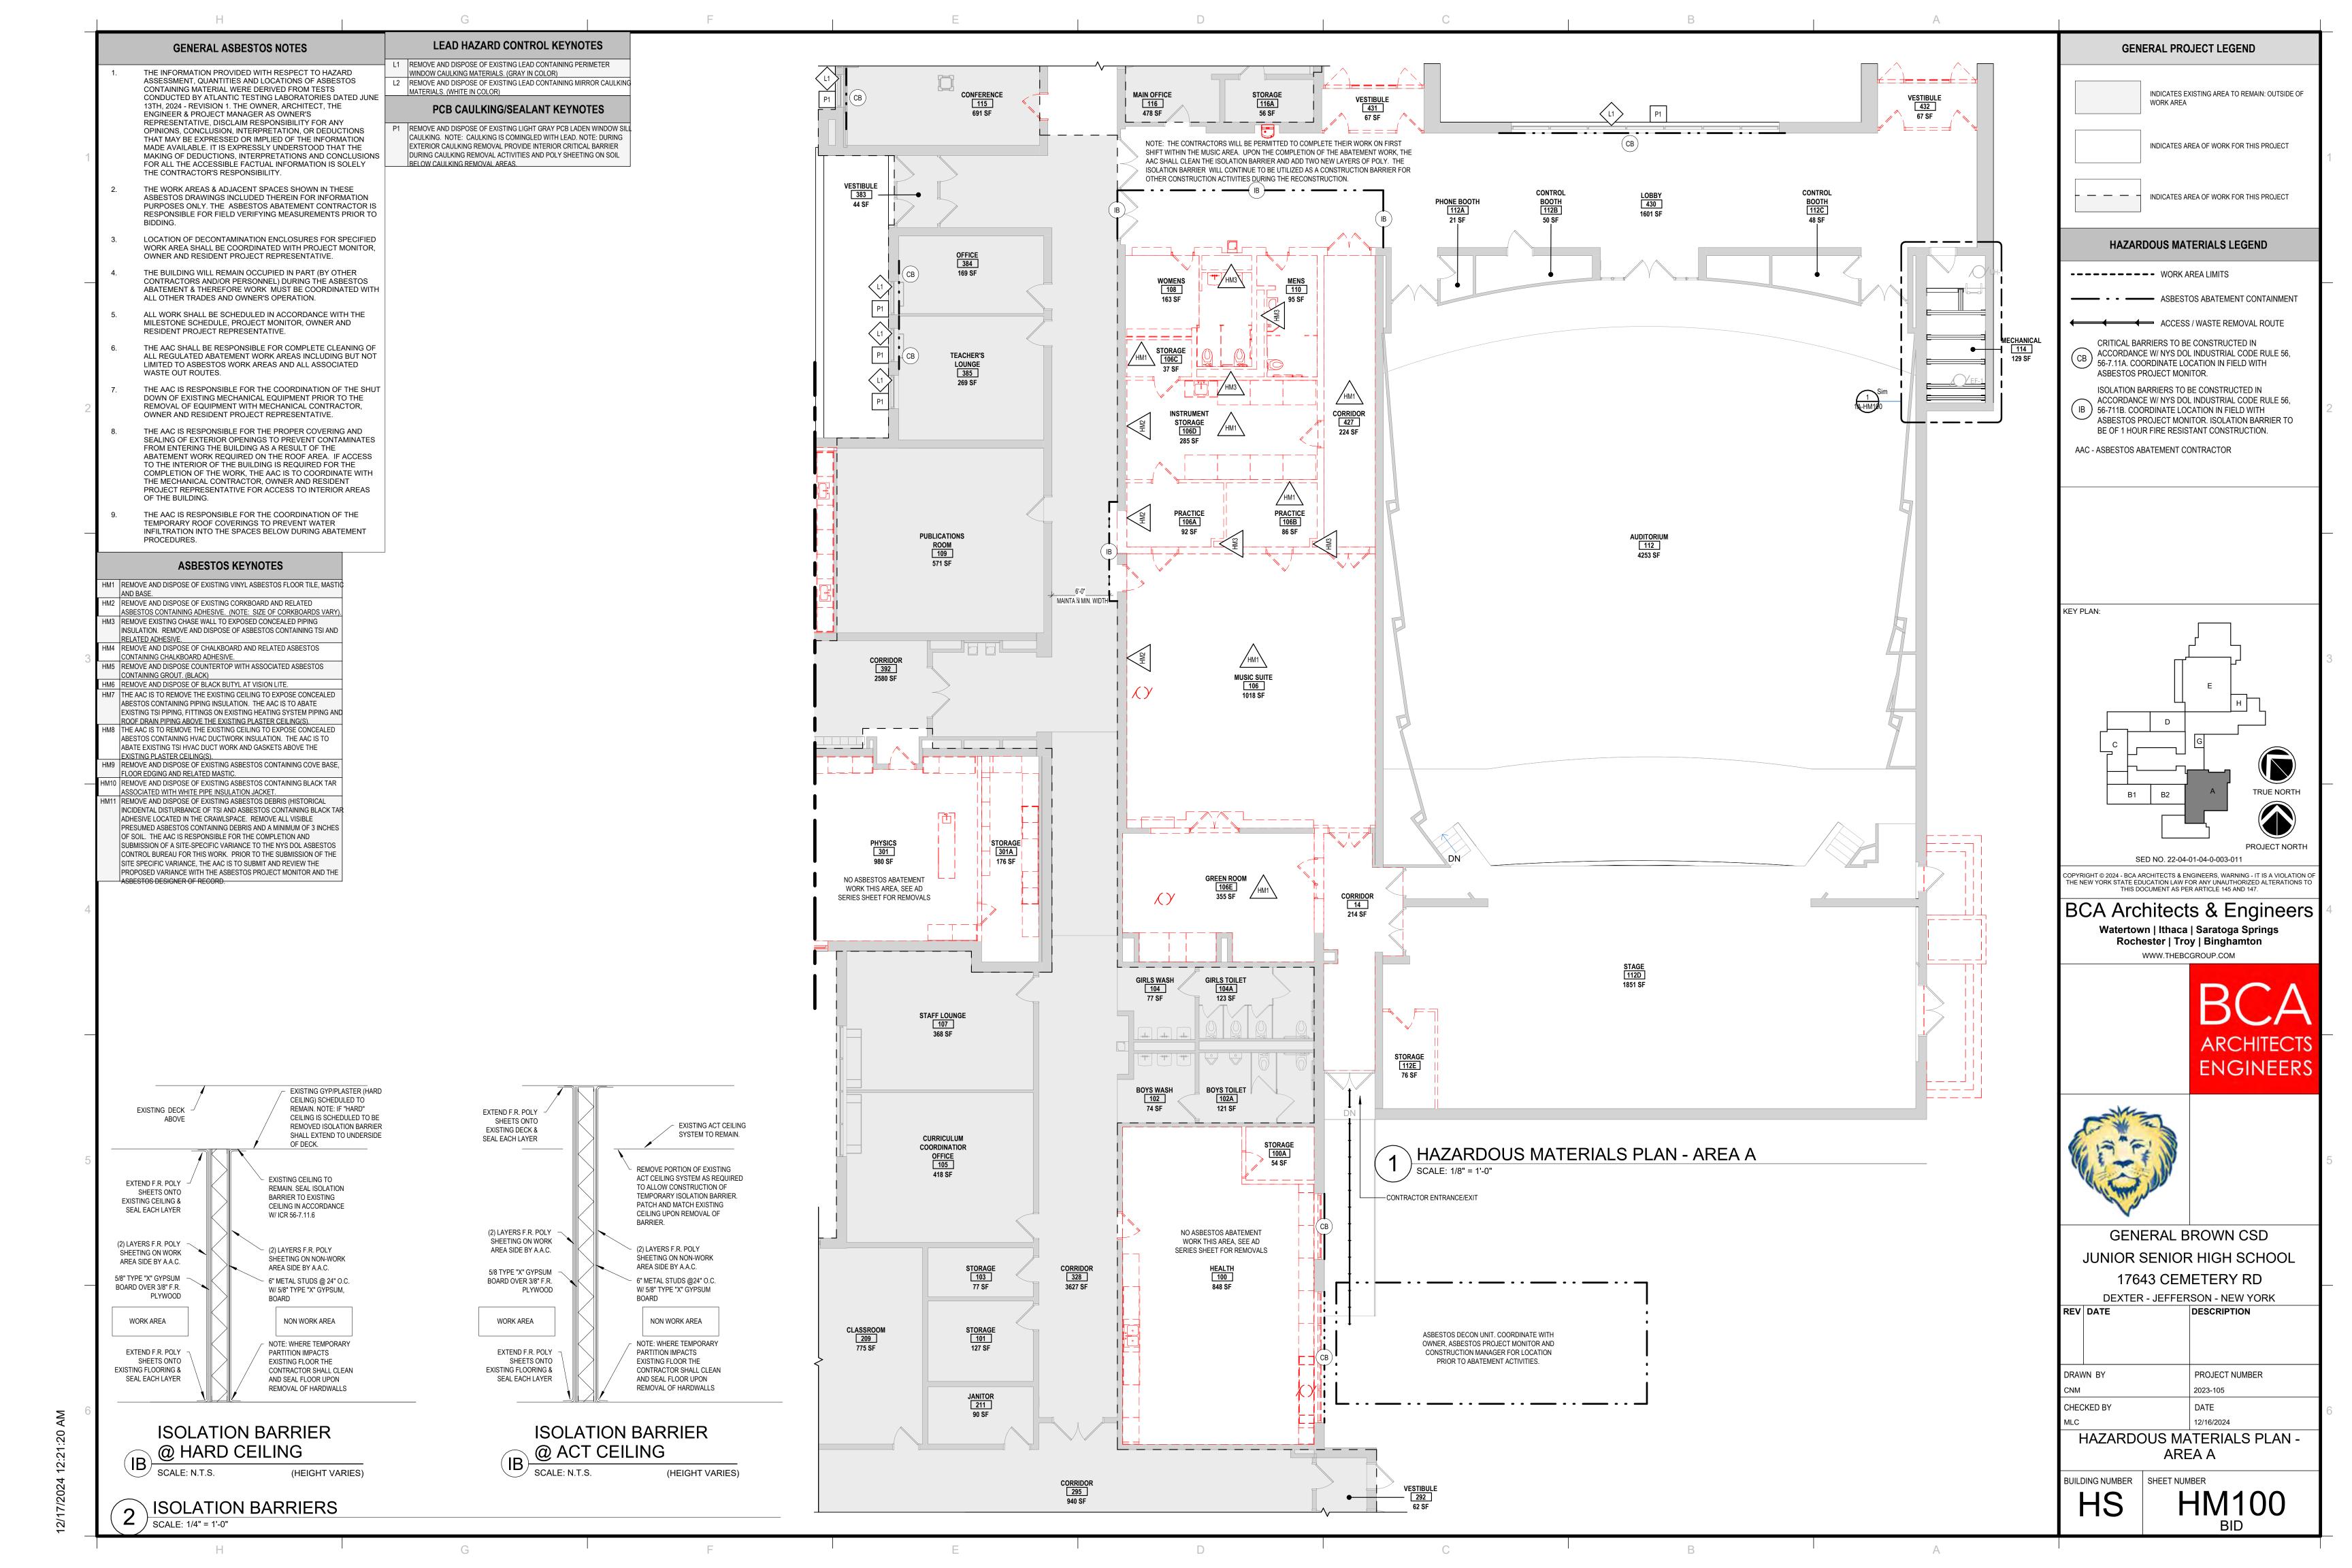


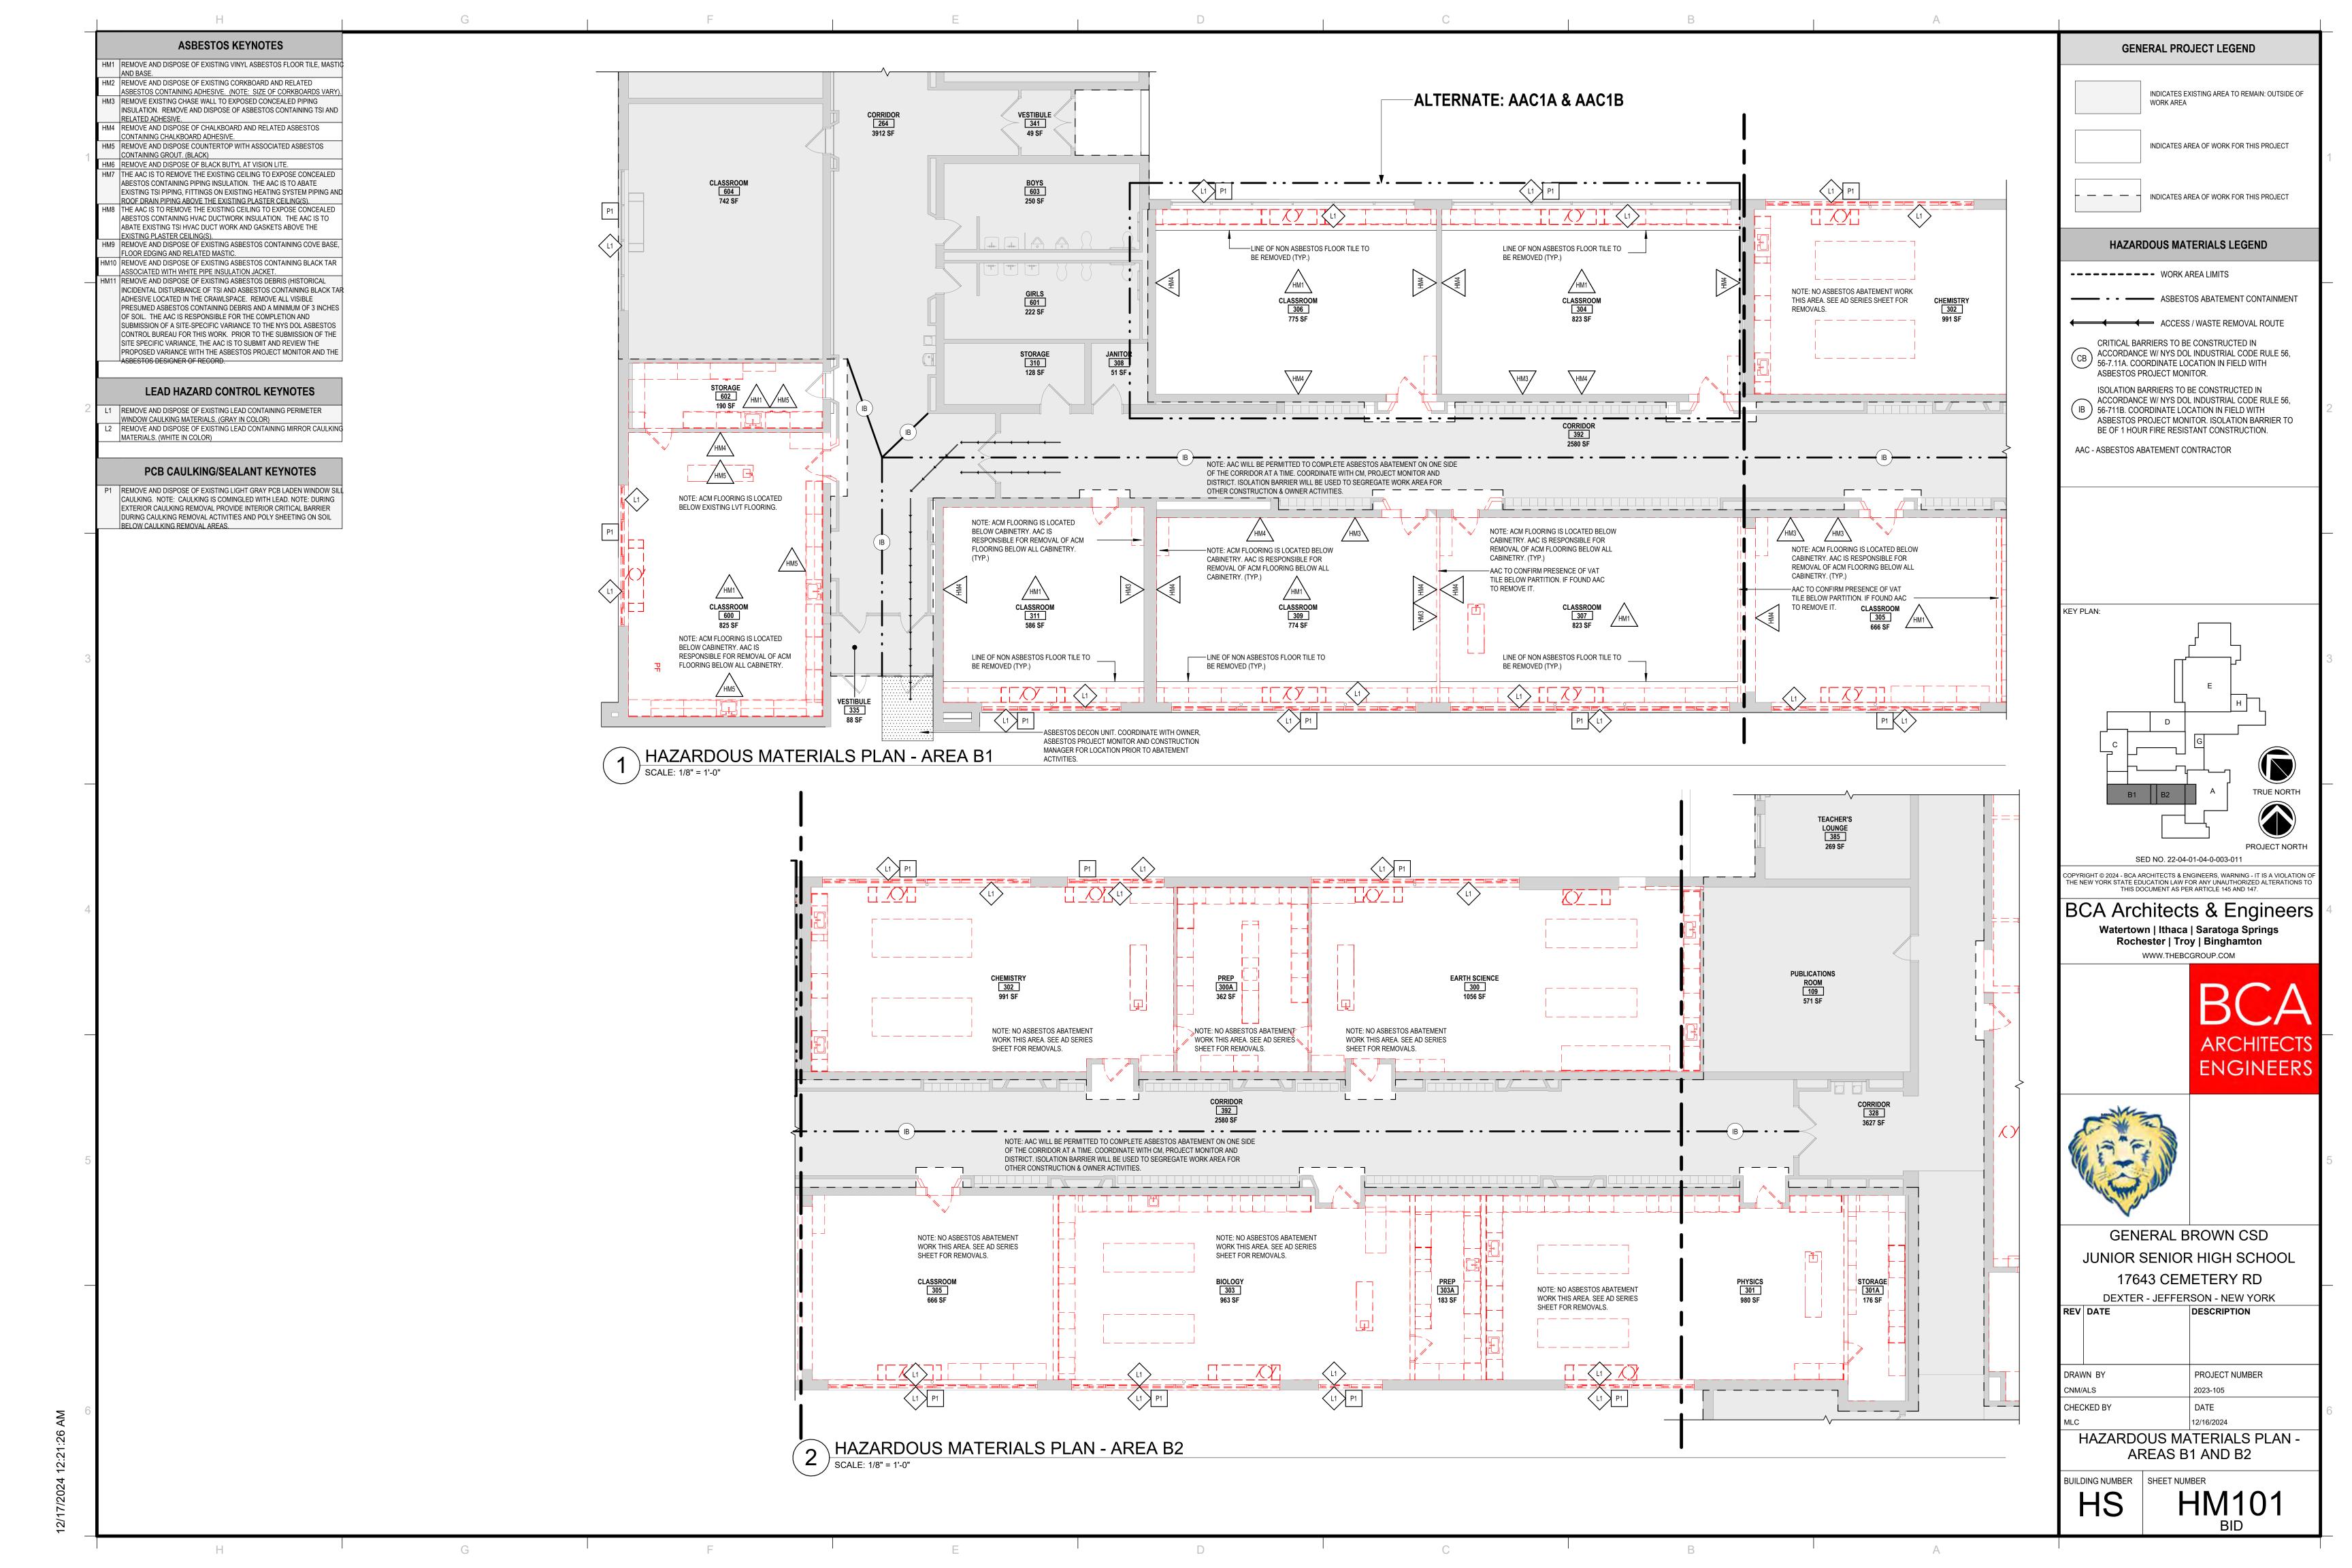


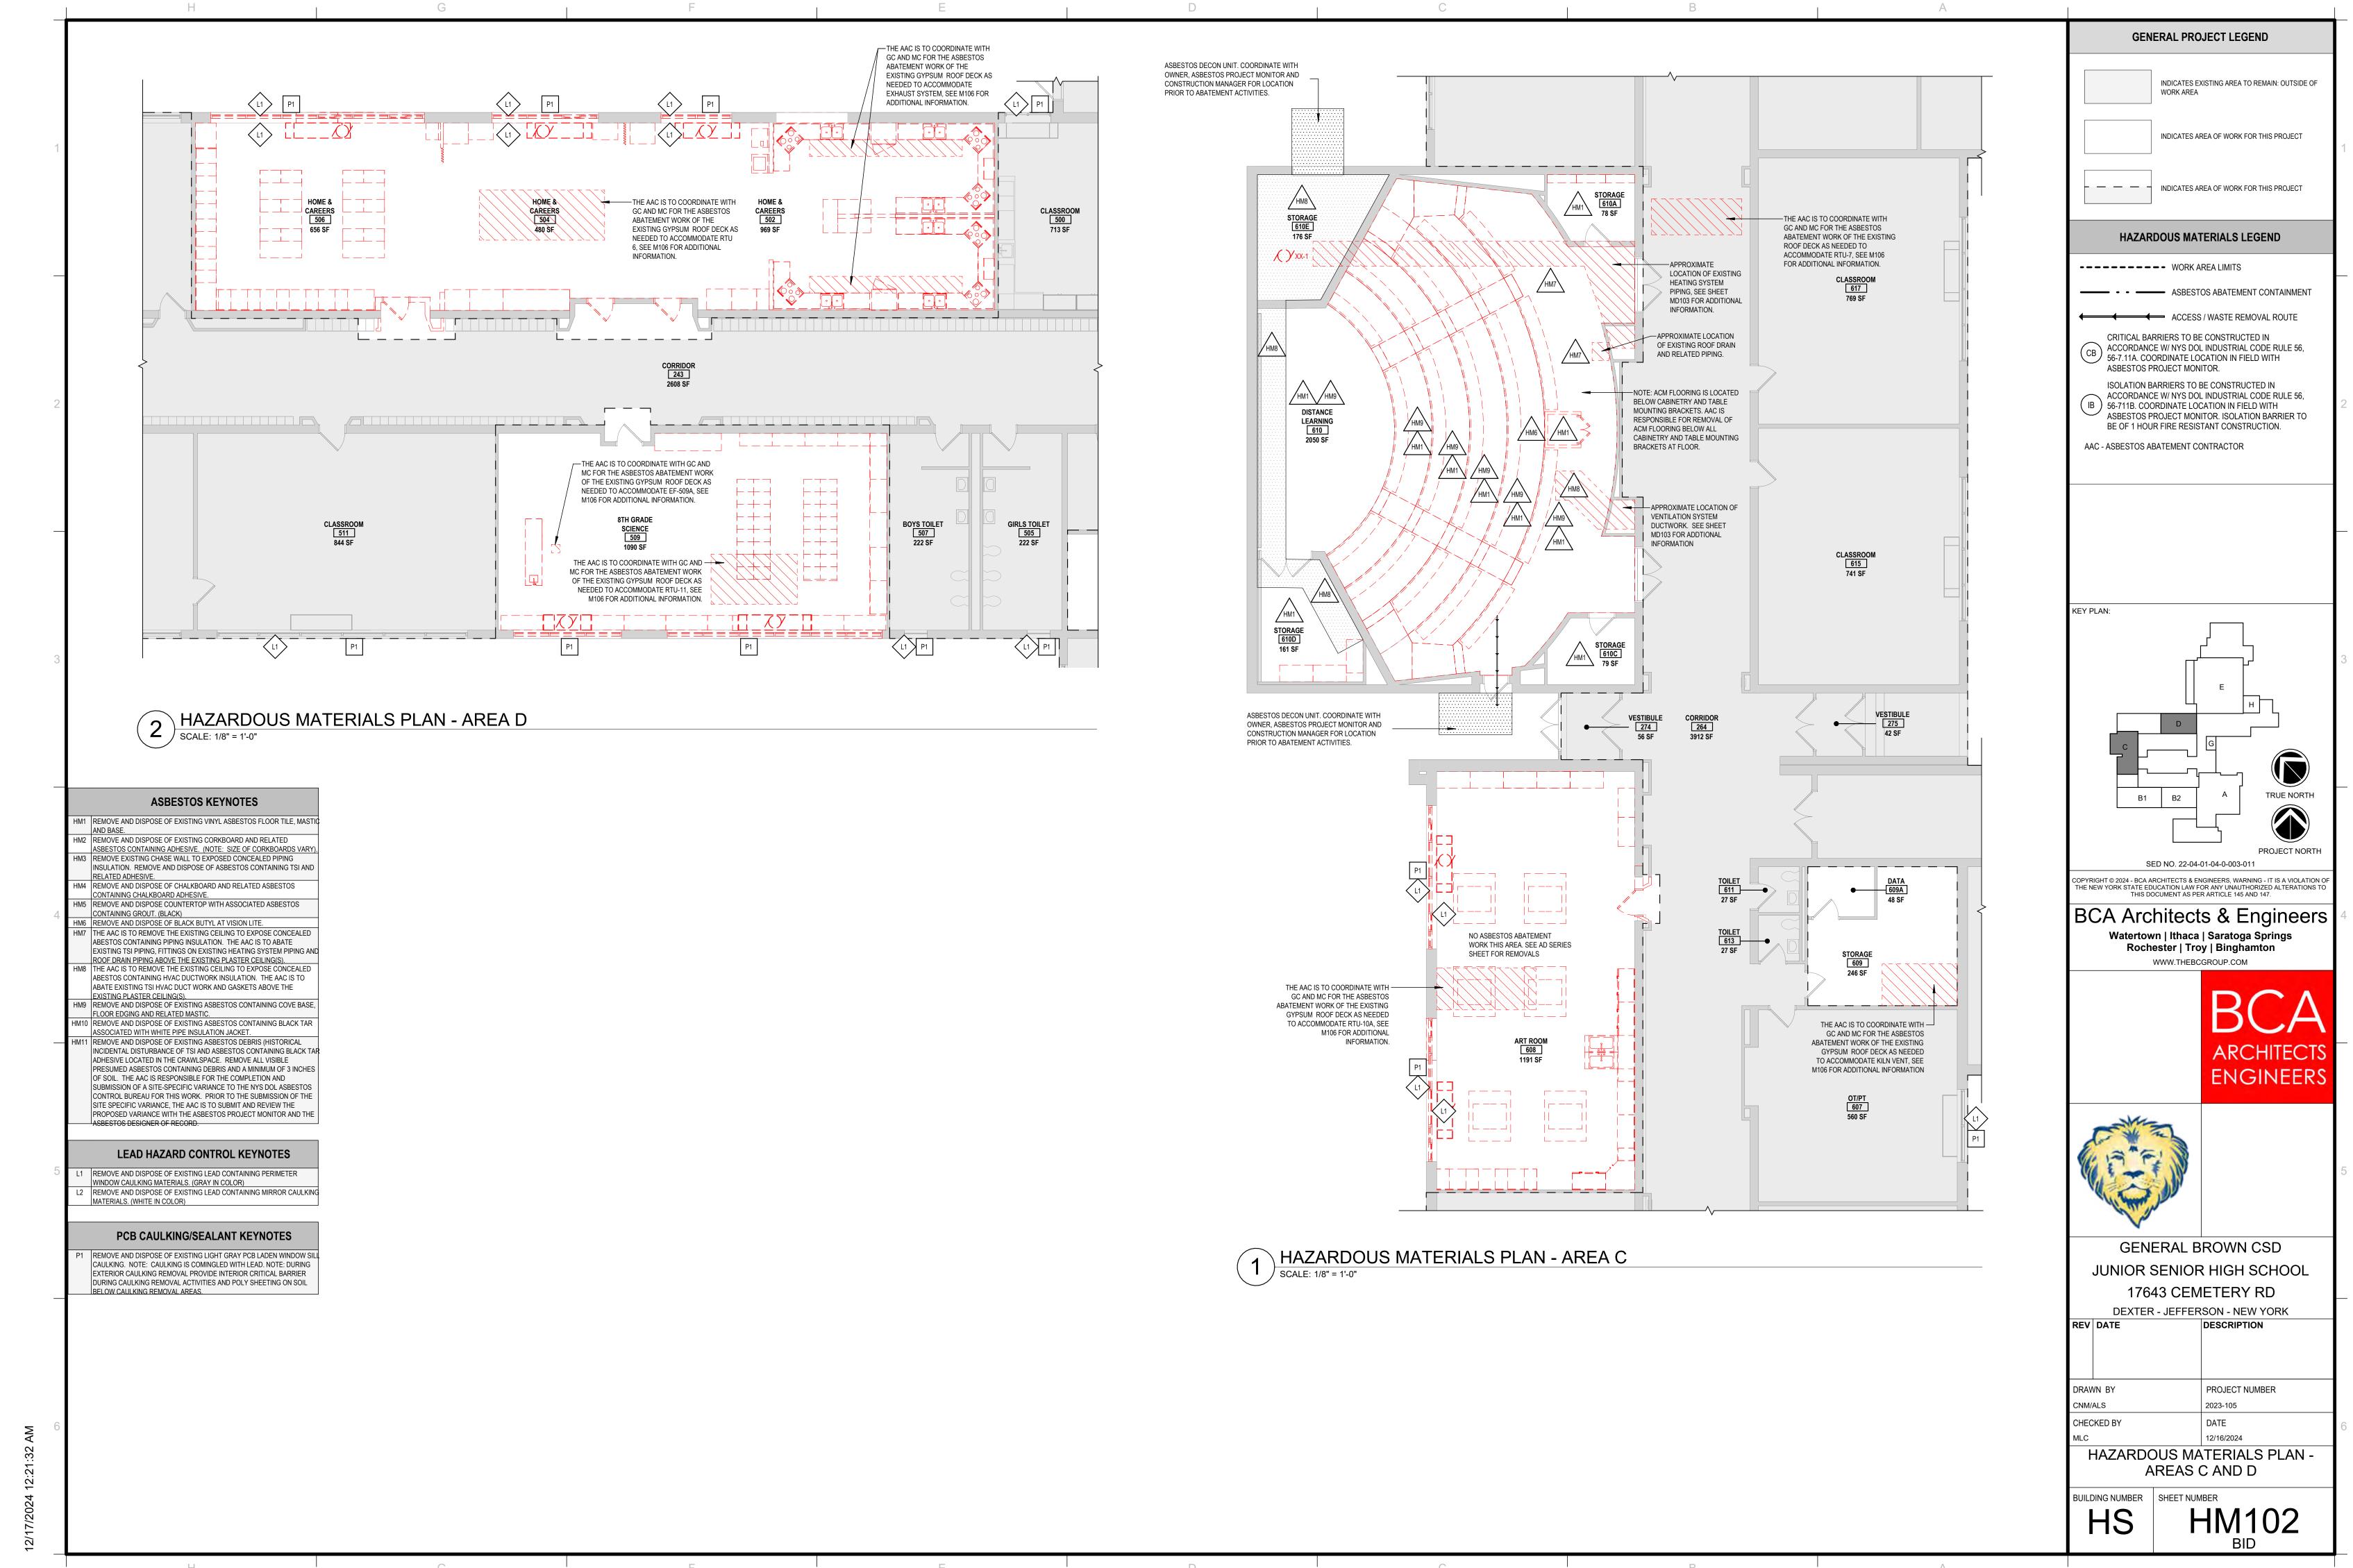





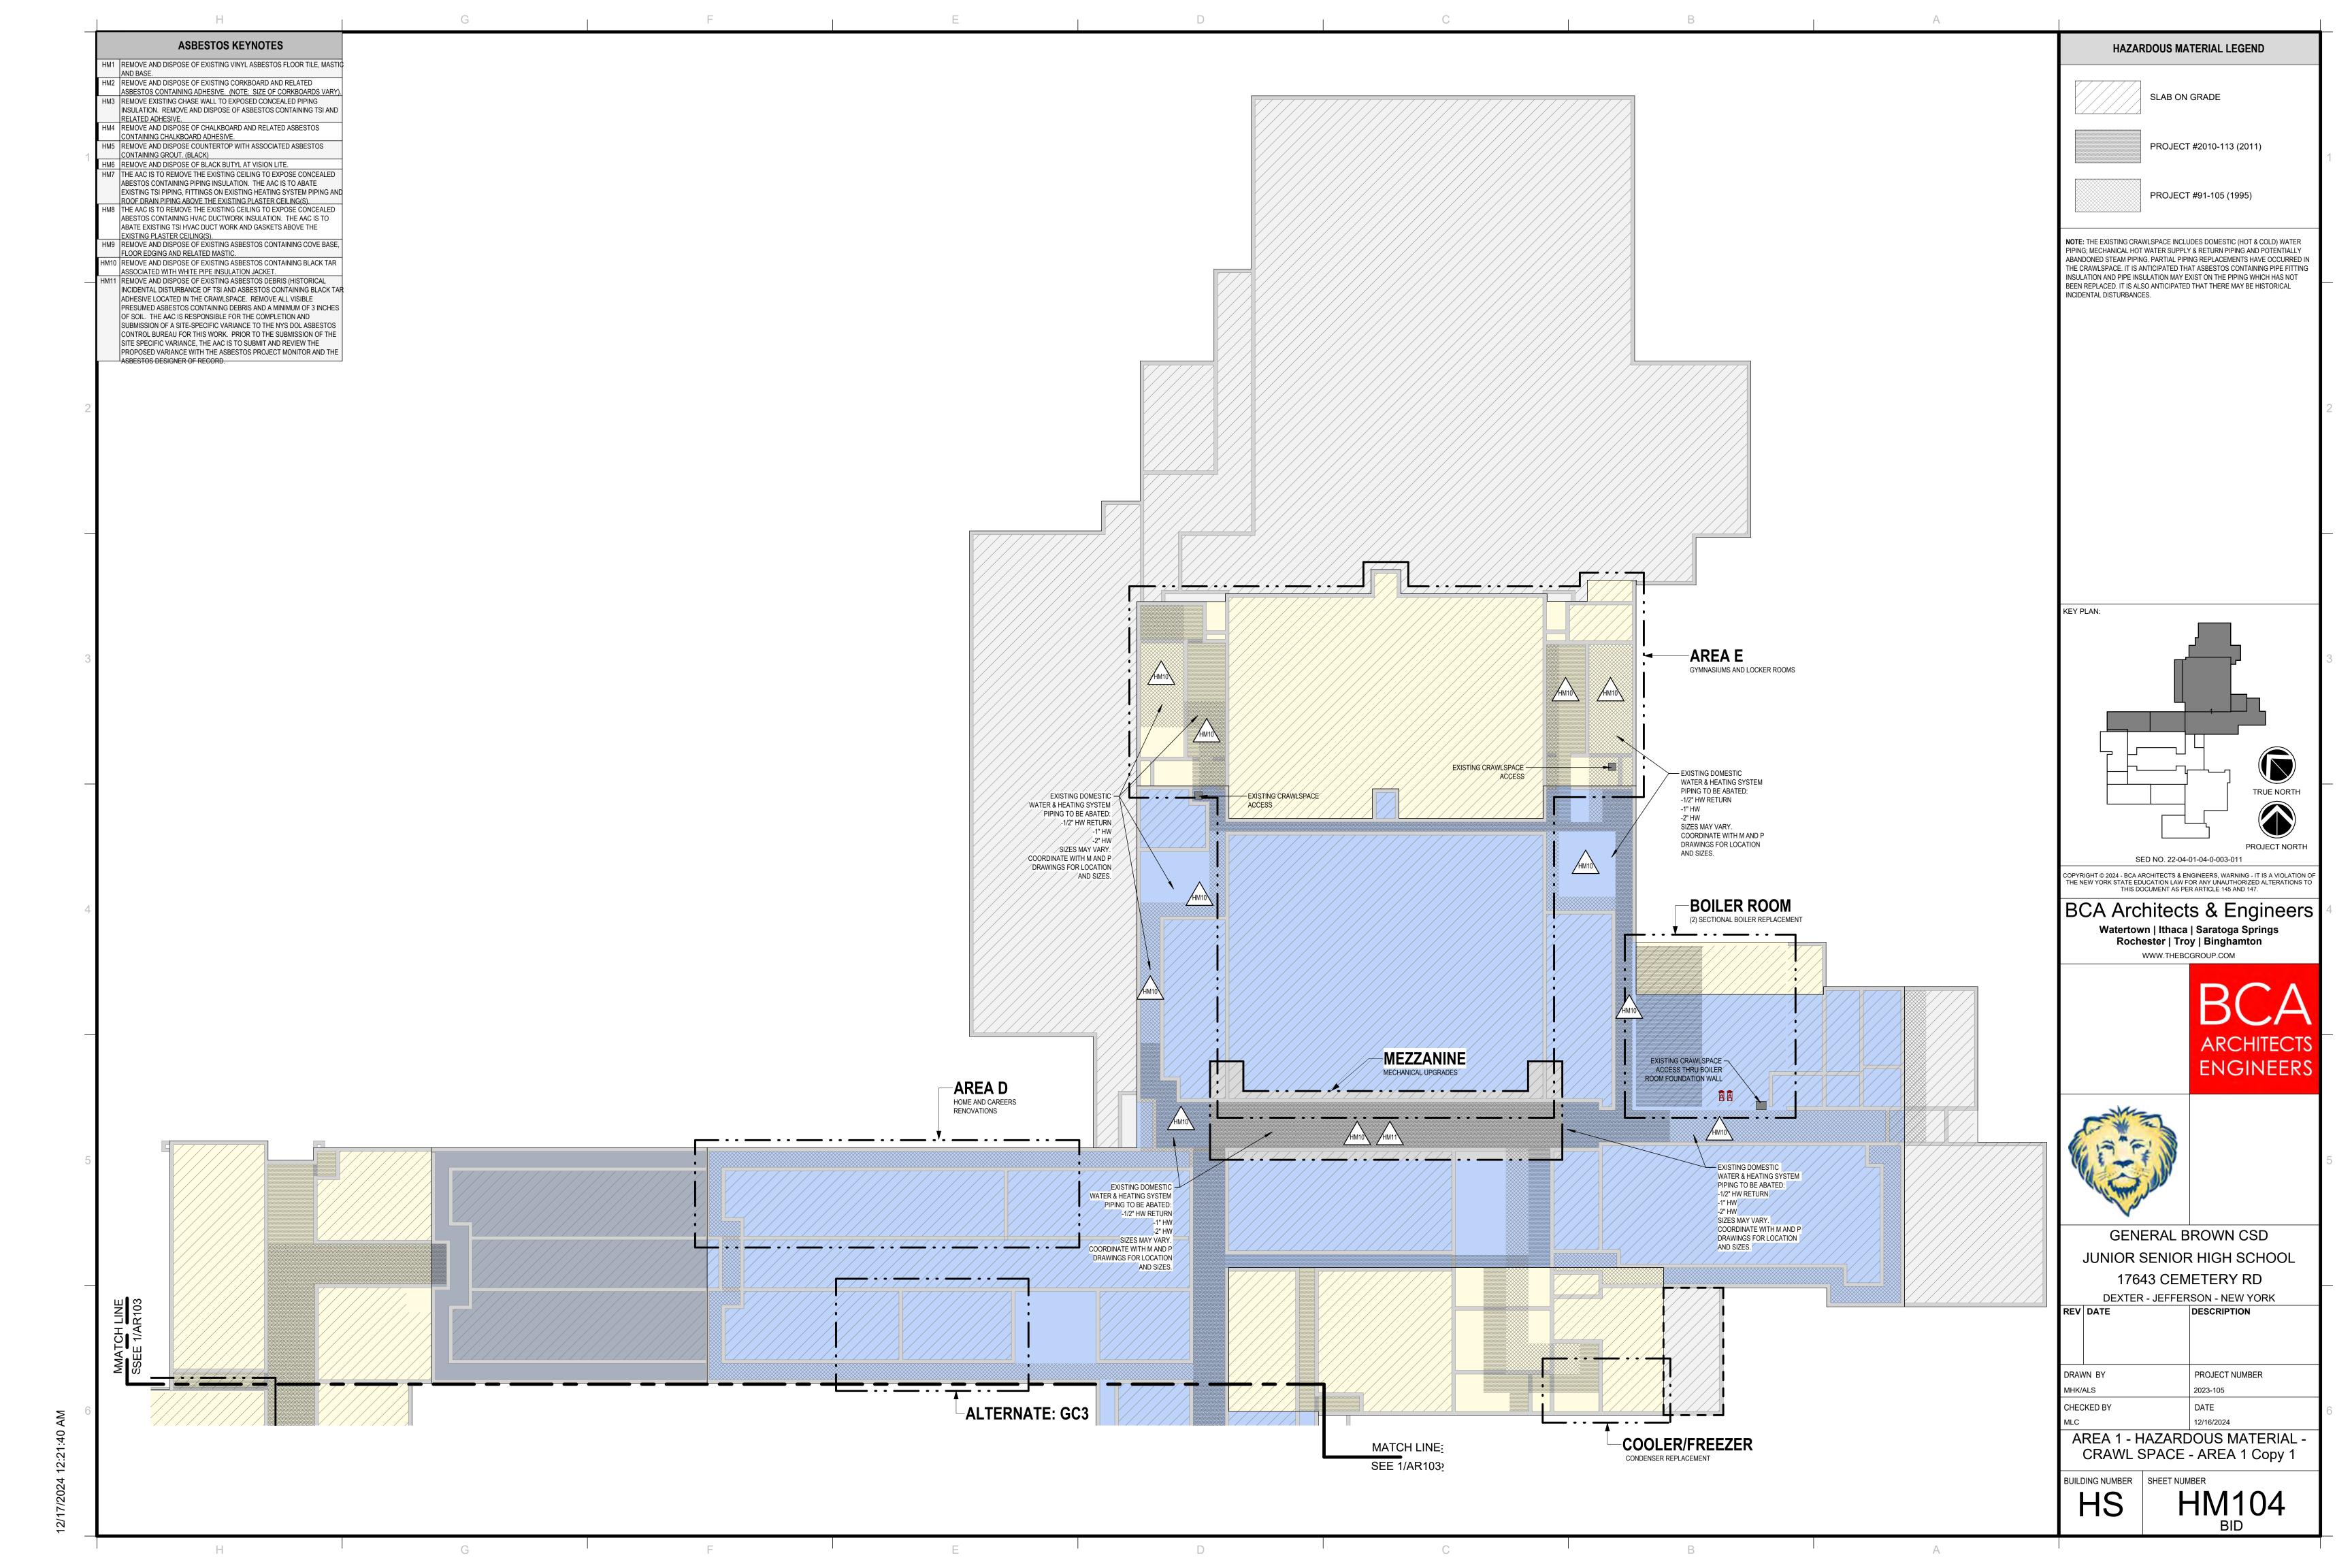


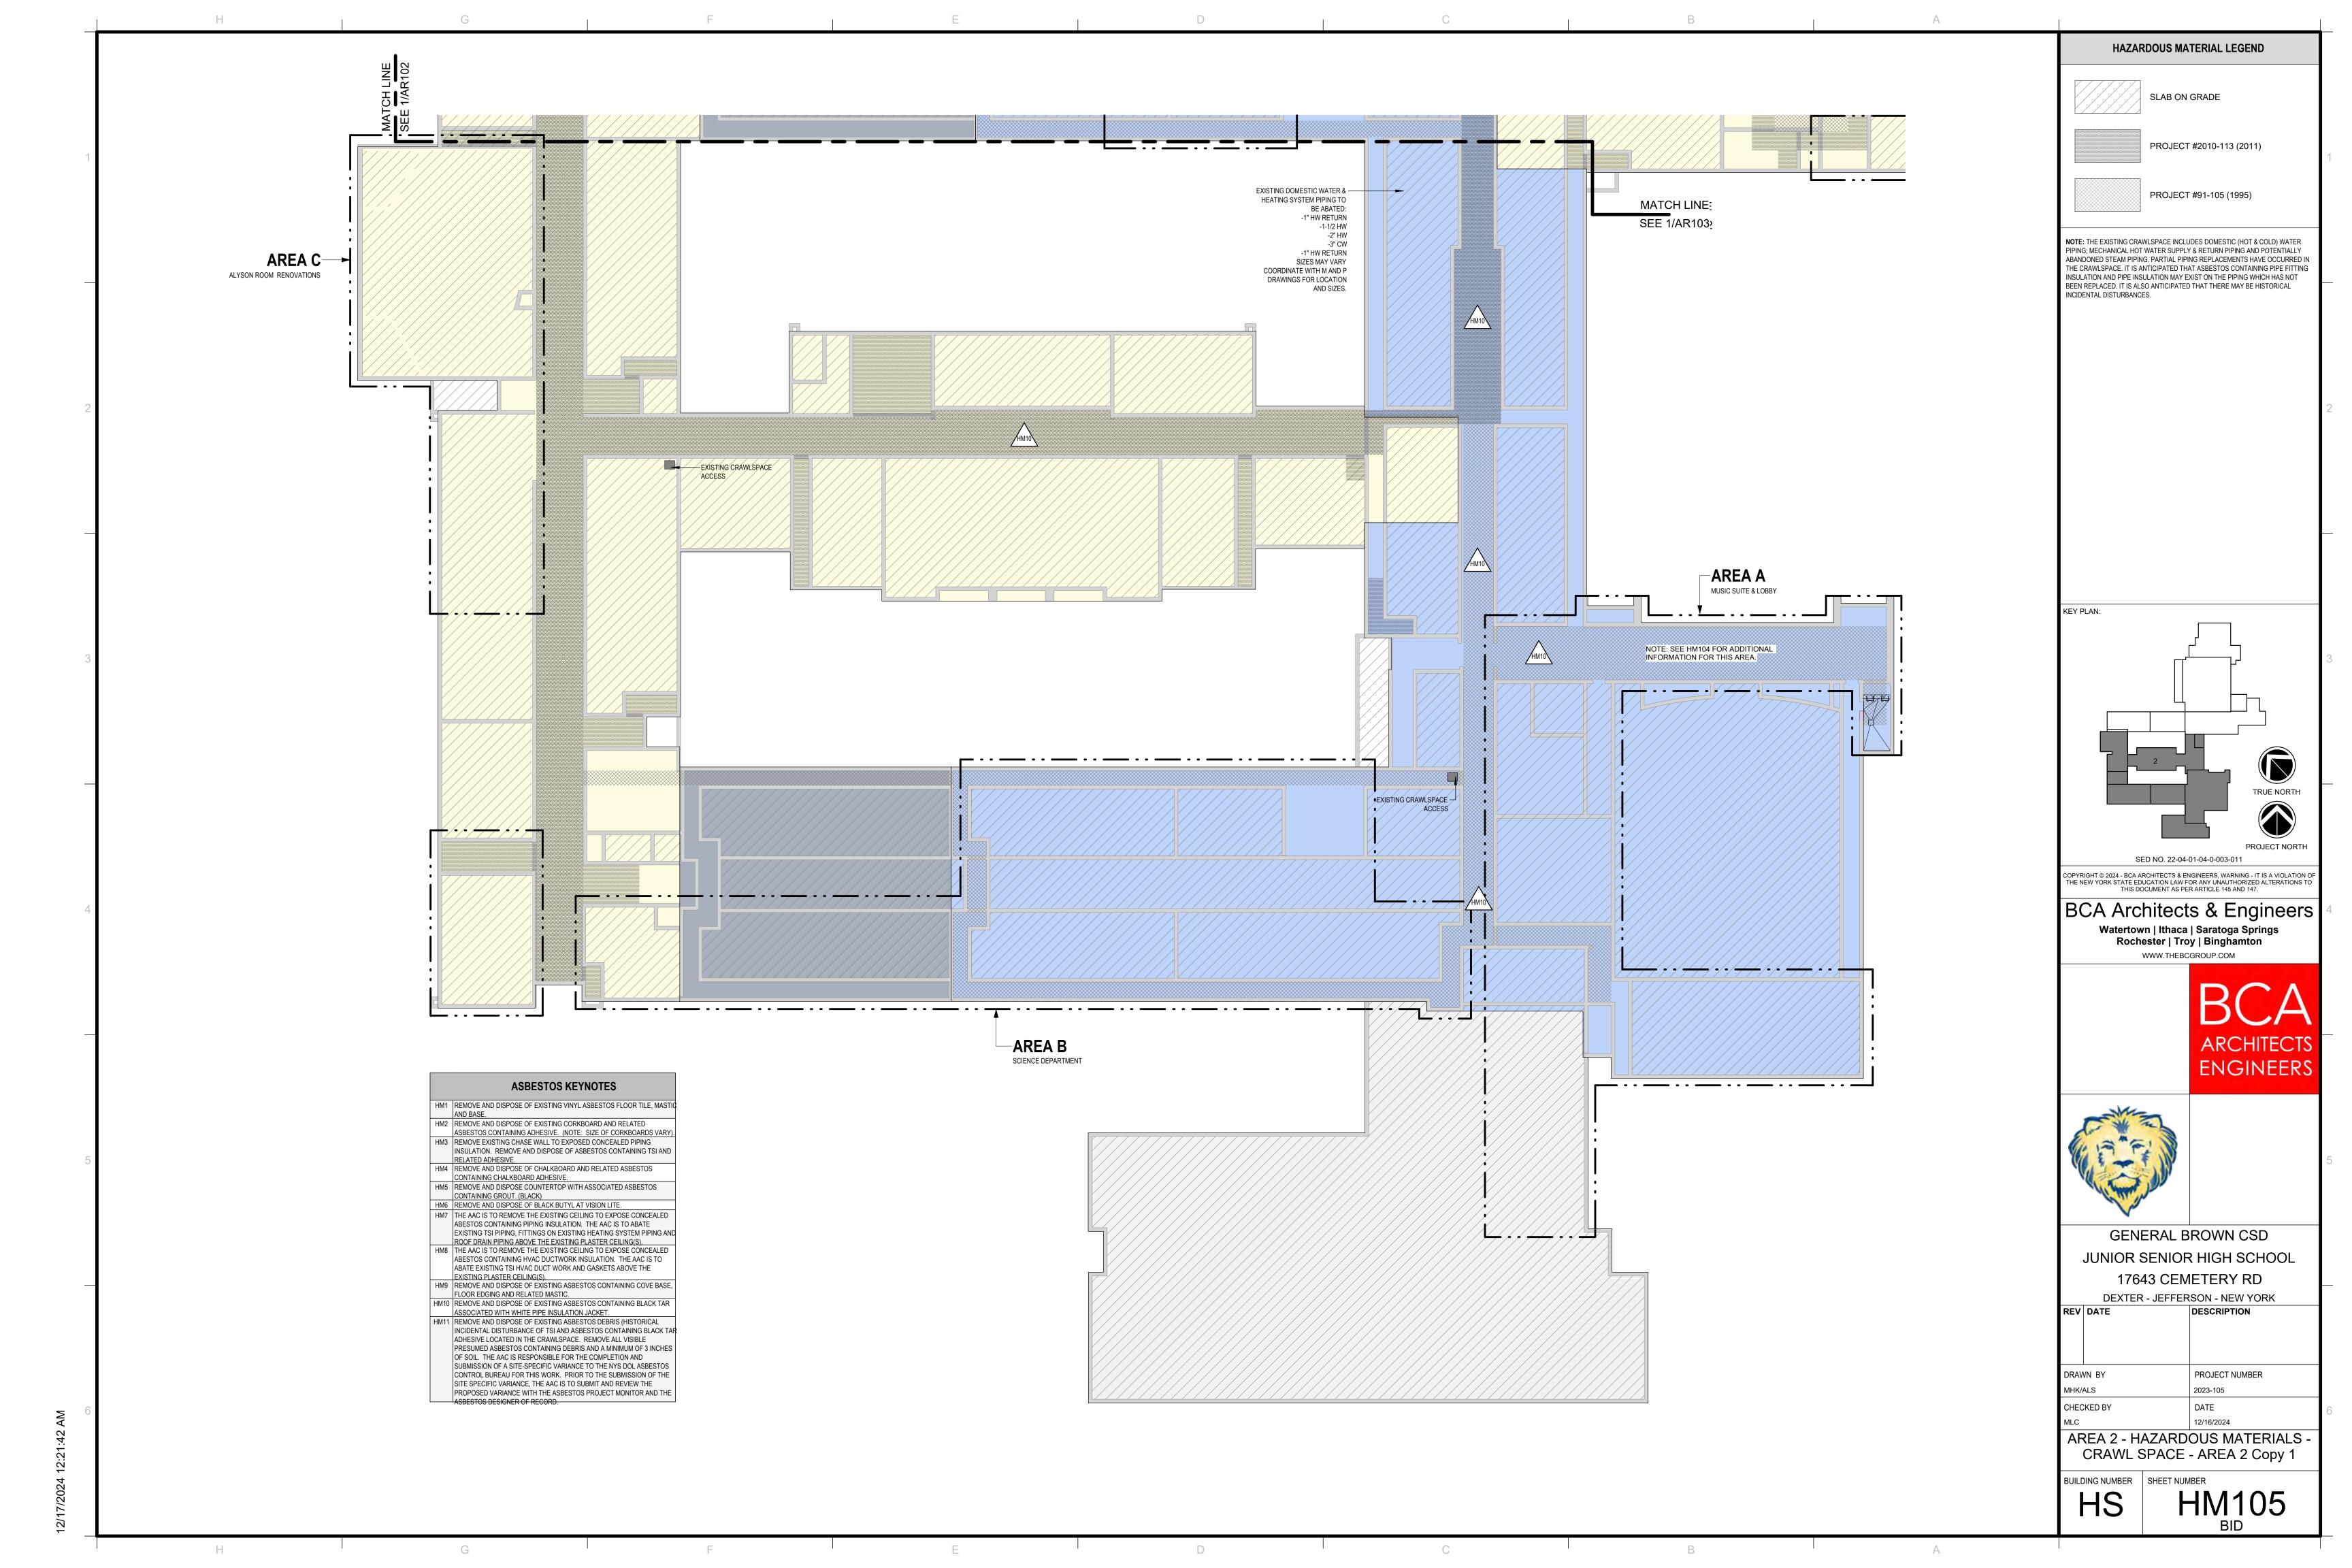


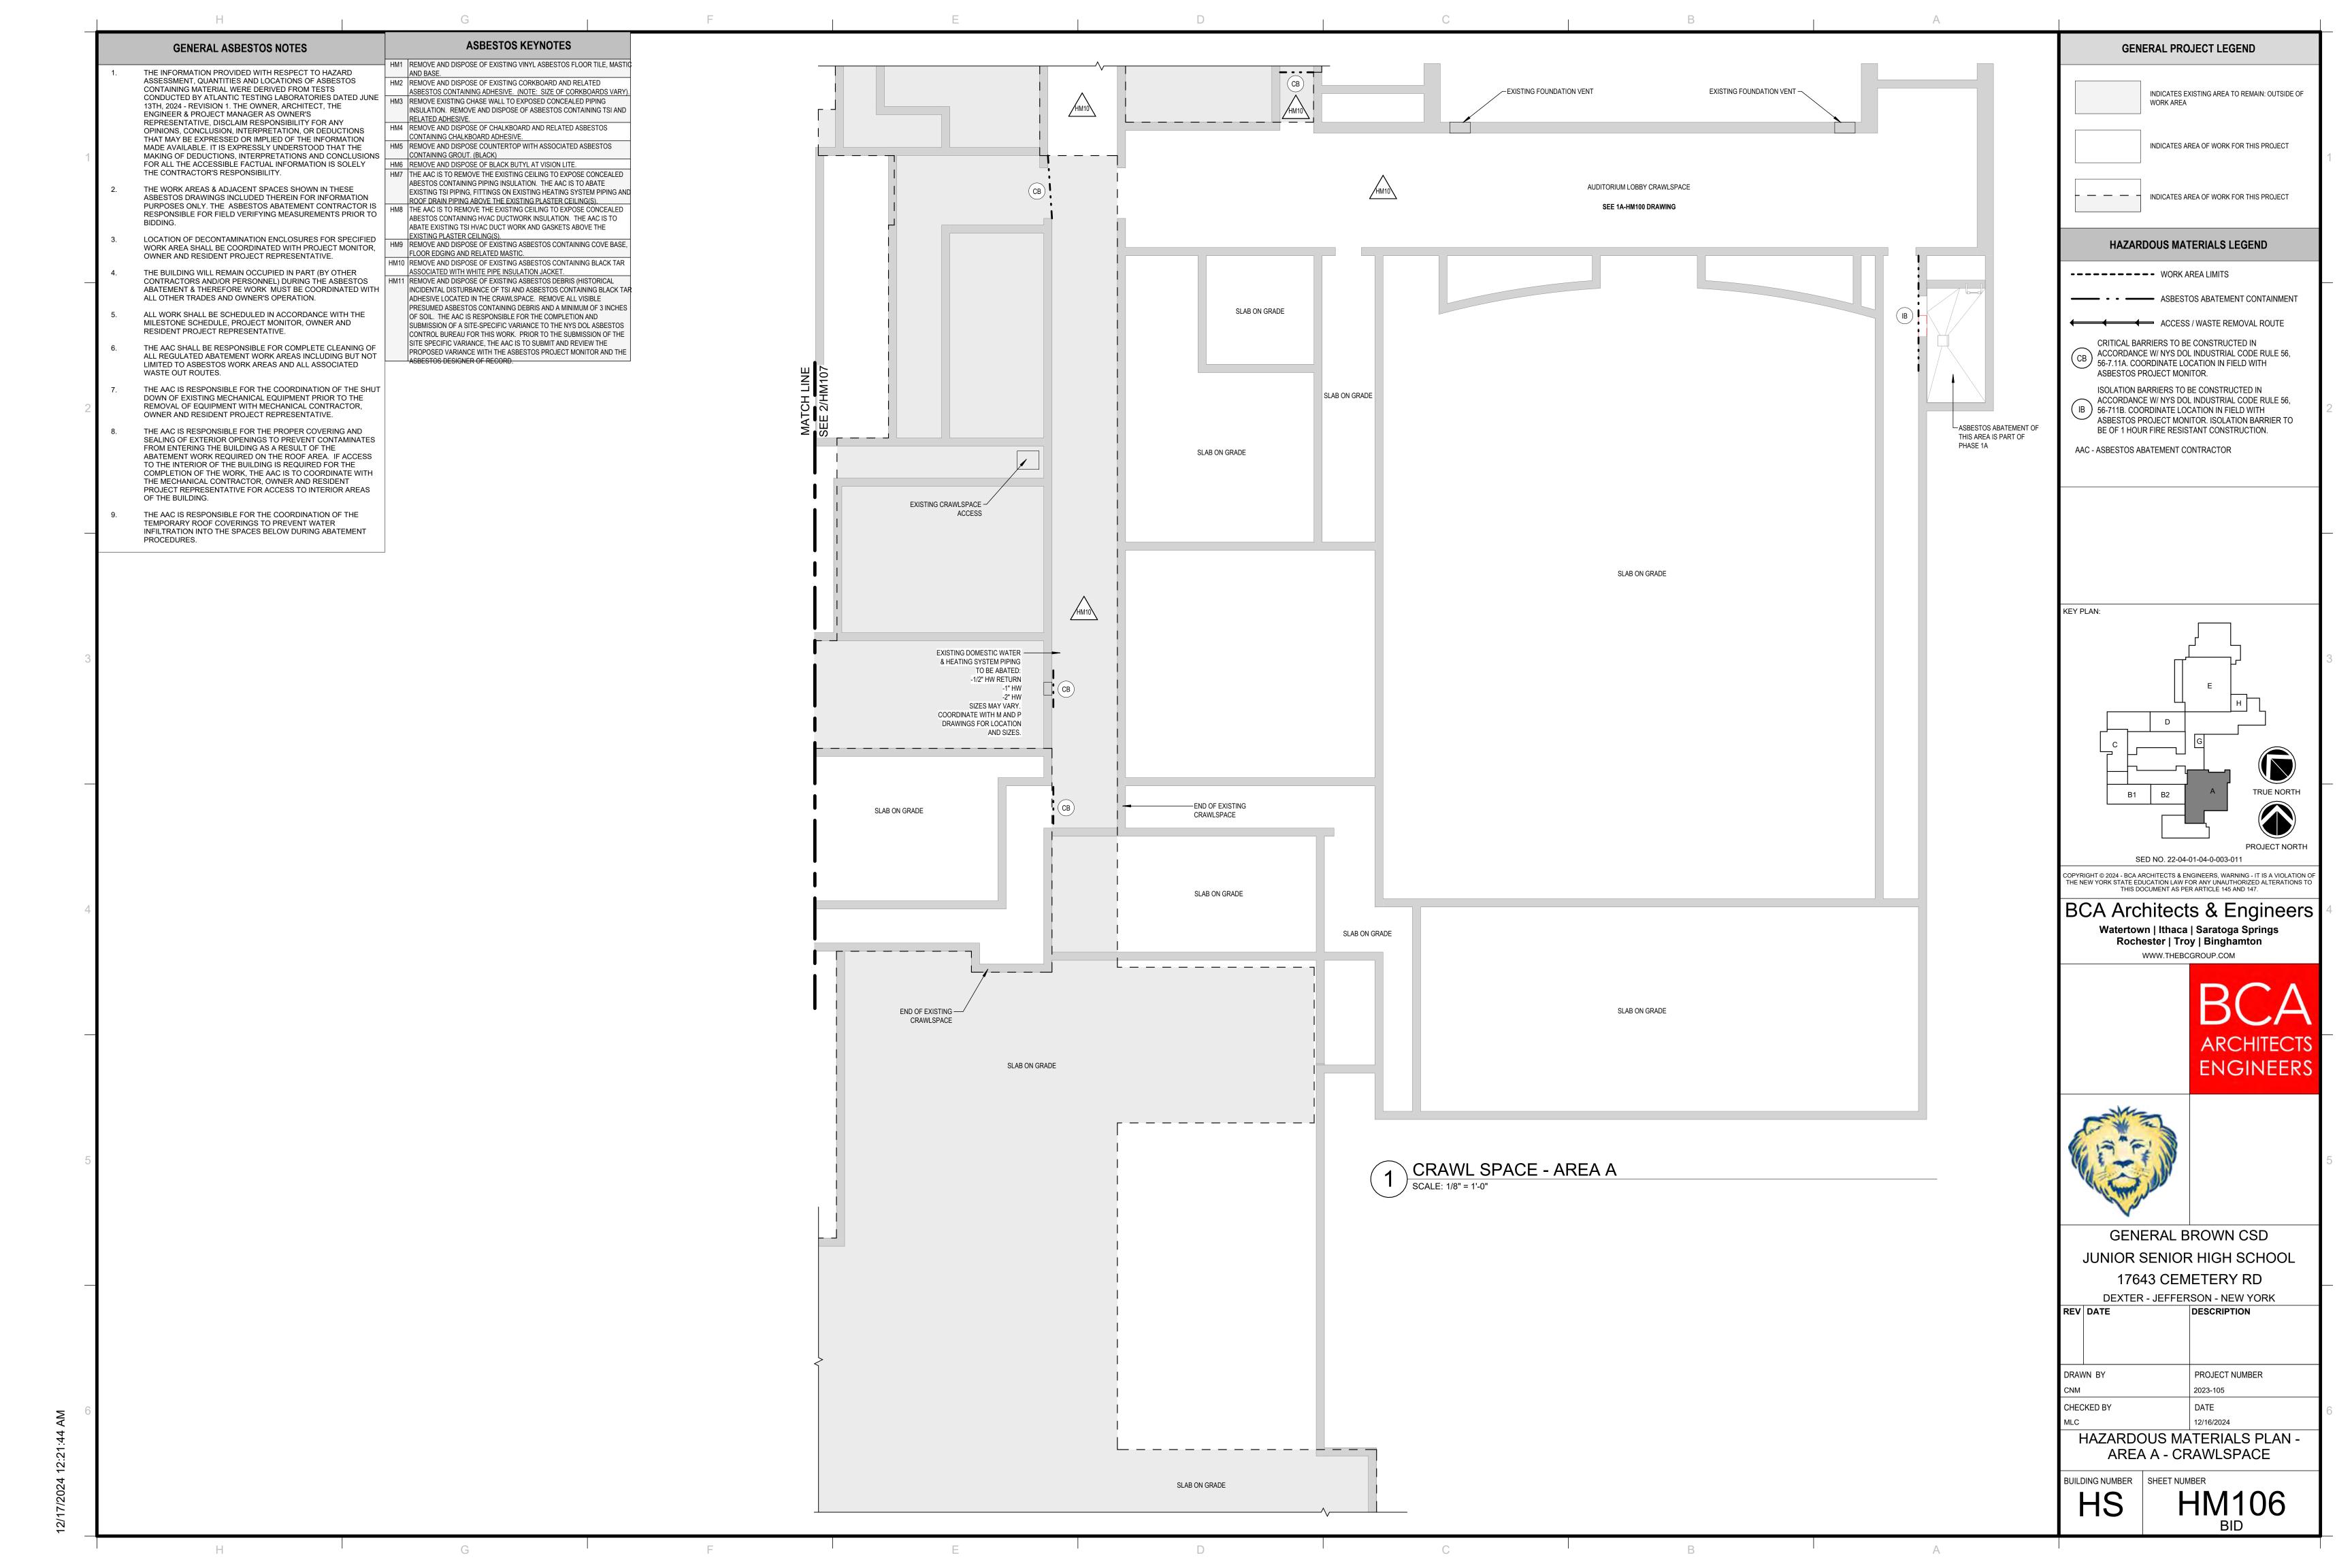

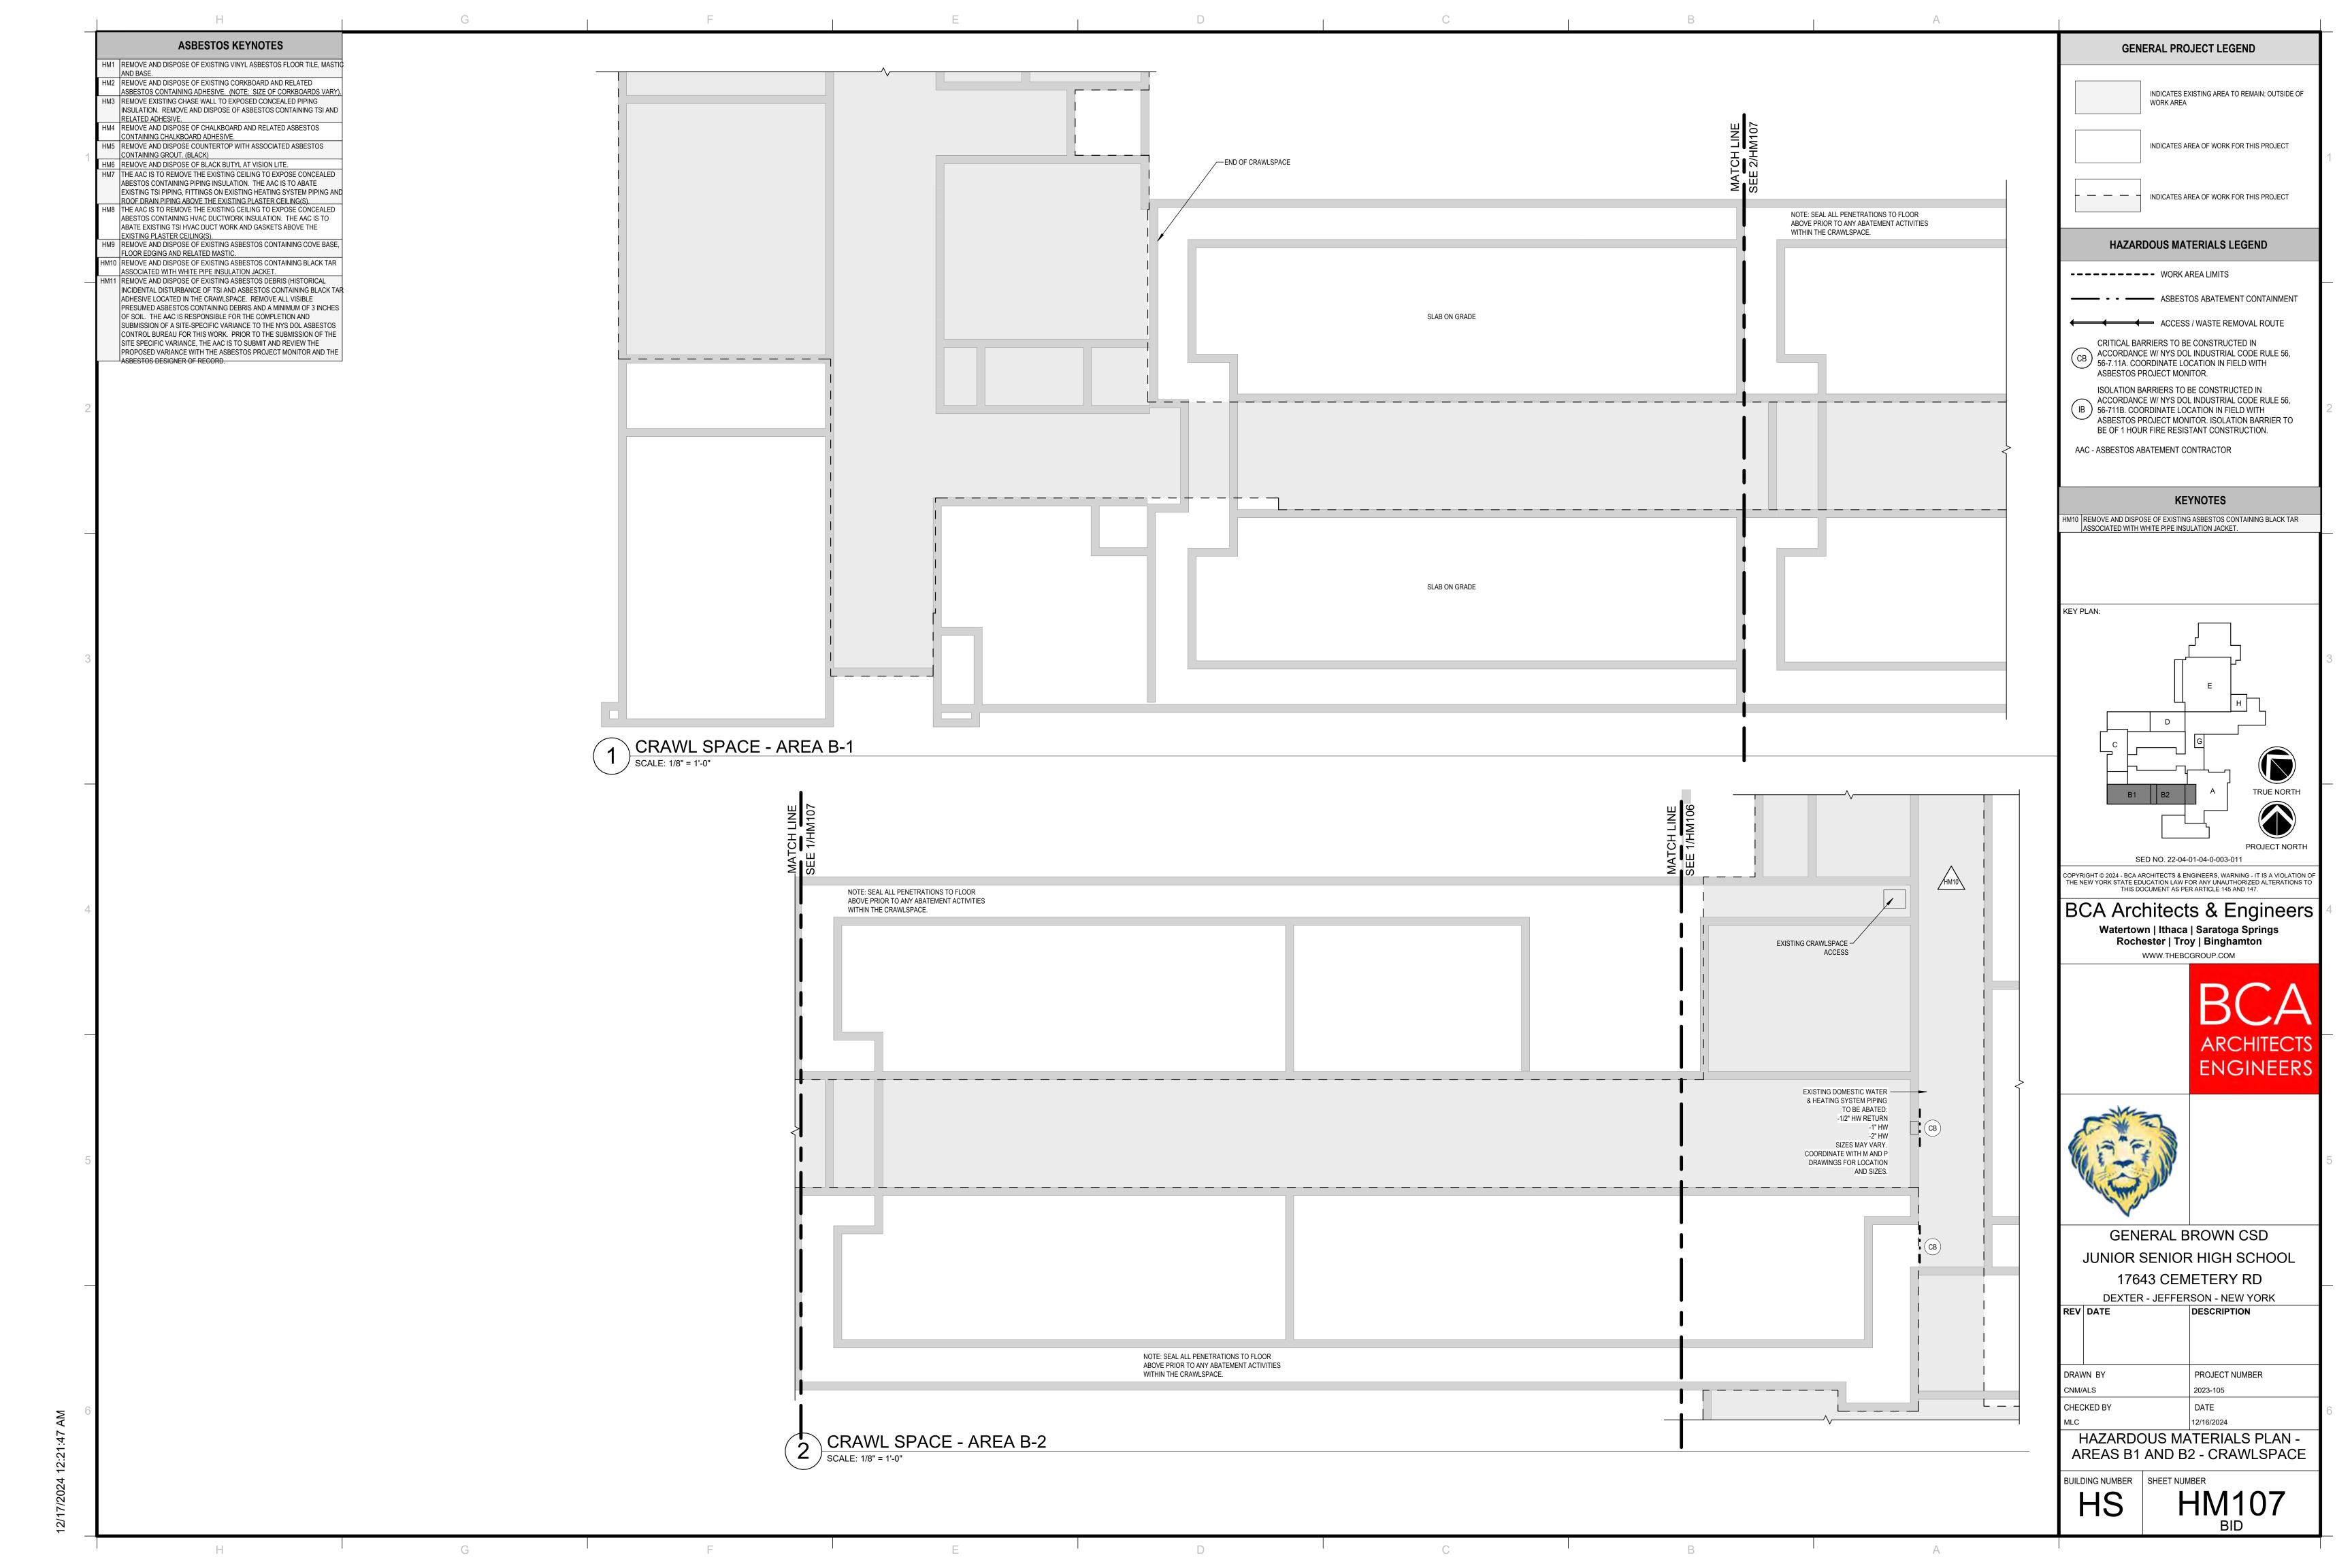

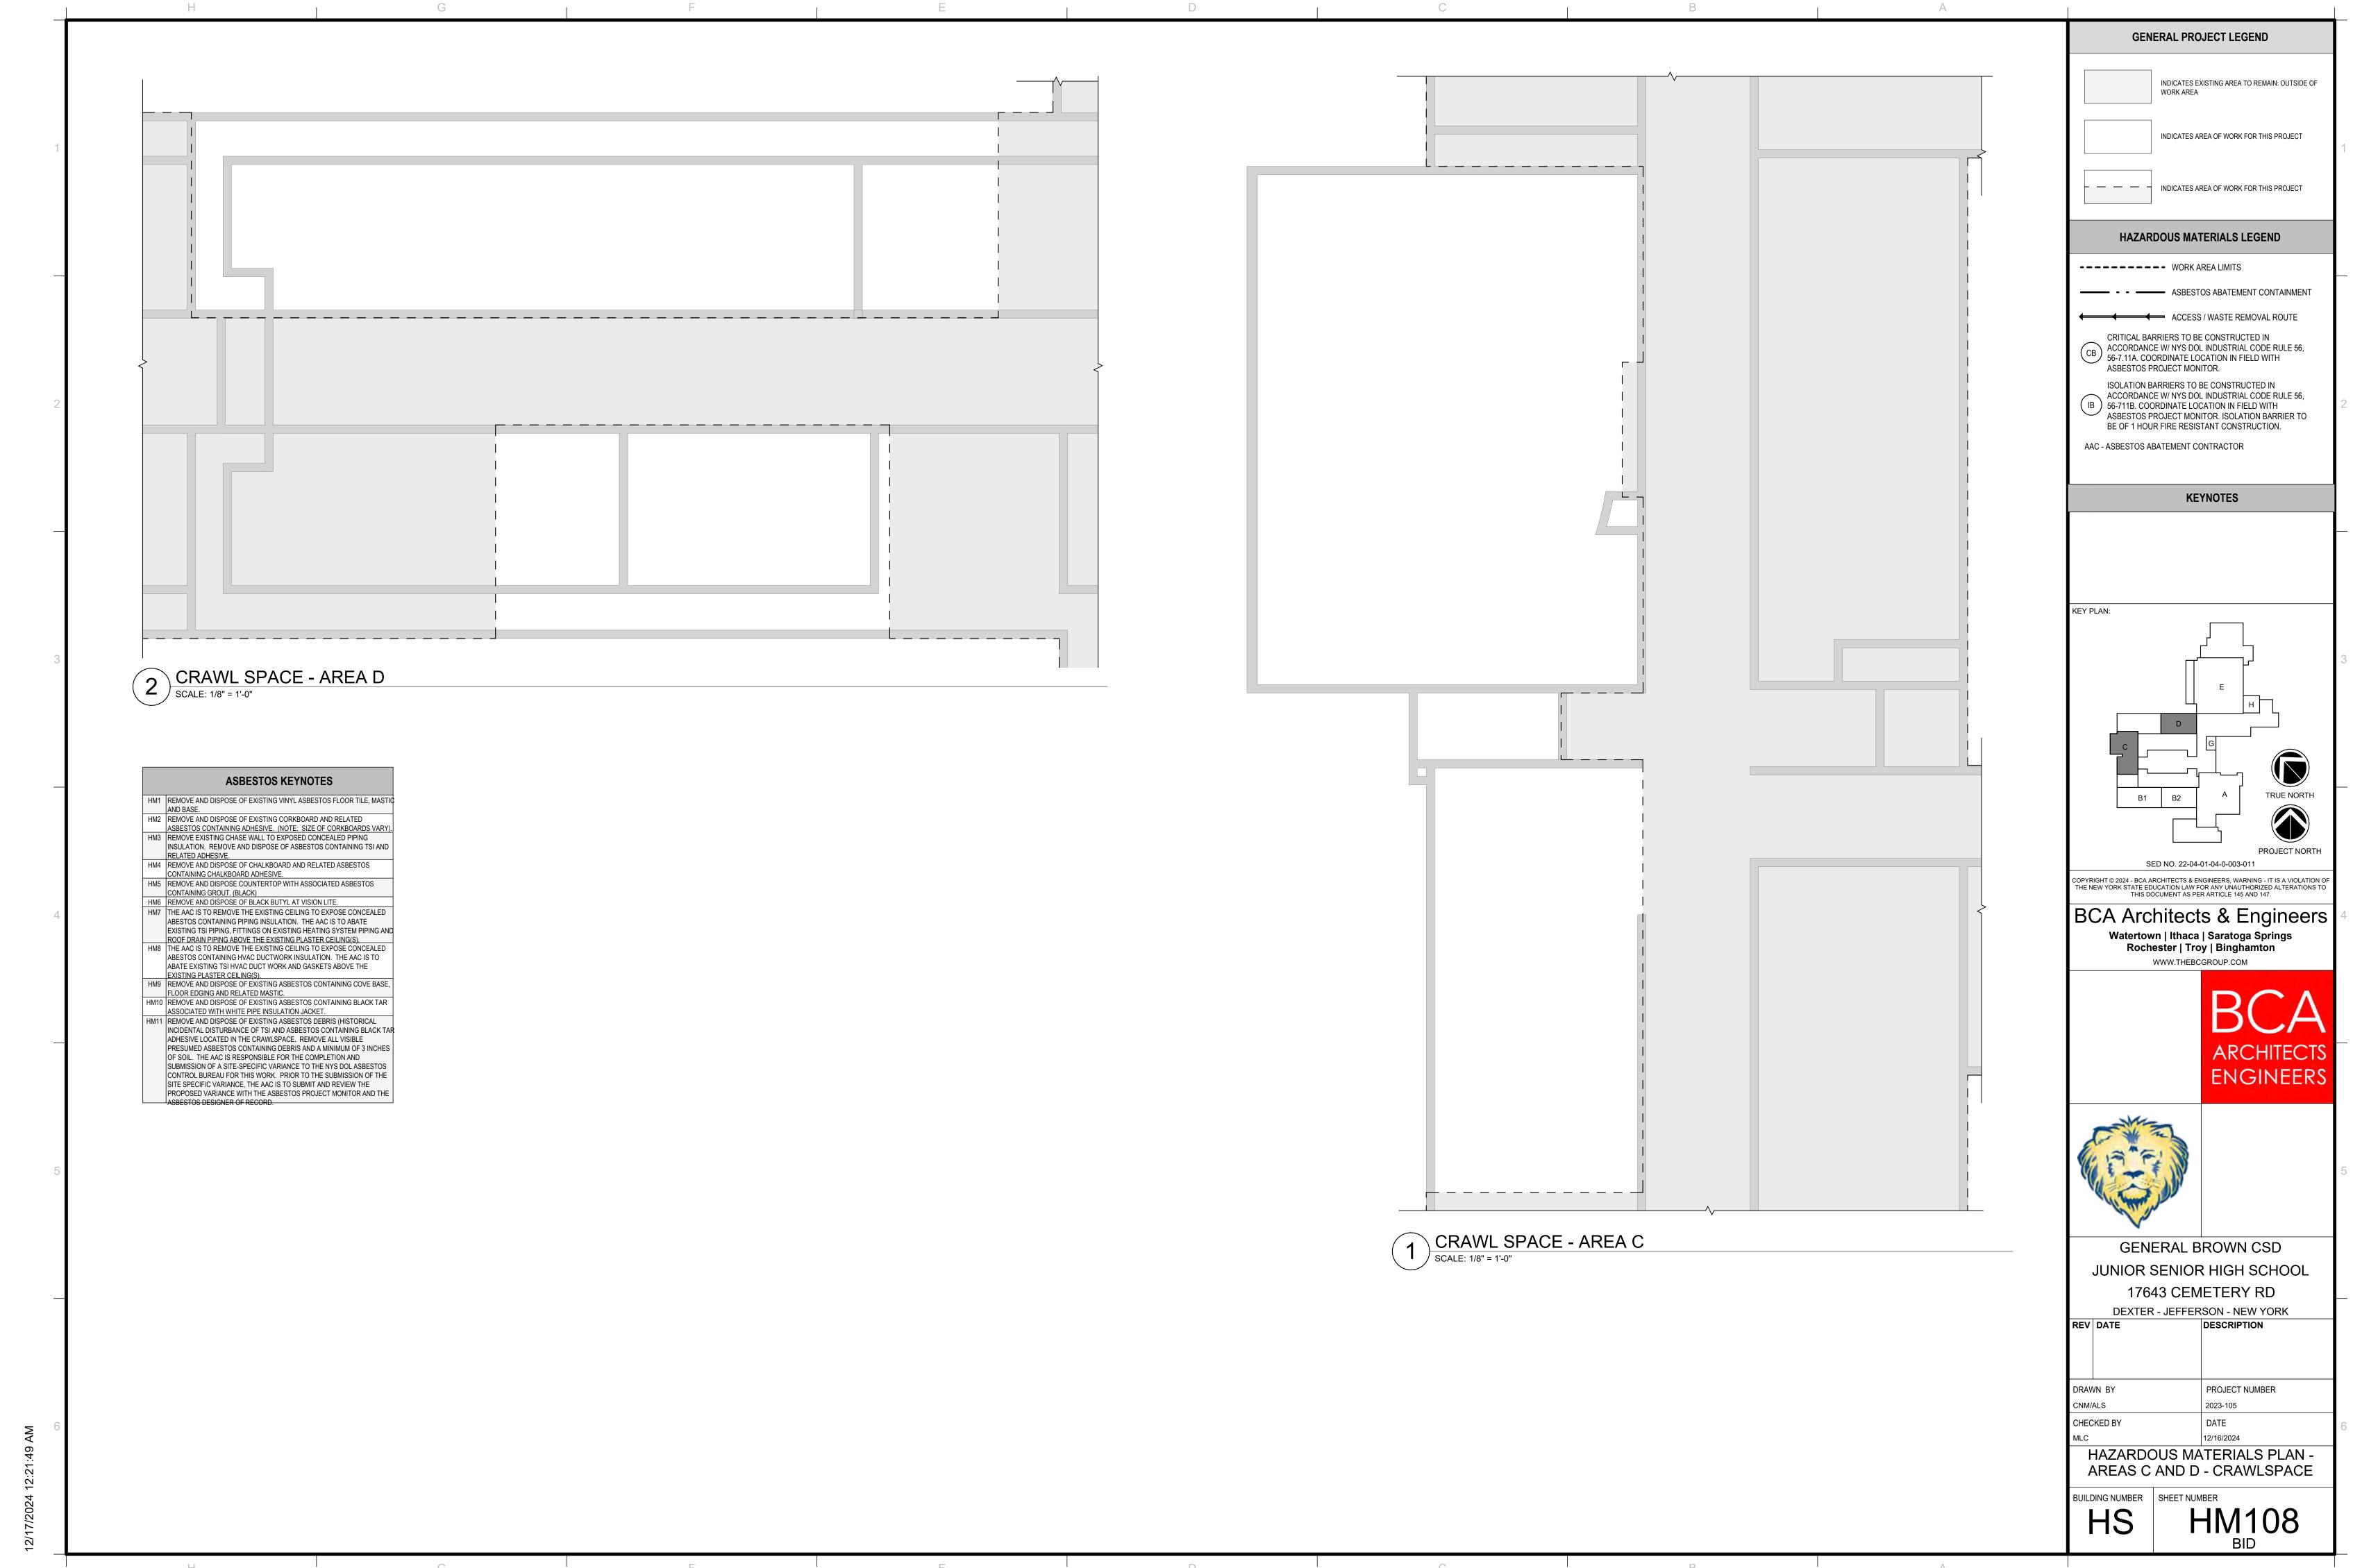

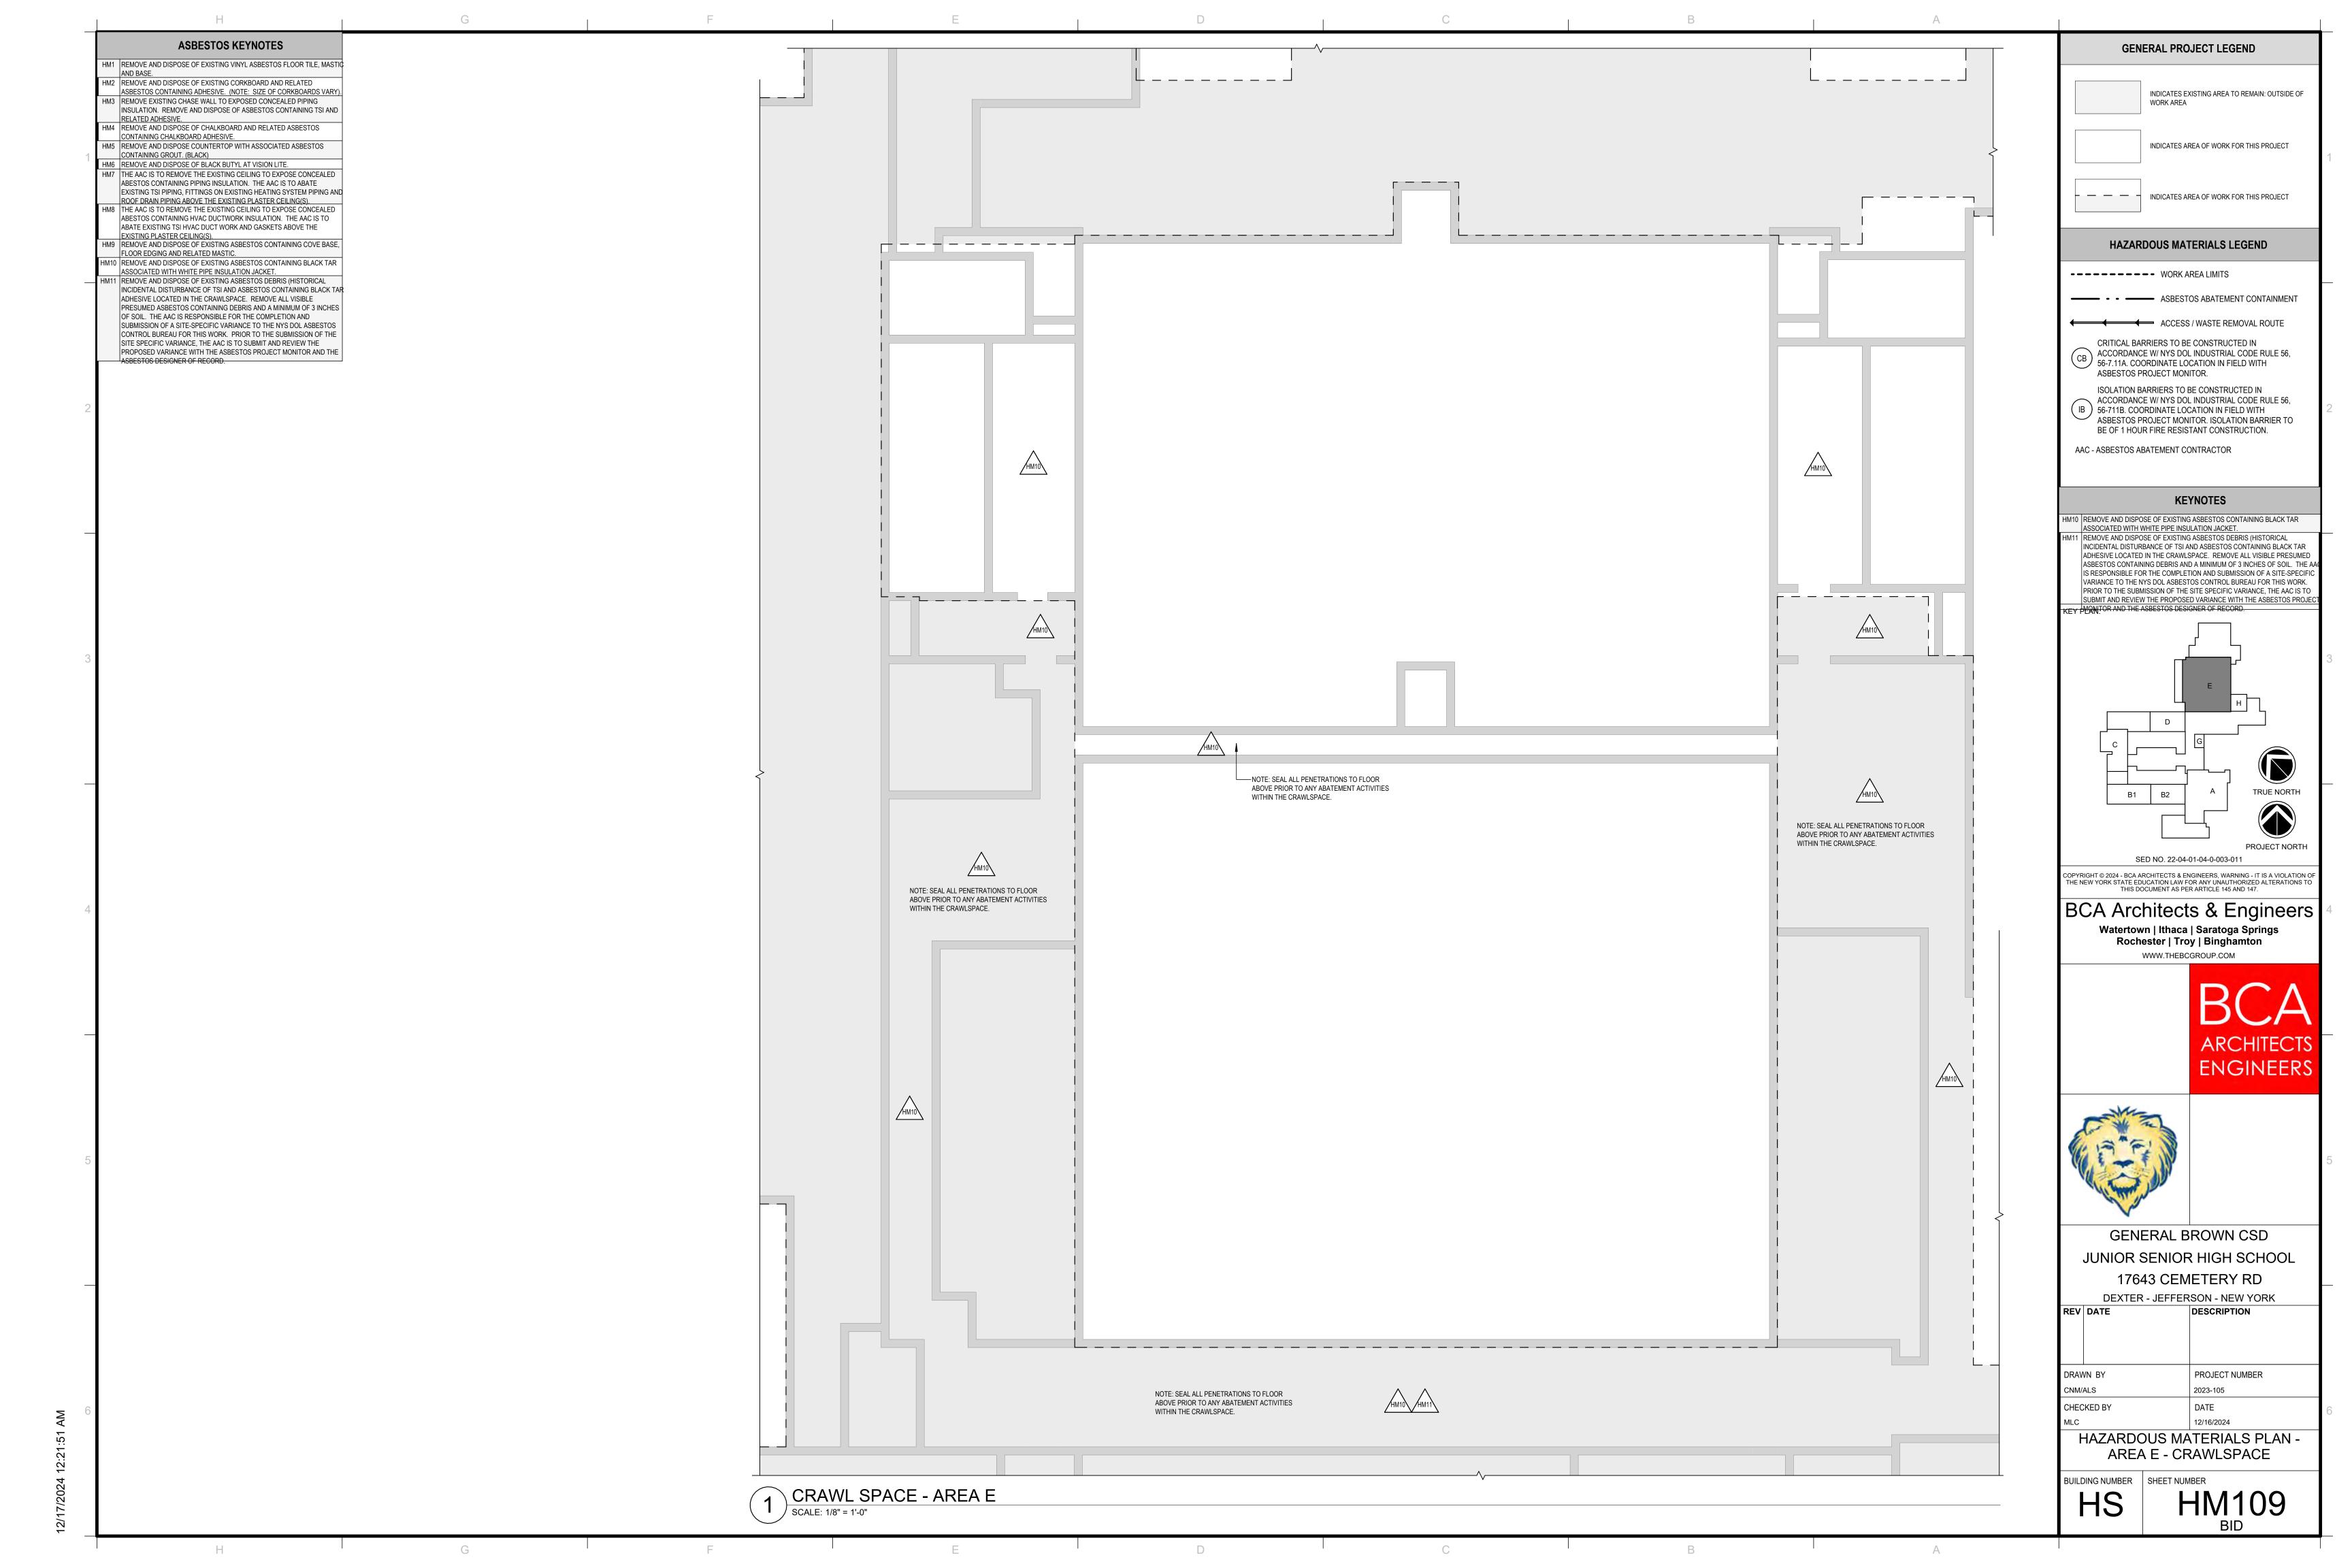

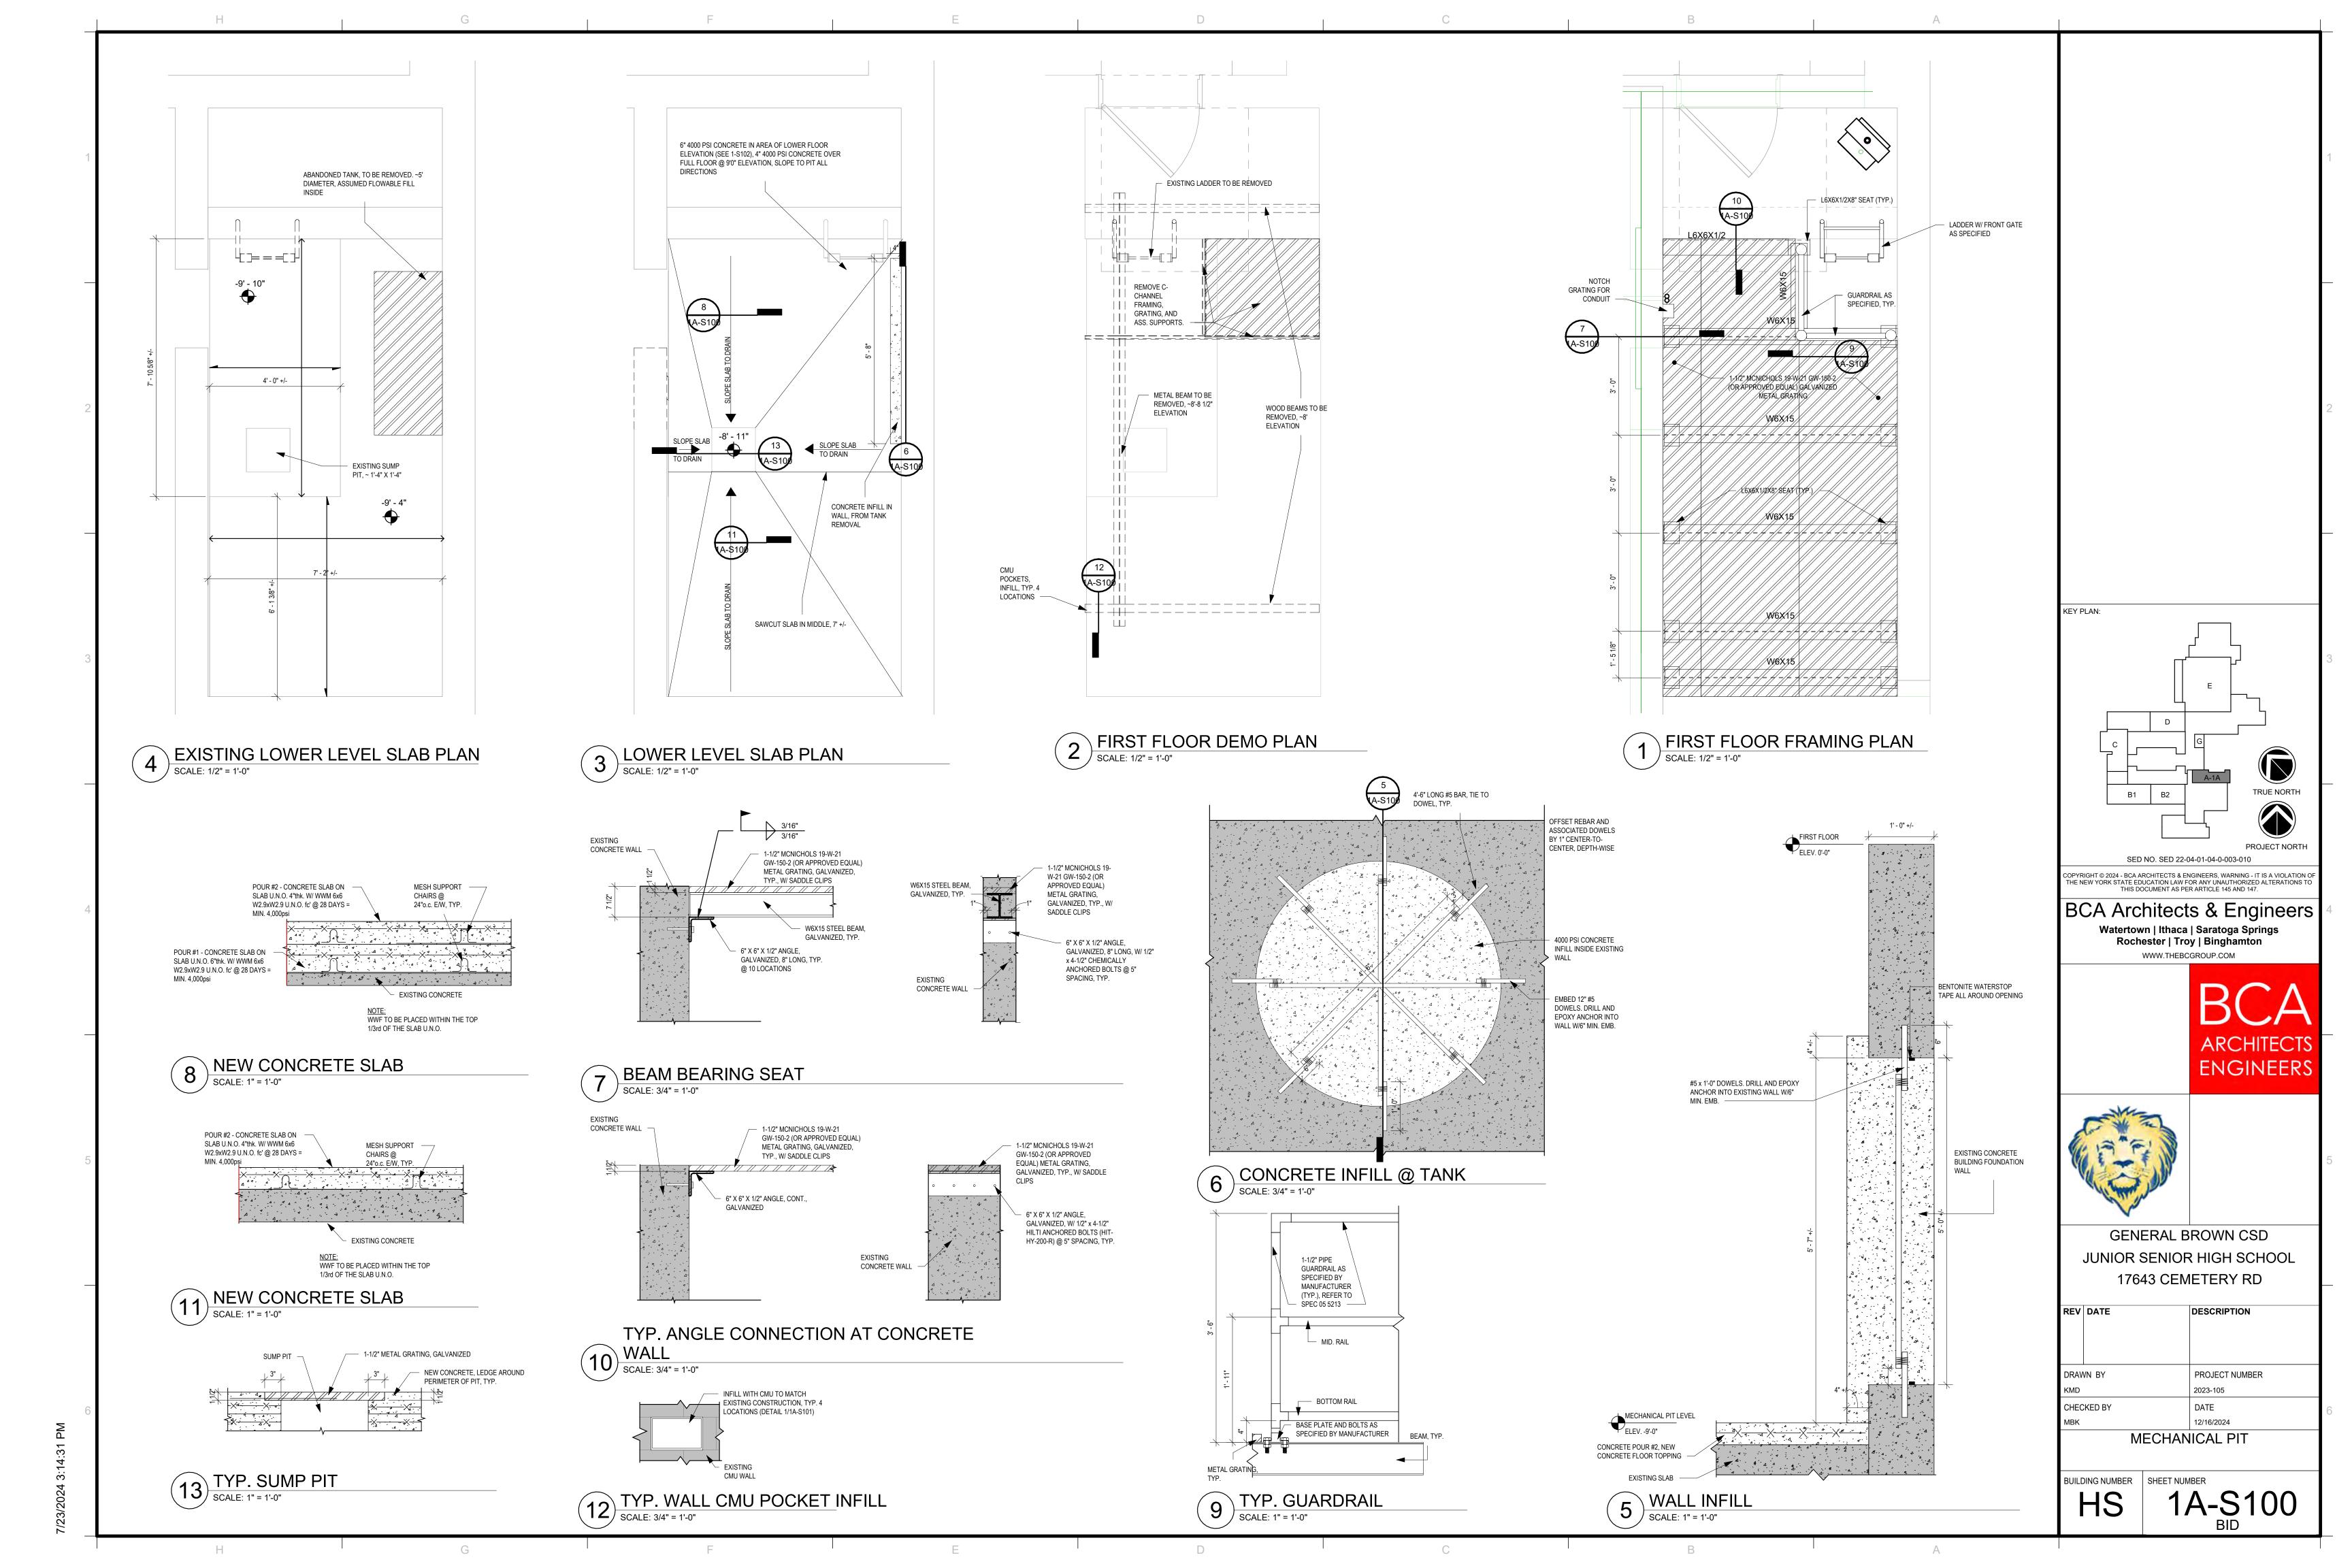


- EXISTING WALLS TO BE PAINTED 1 MASONRY INFILL
SCALE: NOT TO SCALE KEY PLAN: TRUE NORTH PROJECT NORTH SED NO. SED 22-04-01-04-0-003-010 COPYRIGHT © 2024 - BCA ARCHITECTS & ENGINEERS, WARNING - IT IS A VIOLATION OF THE NEW YORK STATE EDUCATION LAW FOR ANY UNAUTHORIZED ALTERATIONS TO THIS DOCUMENT AS PER ARTICLE 145 AND 147. BCA Architects & Engineers Watertown | Ithaca | Saratoga Springs Rochester | Troy | Binghamton WWW.THEBCGROUP.COM BCA ARCHITECTS ENGINEERS GENERAL BROWN CSD JUNIOR SENIOR HIGH SCHOOL 17643 CEMETERY RD REV DATE DESCRIPTION PROJECT NUMBER DRAWN BY 2023-105 CHECKED BY DATE 09/16/2024 MECHANICAL PIT BUILDING NUMBER SHEET NUMBER 1A-S101

MG 20.44.0 2000/00

Structural Design Criteria: 1.1 Building Code: 2020 Building Code of New York State 1.2 2020 Existing Building Code of New York State1.3 ASCE7-16 1.4 Occupancy Category: III 1.5 Design Basis: Allowable Stress Design 2. <u>Floor Live Loads:</u> Classrooms 40psf 3. <u>Snow Loads:</u> 3.1 Ground Snow Load3.2 Flat Roof Snow Load Pg: 60psf Pf: 46psf 3.3 Snow Exposure Factor: Ce: 1.00 3.4 Snow Importance Factor Is: 1.10 3.5 Thermal Factor Ct: 1.00 4.1 Basic Wind Speed Vult=115mph, Vasd=89mph 4.2 Wind Exposure B 4.3 Internal Pressure Coeff +/- 0.18 Enclosed Structure 5. <u>Earthquake Design Data:</u> 5.1 Seismic Importance Factor le: 1.25 5.2 Seismic Importance Factor lp: 1.00 (Mechanical) 5.3 Site Class D (Default) 5.4 Mapped Spectral Response: 5.4.1 Short Term S1: 0.060g 5.4.2 1 Sec 5.5 Design Spectral Response: 5.5.1 Short Term 5.5.2 1 Sec SD1: 0.096g 5.6 Response Modification Factor: Rp: 6 (Mechanical Roof Top Equipment)
 5.7 Horizontal Equipment Force: As calculated per ASCE7 13.3-1. 5.8 Seismic Design Category: B 6. <u>Allowable Soil Bearing Pressure:</u> N/A


MASONRY OPENING PLAN

SCALE: 1/8" = 1'-0"

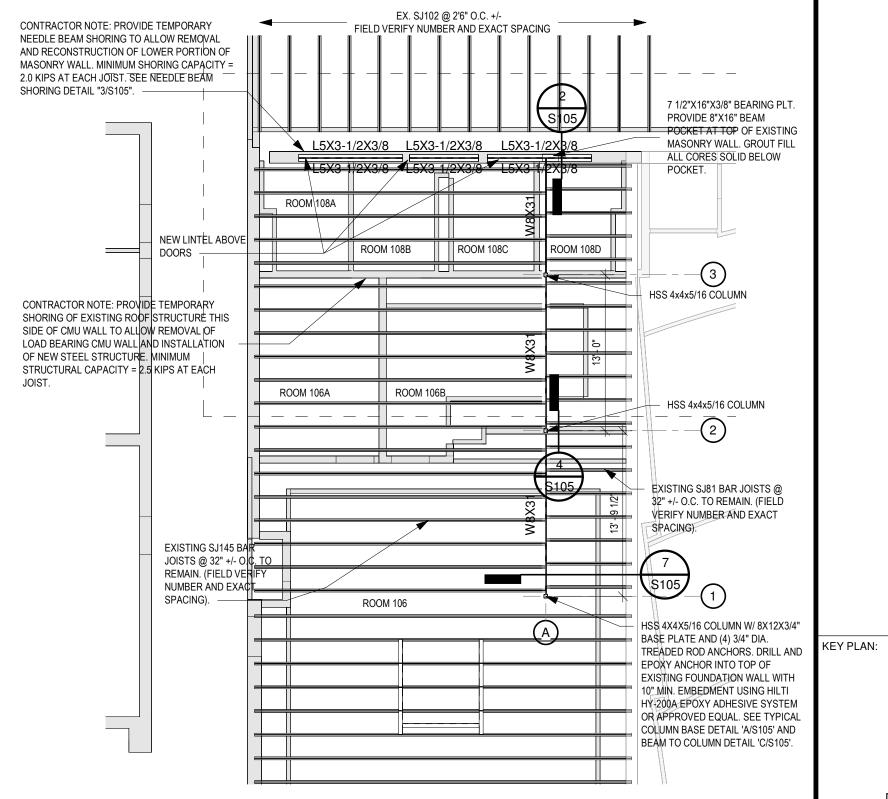

LOAD BEARING WALL REMOVAL PLAN -BAND ROOM

SCALE: 1/8" = 1'-0"

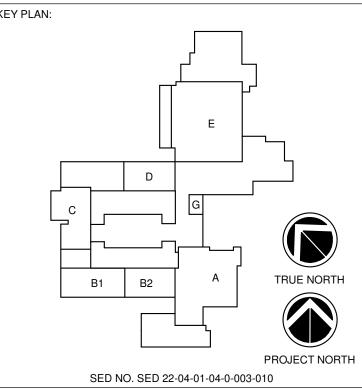

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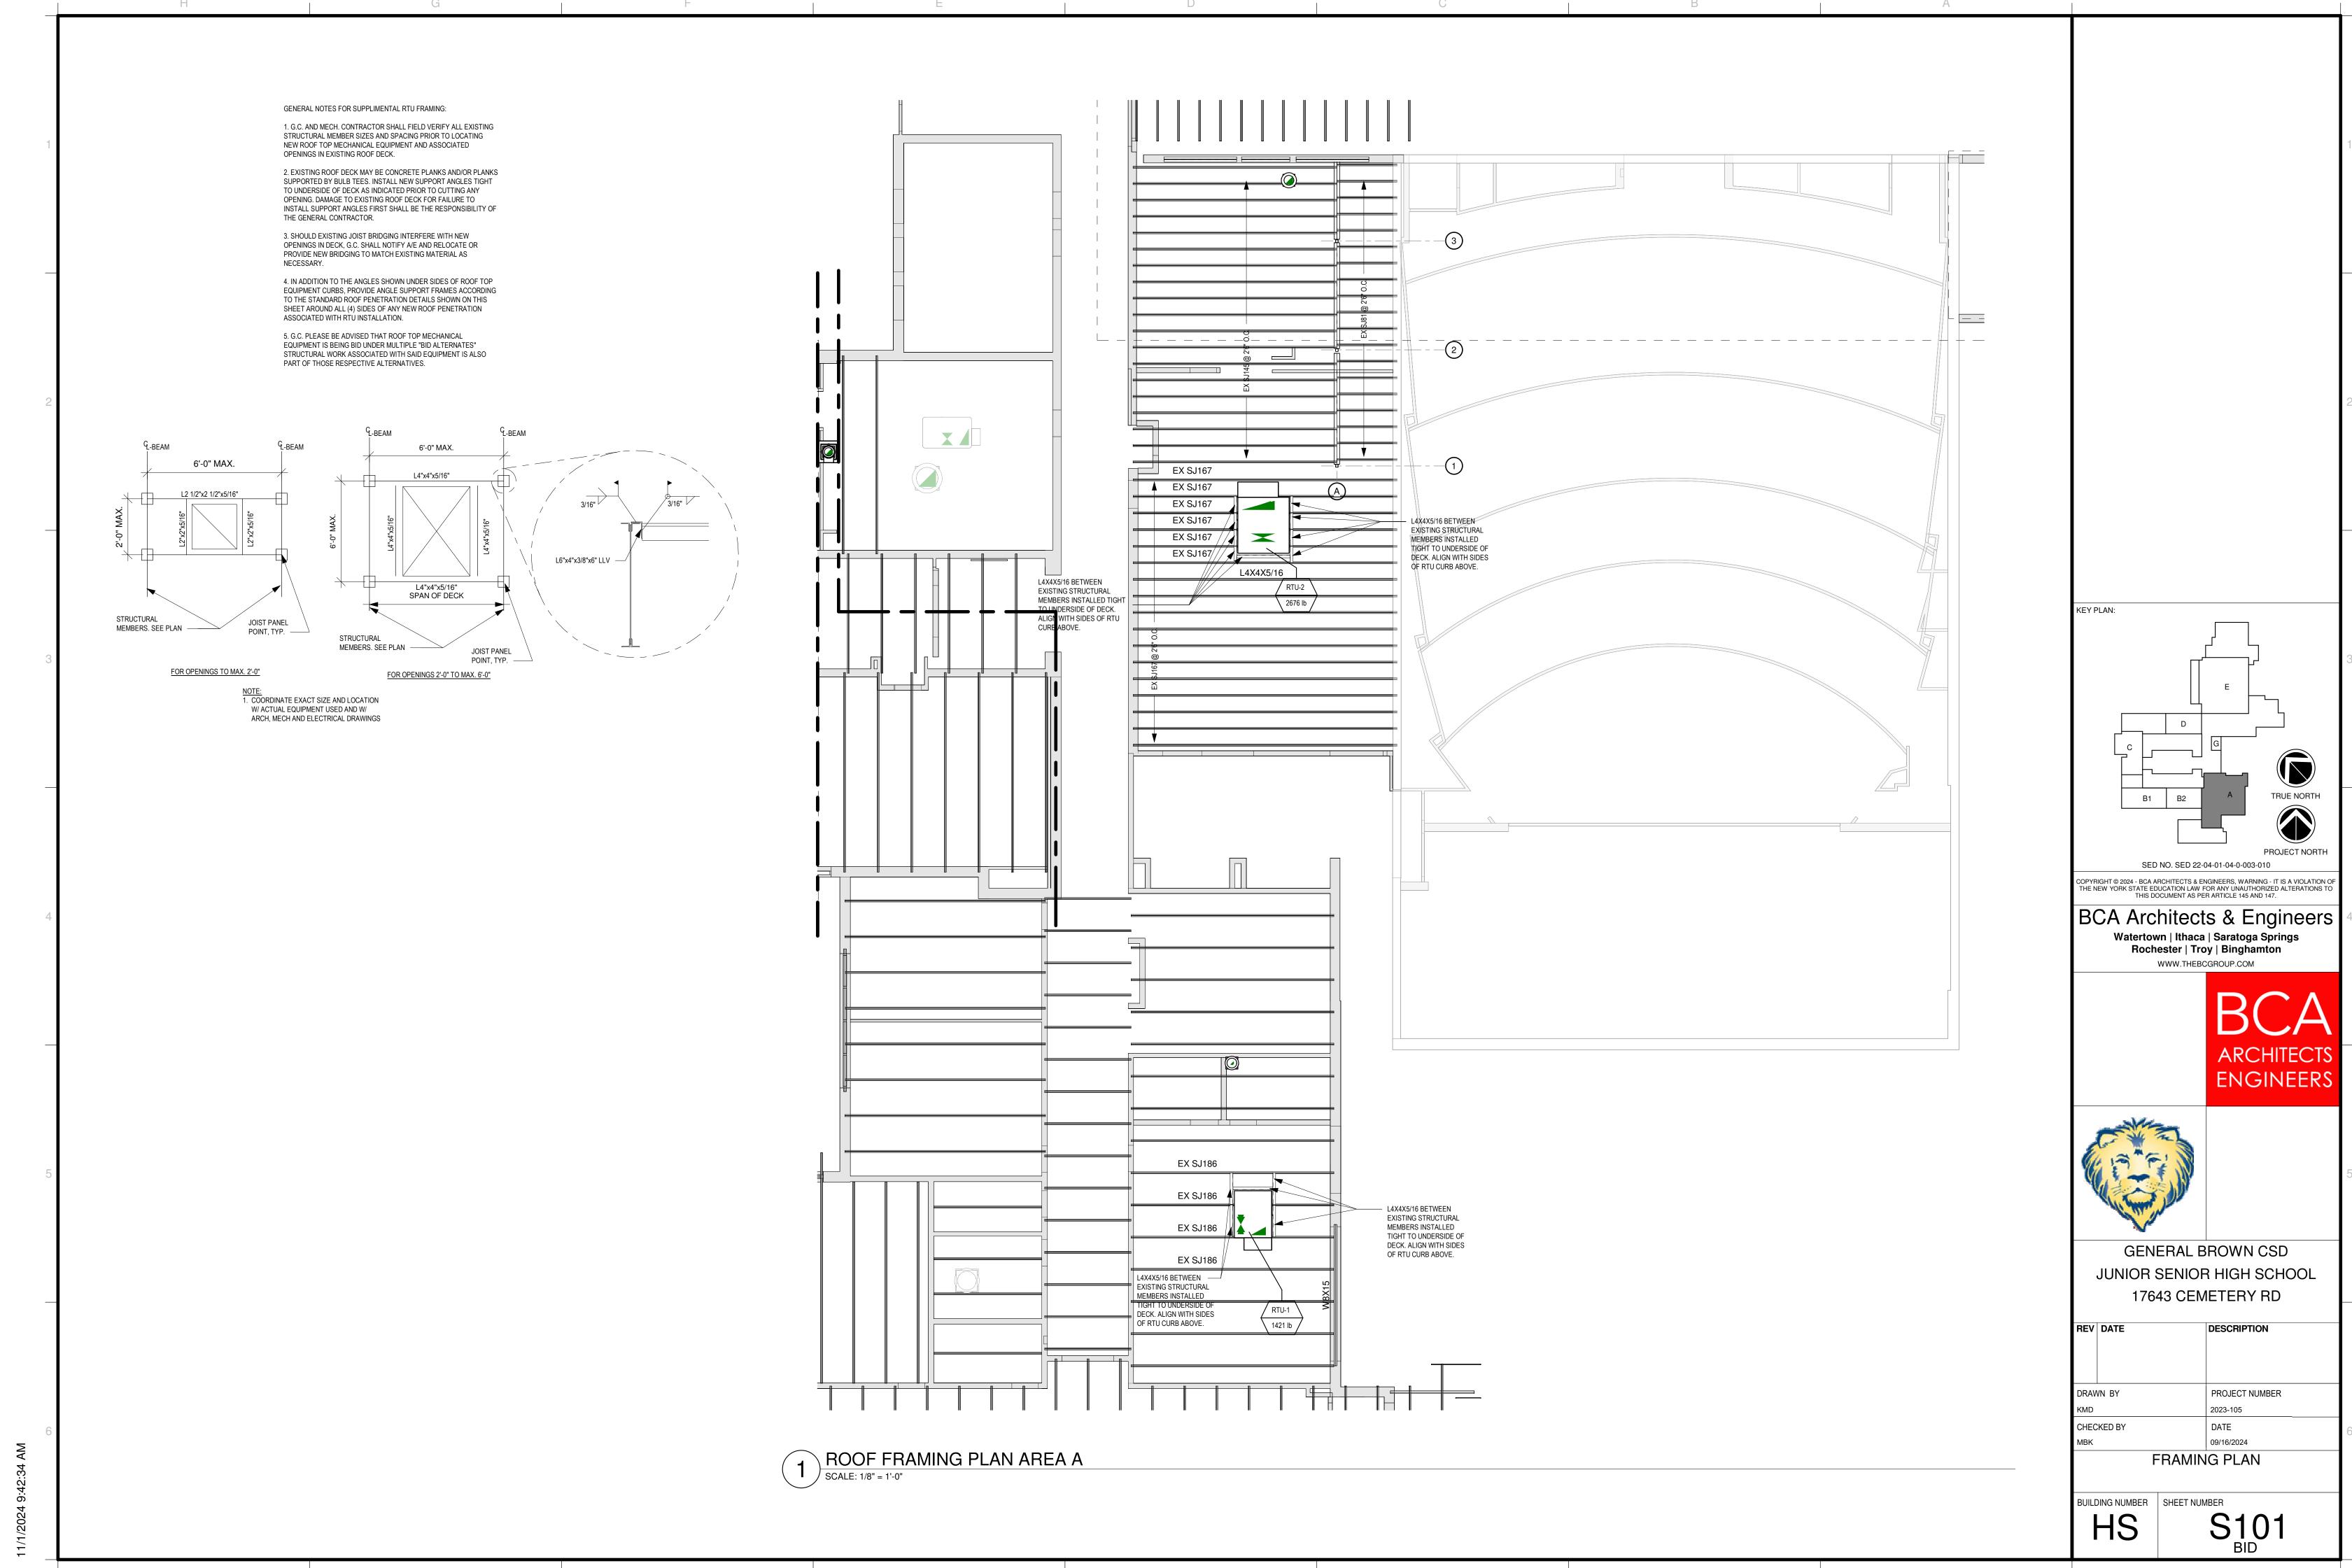



GENERAL BROWN CSD JUNIOR SENIOR HIGH SCHOOL


REV DATE	DESCRIPTION
PRAWN BY	PROJECT NUMBER
(MD	2023-105
CHECKED BY	DATE
<b>IBK</b>	09/16/2024
F	RAMING PLAN


17643 CEMETERY RD


BUILDING NUMBER SHEET NUMBER S<sub>100</sub>



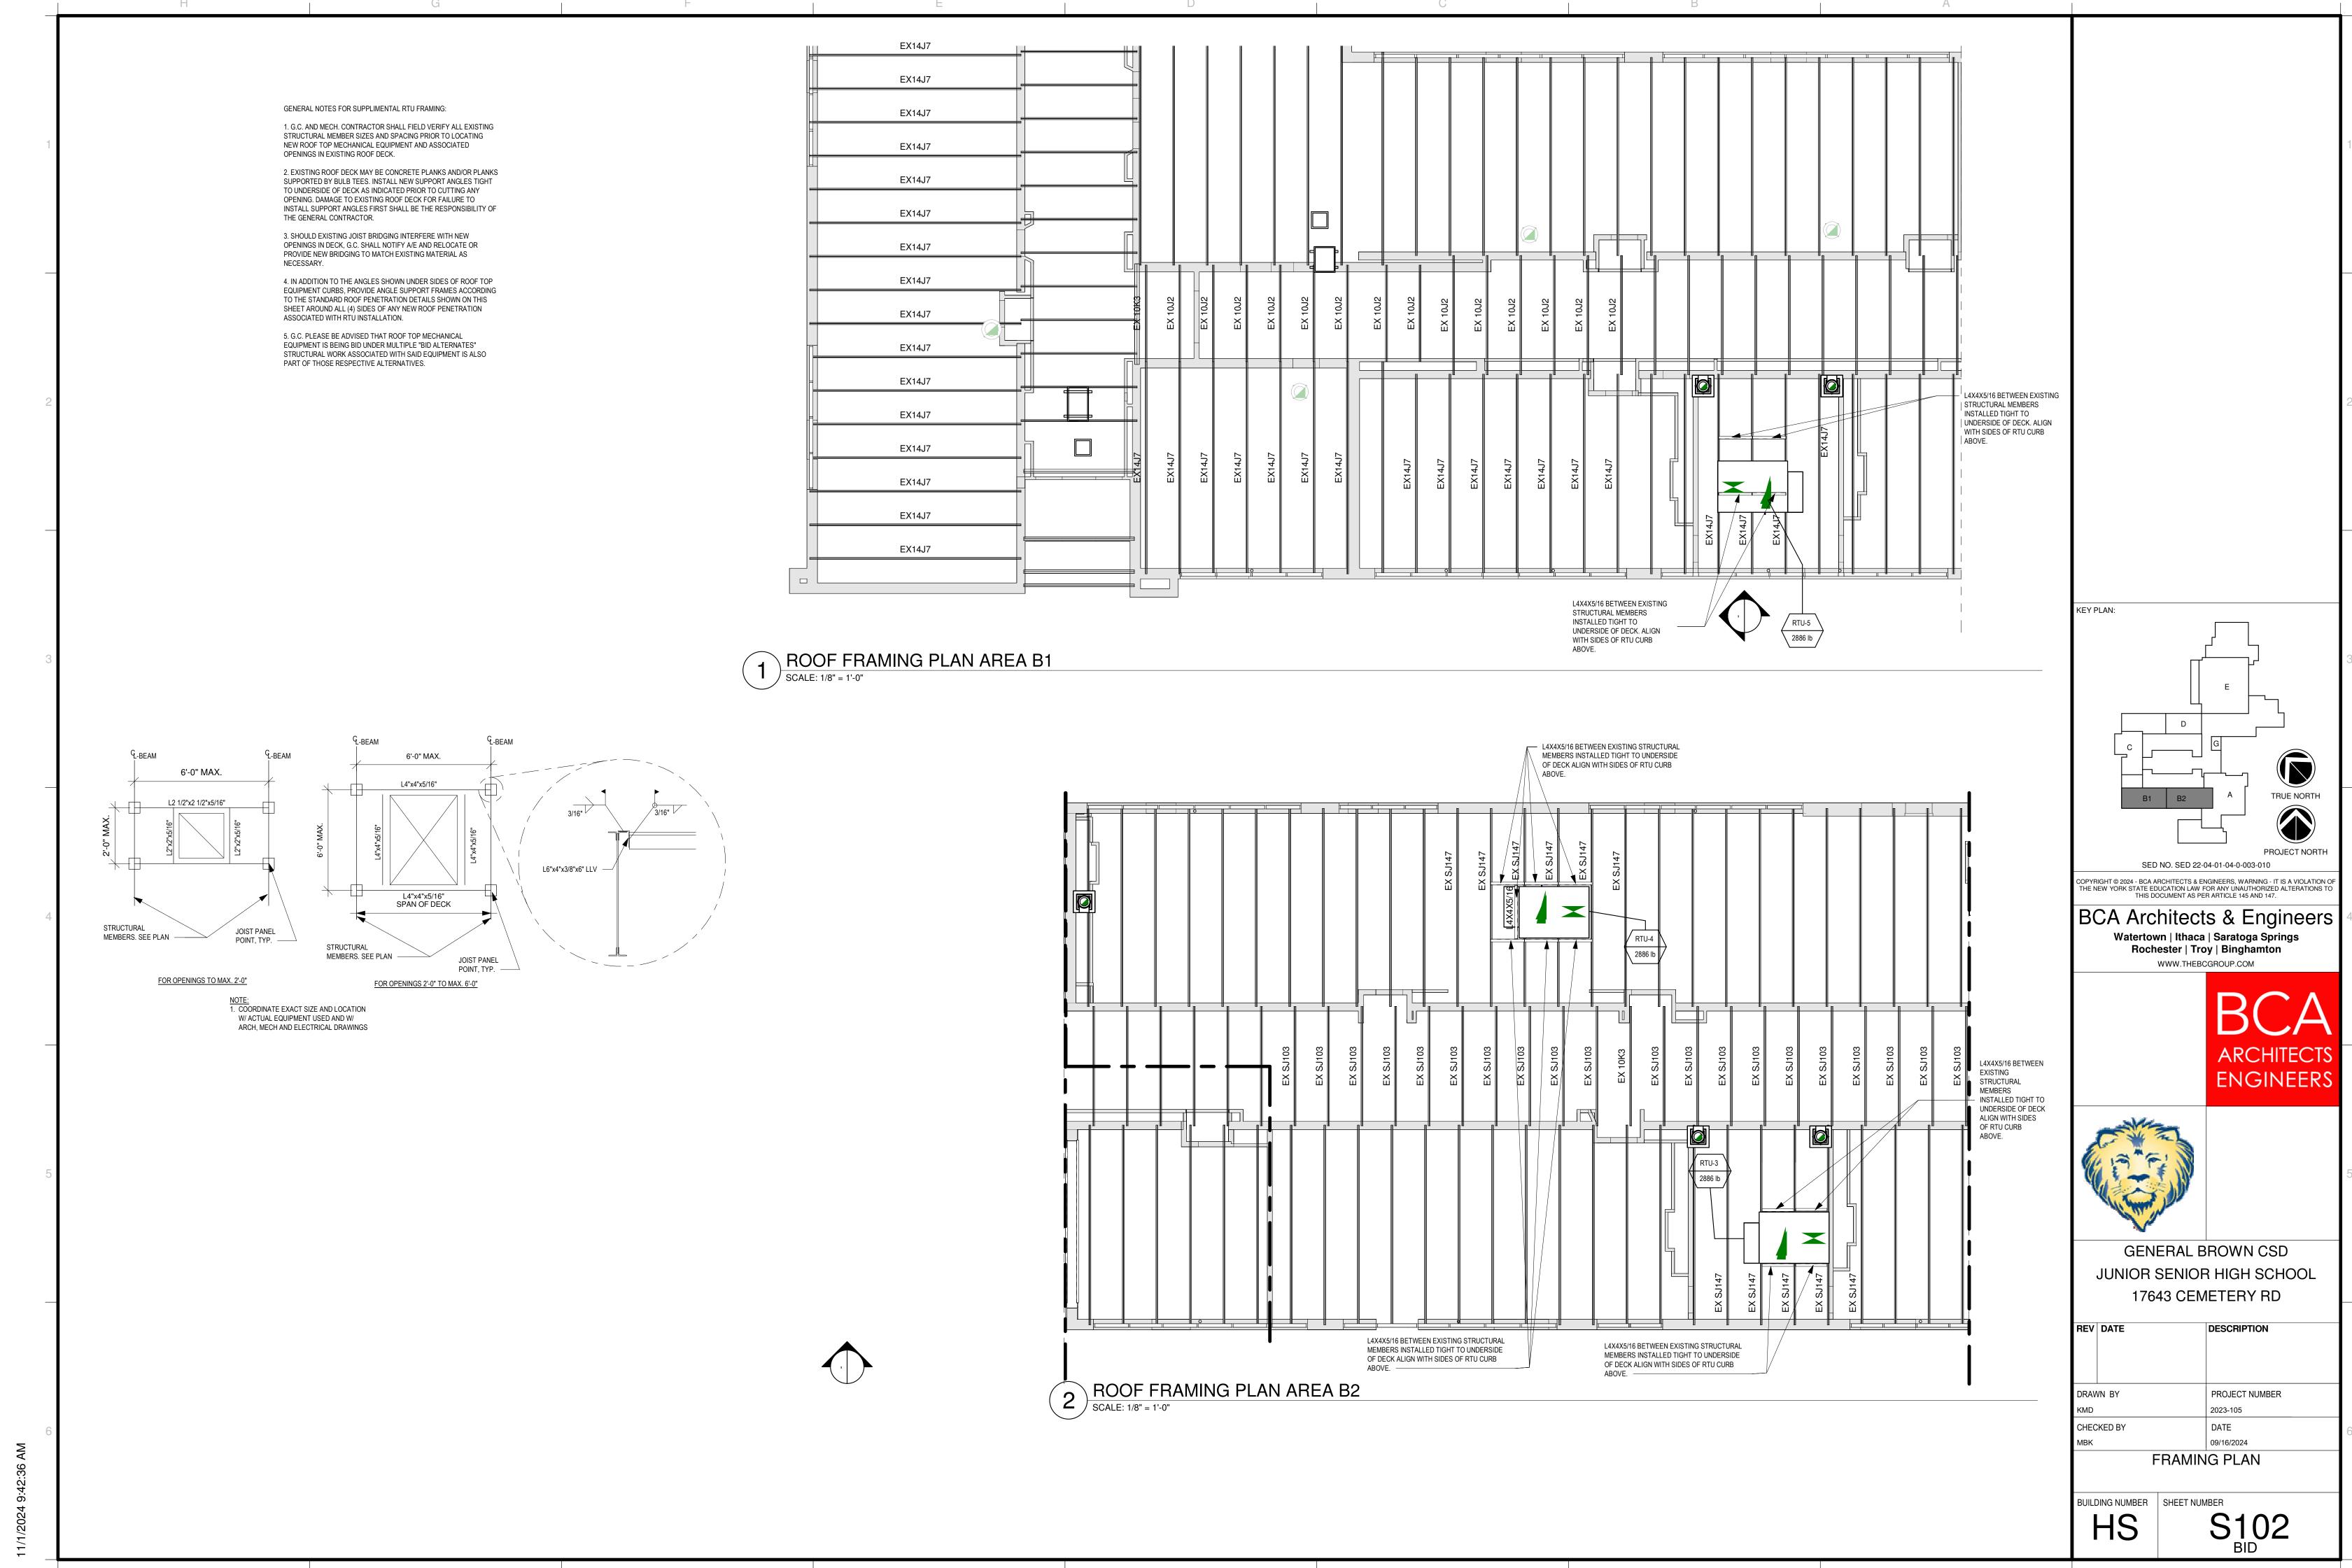


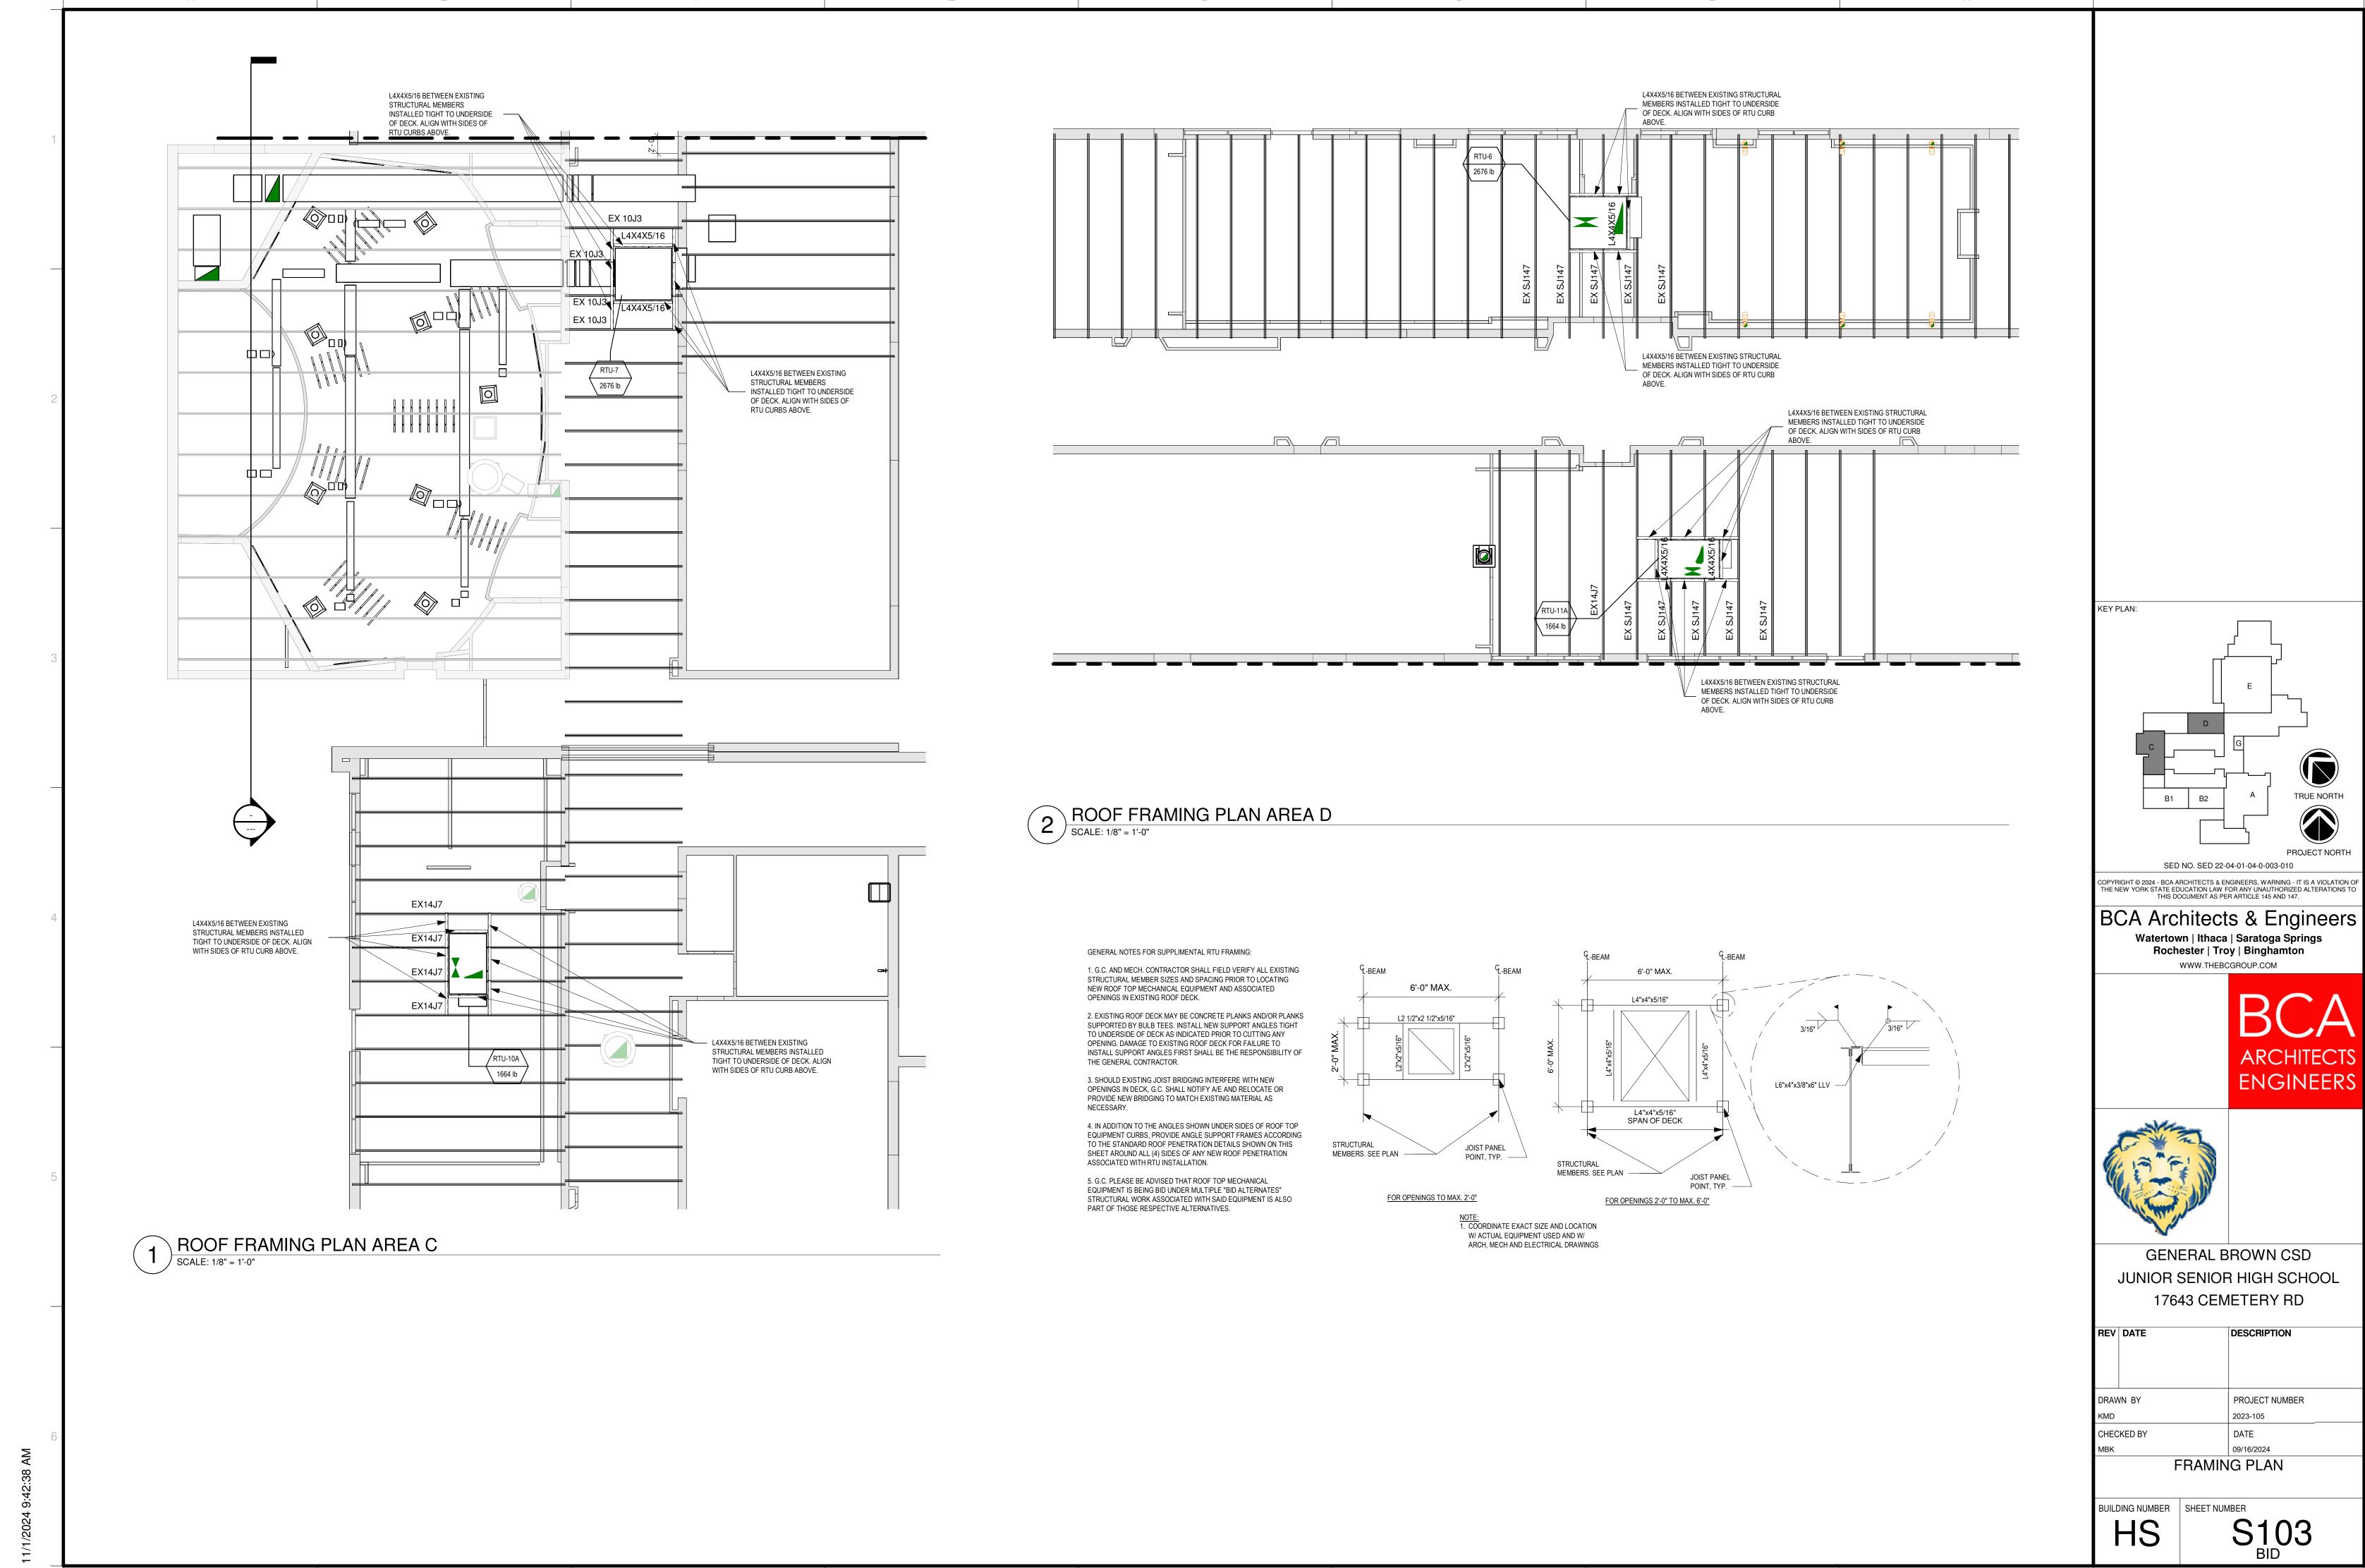


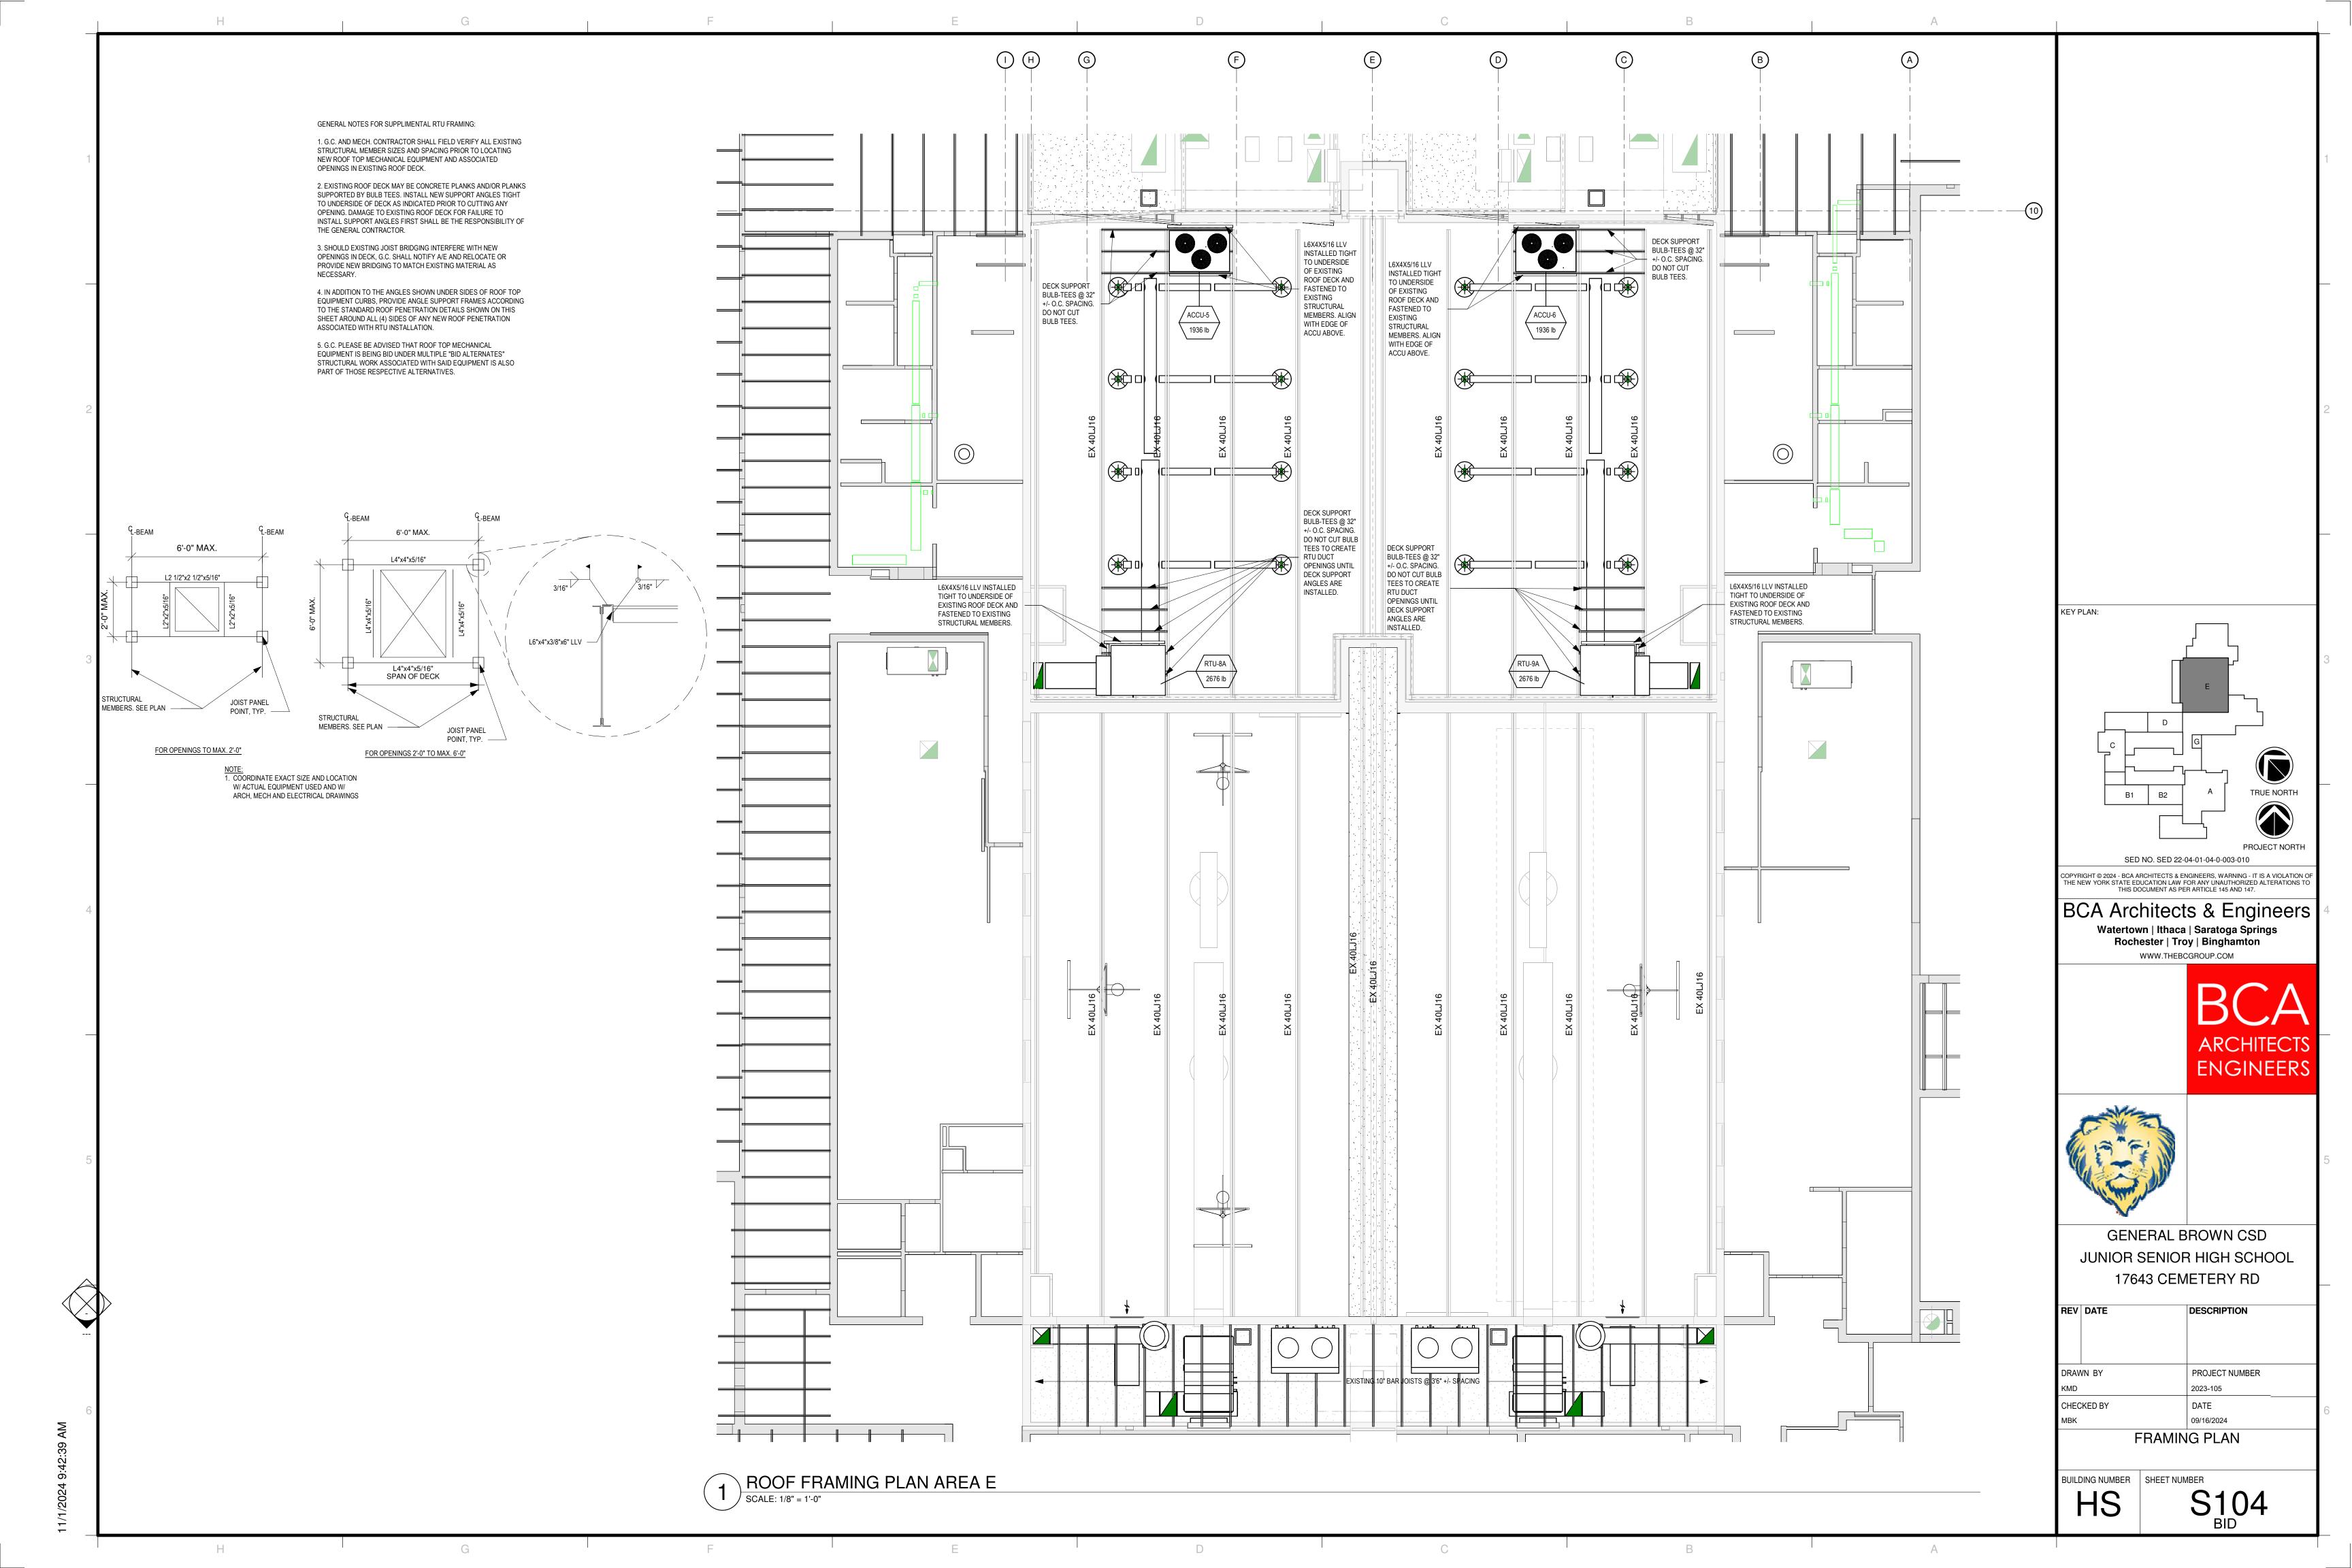


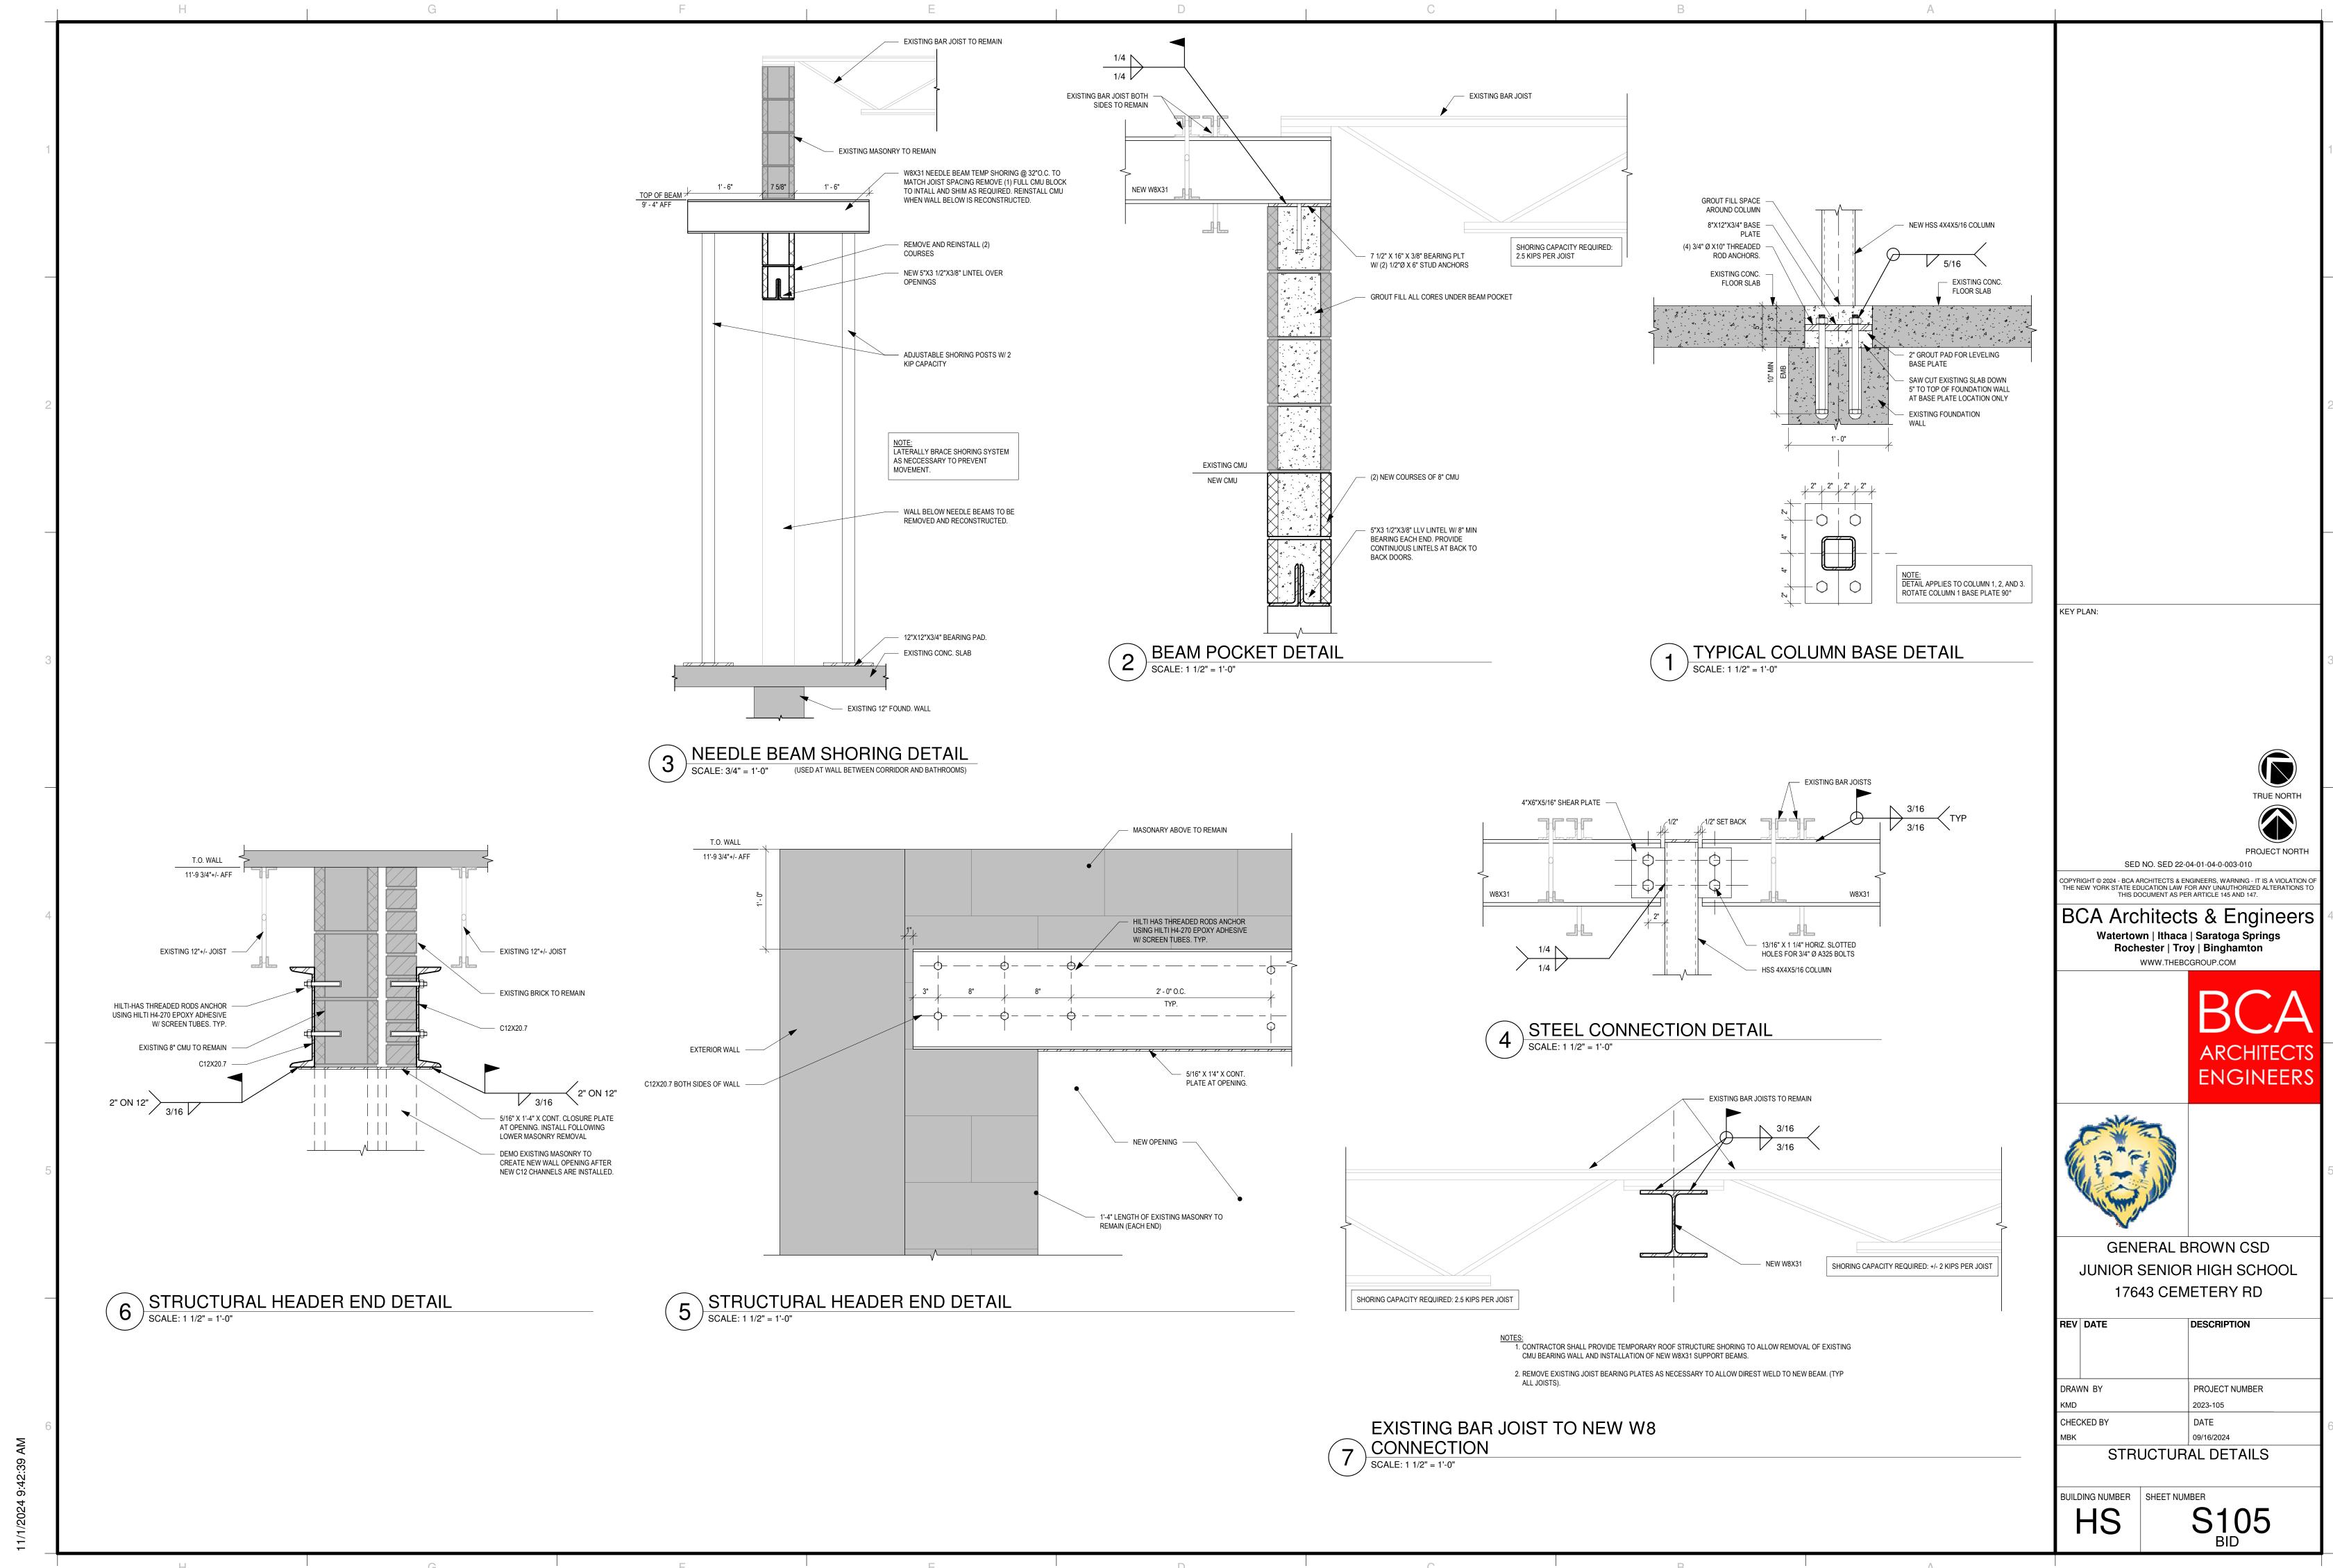



	H		F				Е	D	С	В	A	
									LIST OF ABBREVIATIONS	SYMBOLS LEGEND	GENERAL RENOVATION NOTES	
		MARK	THICK OVERALL	CMU SIZE	STC UL	FIRE RATING	ACOUSTICA INSULATION	DESCRIPTION	ACM ASBESTOS CONTAINING MATERIAL ACT ACOUSTIC CEILING TILE	ROOM NAME NAME — ROOM NAME  & NUMBER *** ROOM NUMBER	DEFINITIONS GENERAL     A. GENERAL RENOVATION NOTES: RENOVATION NOTES AS     TOURIS ON THE OWNER OF THE OWNER OWNE	
		6	5 5/8"	6"		•		- 6" CMU, SEE SPECIFICATION FOR MASONRY REQUIREMENTS PERIMETER CAULKED (1) LAYER OF 5/8" BACKERBOARD AND 1/4" PORCELAIN TILE ON EACH SIDE OF CMU SCREW ATTACHED @ 12" O.C.	ADA AMERICAN WITH DISABILITIES ACT AFF ABOVE FINISHED FLOOR AHJ AUTHORITY HAVING JURISDICTION AHU AIR HANDLING UNIT	EXISTING CONSTRUCTION	FOUND ON THIS SHEET SHALL APPLY TO ALL PRIME CONTRACTORS AND TO ALL AREAS THROUGHOUT THE EXISTING FACILITY. B. SPECIFIC RENOVATION NOTES: RENOVATION NOTES ARE FOUND	
		6a*	7 3/8"	6"		1 HOUR		- SCREW ATTACHED @ 12 O.C 6" CMU, SEE SPECIFICATION FOR MASONRY REQUIREMENTS PERIMETER CAULKED (1) LAYER OF 5/8" BACKERBOARD AND 1/4" PORCELAIN TILE ON ONE SIDE OF CMU.	CJ CONTROL JOINT CL CENTER LINE	DEMOLISHED CONSTRUCTION	THROUGHOUT THE CONTRACT DRAWINGS AND APPLY TO THE RESPONSIBLE PRIME CONTRACTOR. THESE NOTES ARE SPECIFIC TO THE AREA OR ITEM INDICATED AND FOR ALL	
1		6b*	6 1/2"	6"		1 HOUR		- SCREW ATTACHED @ 12" O.C.  - 6" CMU, SEE SPECIFICATION FOR MASONRY REQUIREMENTS.  - PERIMETER CAULKED.	CMU CONCRETE MASONRY UNIT CONC CONCRETE CONT CONTINUOUS CPT CARPET TILE	NEW CONSTRUCTION	SIMILAR (TYPICAL) CONDITIONS.  2. PRIOR TO THE COMMENCEMENT OF WORK IN EACH AREA THE	
		8*	7 5/8"	8"		1 HOUR		- 8" CMU, SEE SPECIFICATION FOR MASONRY REQUIREMENTS PERIMETER CAULKED (1) LAYER OF 5/8" GYPSUM BOARD ON ONE SIDE OF CMU.	CT CERAMIC TILE CUH CABINET UNIT HEATER	REVISION TAG 1	OWNER SHALL REMOVE ALL MOVABLE ITEMS INCLUDING SHELVING, FURNITURE, EQUIPMENT AND SUPPLIES. ALL FIXED ITEMS DESIGNATED FOR REMOVAL INCLUDING BUT NOT LIMITED	
		8a	8 1/4"	8"		-		- SCREW ATTACHED @ 12" O.C 8" CMU, SEE SPECIFICATION FOR MASONRY REQUIREMENTS PERIMETER CAULKED.	DEMO DEMOLISH OR DEMOLITION DIA DIAMETER DN DOWN	DEMO TAG	TO CASEWORK, CHALK AND TACKBOARDS, PROJECTION SCREENS, ETC. SHALL BE REMOVED, DISPOSED OF OR SAFELY STORED (IF SCHEDULED FOR REUSE) BY THE GENERAL	
		8b*	9 3/8"	8"		1 HOUR		- (1) LAYER OF 5/8" BACKERBOARD AND 1/4" PORCELAIN TILE ON EACH SIDE OF CMU SCREW ATTACHED @ 12" O.C 8" CMU, SEE SPECIFICATION FOR MASONRY REQUIREMENTS PERIMETER CAULKED.	EFEC EXISTING FIRE EXTINGUISHER CABINET EIFS EXTERIOR FINISH & INSULATION SYSTEM EJ EXPANSION JOINT	KEYNOTE TAG 1	CONTRACTOR OR, IF SCHEDULED AS PART OF HAZ MAT REMOVAL IN DEMO DRAWINGS. THE OWNER SHALL RESERVE THE RIGHT TO MAINTAIN OWNERSHIP OF ANY AND ALL EXISTING ITEMS SCHEDULED FOR REMOVAL.	
_			·						EPDM ETHYLENE PROPYLENE DIENE M-CLASS (ROOFING) EPX-PT EPOXY PAINT EPX-T EPOXY TERRAZZO	EQUIPMENT TAG	THE GENERAL CONTRACTOR SHALL BE RESPONSIBLE FOR THE COORDINATION OF DEMOLITION, REMOVAL AND PROPER	
		MARK		NESS	STC UL	FIRE RATING	ACOUSTICA	DESCRIPTION	EQ EQUAL, EQUALLY  ETR EXISTING TO REMAIN	DOOR TAG 100A	DISPOSAL OF ALL EXISTING STRUCTURAL COMPONENTS, FLOORS, WALLS, CEILINGS, DOORS AND FRAMES, CASEWORK, CONCRETE FOUNDATIONS AND SLABS, AND ALL ATTACHED OR	
		WIFALAX	OVERALL	STUD	010 02	TINE IVATING	INSULATION	- (1) LAYER OF 5/8" TYPE-X GYPSUM BOARD ON ONE SIDE OF STUD.	FB FIRE BARRIER FF&E FIXTURES, FURNISHINGS & EQUIPMENT	WINDOW TAG 1	RELATED MATERIALS AND SYSTEMS AS DESIGNATED IN THE CONTRACT DOCUMENTS AND AS NEEDED FOR A COMPLETE AND PROPER RENOVATION PROJECT. UNLESS OTHERWISE NOTED, THE REMAINING FLOOR, WALL OR CEILING SYSTEM AFFECTED	
		1a	1 1/2"					- SCREW ATTACHED @ 12" O.C 7/8" HAT CHANNEL @ 16" O.C. SEE SPECIFICATION FOR METAL STUD REQUIREMENTS PERIMETER CAULKED (1) LAYER OF 5/8" BACKERBOARD AND 1/4" PORCELAIN TILE ONE ONE SIDE OF STUD.	GA GAUGE GC GENERAL CONTRACTOR GWB GYPSUM WALL BOARD	BORROWED BL LITE TAG 3	BY CUTTING OR DEMOLITION SHALL BE PATCHED TO THE EXTENT REQUIRED TO MATCH ADJACENT CONSTRUCTION MATERIALS AND FINISHES AS NOTED ON ALL A-SERIES SHEETS.	
2		1b	7/8"			-		- (1) LAYER OF 5/8 BACKERBOARD AND 1/4 FORGELAIN FILE ONE ONE SIDE OF STOD.  - SCREW ATTACHED @ 12" O.C.  - PERIMETER CAULKED.  - (1) LAYER OF 5/8" TYPE-X GYPSUM BOARD ON ONE SIDE OF STUD.	HP HIGH POINT HVAC HEATING, VENTILATING, AND AIR CONDITIONING	STOREFRONT ST CURTAIN WALL 5	SEE SPECIFICATIONS AND DRAWINGS FOR ADDITIONAL REQUIREMENTS OF EACH PRIME CONTRACTOR.	
		1c	2 5/8"					- SCREW ATTACHED @ 12" O.C. - 7/8" HAT CHANNEL @ 16" O.C. SEE SPECIFICATION FOR METAL STUD REQUIREMENTS. - PERIMETER CAULKED.	ID INSIDE DIAMETER IMP INSULATED METAL PANEL IN INCH(ES) IRGWB IMPACT RESISTANT GYPSUM WALL BOARD	PARTITION A20 TAG	4. PRIOR TO DEMOLITION, DISCONNECTION OF ALL RELATED POWER, WIRING, ELECTRICAL FIXTURES AND LIGHTING SHALL BE PERFORMED BY THE PRIME ELECTRICAL CONTRACTOR. THE	
		4	4 7/8"	3 5/8"	39	-	Yes	- (1) LAYER OF 5/8" TYPE-X GYPSUM BOARD EACH SIDE OF STUD SCREW ATTACHED @ 12" O.C 3 5/8" METAL STUDS @ 16" O.C. SEE SPECIFICATION FOR METAL STUD REQUIREMENTS 3 1/2" SOUND ATTENUATION BATT INSULATION.	LAV LAVATORY LP LOW POINT	CASEWORK TAG CDS CABINET STYLE DESIGNATION	DISCONNECTION OF ALL RELATED DRAIN PIPING, WATER SUPPLY PIPING, VENT PIPING, AND RELATED PLUMBING FIXTURES SHALL BE PROVIDED BY THE PRIME PLUMBING CONTRACTOR. ALL DISCONNECTS OF HEATING SURDLY BETTIED DIRECT DUCT	
								- PERIMETER CAULKED.  - (1) LAYER OF 5/8" TYPE-X GYPSUM BOARD EACH SIDE OF STUD.  - SCREW ATTACHED @ 12" O.C.	LVT LUXURY VINYL TILE  MAX MAXIMUM MFR MANUFACTURER	INTERIOR ELEVATIONS	DISCONNECTS OF HEATING SUPPLY, RETURN PIPING, DUCT WORK, FANS, RELATED MOTORS, PIPING & CONTROLS SHALL BE PROVIDED BY THE MECHANICAL CONTRACTOR.	KEY PLAN:
		4*	4 7/8"	3 5/8"	39 U465	1 HOUR	Yes	- 3 5/8" METAL STUDS @ 16" O.C. SEE SPECIFICATION FOR METAL STUD REQUIREMENTS 3 1/2" SOUND ATTENUATION BATT INSULATION PERIMETER CAULKED.	MO MASONRY OPENING MIN MINIMUM MRGWB MOISTURE-RESISTANT GYPSUM WALL BOARD	A201 2 - ELEVATION NUMBER SHEET WHERE ELEVATION IS SHOWN	CONTRACTOR, EXCEPT DRILLED OPENINGS OF 8" OR LESS IN	
		4b	4 1/4"	3 5/8"		-	Yes	- (1) LAYER OF 5/8" TYPE-X GYPSUM BOARD ON ONE SIDE OF STUD SCREW ATTACHED @ 12" O.C 3 5/8" METAL STUDS @ 16" O.C. SEE SPECIFICATION FOR METAL STUD REQUIREMENTS 3 1/2" SOUND ATTENUATION BATT INSULATION.	NFEC NEW FIRE EXTINGUISHER CABINET NA NOT APPLICABLE NIC NOT IN CONTRACT	EXTERIOR ELEVATIONS  A  ELEVATION NUMBER SHEET WHERE ELEVATION	DIAMETER OR CUT OPENINGS LESS THAN 100 SQUARE INCHES WHICH SHALL BE BY EACH RESPECTIVE PRIME CONTRACTOR AS PER SPECIFICATION SECTION 01-7329 UNLESS OTHERWISE	
								- PERIMETER CAULKED.  - (1) LAYER OF 5/8" BACKERBOARD AND 1/4" PORCELAIN TILE ON EACH SIDE OF STUD.  - SCREW ATTACHED @ 12" O.C.	NR NON-RATED  NTS NOT TO SCALE	IS SHOWN  A DETAIL NUMBER  DETAIL OUTST WITE DETAIL	6. ALL EXISTING FLOOR, WALL, CEILING AND MISCELLANEOUS	
		4c	5 3/8"	3 5/8"		-	Yes	- 3 5/8" METAL STUDS @ 16" O.C. SEE SPECIFICATION FOR METAL STUD REQUIREMENTS 3 1/2" SOUND ATTENUATION BATT INSULATION PERIMETER CAULKED.	OC ON CENTER OD OUTSIDE DIAMETER OFCI OWNER FURNISHED CONTRACTOR INSTALLED	MARK SHEET WHERE DETAIL IS SHOWN	SURFACES SCHEDULED IN THE CONTRACT DOCUMENTS TO RECEIVE NEW FINISHES SHALL BE PROPERLY REPAIRED, PATCHED AND PREPARED TO RECEIVE NEW SPECIFIED FINISHES ALL IN ACCORDANCE WITH THE NEW FINISH MANUFACTURER'S	D
		4c*	5 3/8"	3 5/8"		1 HOUR	Yes	- (1) LAYER OF 5/8" BACKERBOARD AND 1/4" PORCELAIN TILE ON EACH SIDE OF STUD SCREW ATTACHED @ 12" O.C 3 5/8" METAL STUDS @ 16" O.C. SEE SPECIFICATION FOR METAL STUD REQUIREMENTS 3 1/2" SOUND ATTENUATION BATT INSULATION.	OFOI OWNER FURNISHED OWNER INSTALLED  PACM PRESUMED ASBESTOS CONTAINING MATERIAL PNT PAINT	WALL SECTION MARK  1 SECTION NUMBER SHEET WHERE SECTION IS SHOWN	WRITTEN RECOMMENDATIONS. PREPARATION OF WALLS, FLOORS, AND CEILINGS TO RECIEVE NEW FINISHES SHALL INCLUDE THE INFILL OF ALL EXISTING HOLES, CRACKS, AND	
3								- PERIMETER CAULKED.  - (1) LAYER OF 5/8" BACKERBOARD AND 1/4" PORCELAIN TILE ON ONE SIDE OF STUD.  - SCREW ATTACHED @ 12" O.C.	PRT PORCELAIN TILE PT PRESSURE TREATED PVC POLYVINYL CHLORIDE	SECTION NUMBER	IMPERFECTIONS FOR A SMOOTH APPEARANCE TO MATCH ADJACENT SURFACES. PREPARATION OF EXISTING FLOORS SHALL INCLUDE THE INSTALLATION OF CEMENTITIOUS SELF-	B1 B2 A
		4d	4 1/2"	3 5/8"		-	Yes	- 3 5/8" METAL STUDS @ 16" O.C. SEE SPECIFICATION FOR METAL STUD REQUIREMENTS 3 1/2" SOUND ATTENUATION BATT INSULATION PERIMETER CAULKED.	RCP REFLECTED CEILING PLAN RD ROOF DRAIN REBAR REINFORCING BAR	BUILDING SECTION MARK SHEET WHERE SECTION IS SHOWN	LEVELING FLOOR UNDERLAYMENT AS REQUIRED TO PROVIDE A LEVEL SURFACE IN WHICH NEW FLOOR FINISHES APPEAR AS SMOOTH SURFACES WITH NO TELEGRAPHING DETECTABLE FOR	
		4e	5 1/8"	3 5/8"		-	Yes	- (1) LAYER OF 5/8" BACKERBOARD AND 1/4" PORCELAIN TILE ON EACH SIDE OF STUD (1) LAYER OF 5/8" TYPE-X GYPSUM BOARD ON ONE SIDE OF STUD SCREW ATTACHED @ 12" O.C 3 5/8" METAL STUDS @ 16" O.C. SEE SPECIFICATION FOR METAL STUD REQUIREMENTS.	REV REVISION(S), REVISED  RO ROUGH OPENING	REFERENCE TO SLAB ELEVATION ELEV 99'-11 1/2"	A FINISHED PRODUCT.  7. ALL PRIME CONTRACTORS SHALL BE RESPONSIBLE FOR THE TIMELY REMOVAL AND OFF SITE DISPOSAL OF ALL DEBRIS	
								- 3 1/2" SOUND ATTENUATION BATT INSULATION PERIMETER CAULKED.  - (1) LAYER OF 5/8" BACKERBOARD AND 1/4" PORCELAIN TILE ON EACH SIDE OF STUD.	RTU ROOF TOP UNIT  SB SMOKE BARRIER	1 222 00 11 1/2	RESULTING FROM THEIR WORK. ABSOLUTELY NO DEBRIS (I.E. PLASTER, MORTAR, CONCRETE, PAINT, ETC.) EITHER DIRECTLY OR BY CLEANING OF TOOLS, SHALL BE DISPOSED OF THROUGH	SED NO. 22-04-01-04-0-003-011  COPYRIGHT © 2024 - BCA ARCHITECTS & ENGINEERS, WARNING - IT IS A VIOLATION THE NEW YORK STATE EDUCATION LAW FOR ANY UNAUTHORIZED ALTERATIONS TO
_		4e*	5 1/8"	3 5/8"		1 HOUR	Yes	- (1) LAYER OF 5/8" TYPE-X GYPSUM BOARD ON ONE SIDE OF STUD SCREW ATTACHED @ 12" O.C 3 5/8" METAL STUDS @ 16" O.C. SEE SPECIFICATION FOR METAL STUD REQUIREMENTS.	SF SQUARE FOOT (FEET) SIM SIMILAR SPEC SPECIFIED OR SPECIFICATION		PLUMBING FIXTURES AND EXISTING SANITARY WASTE PIPING SYSTEMS. IF THE PROPER CLEAN UP IS NOT PROVIDED TO THE SATISFACTION OF THE OWNER AND THE ENGINEER, ANY	BCA Architects & Engineer
								- 3 1/2" SOUND ATTENUATION BATT INSULATION PERIMETER CAULKED (1) LAYER OF 5/8" TYPE-X GYPSUM BOARD ON EACH SIDE OF STUD SCREW ATTACHED @ 12" O.C.	SS SOLID SURFACE STC SOUND TRANSMISSION CLASS		INDEPENDENT COSTS INCURRED BY THE OWNER TO OBTAIN CLEAN UP SERVICES SHALL BE BILLED DIRECTLY TO THE PRIME CONTRACTORS AS DIRECTED BY THE ARCHITECT. INSUFFICIENT	Watertown   Ithaca   Saratoga Springs
		6	7 1/4"	6"		-	Yes	- 6" METAL STUDS @ 16" O.C. SEE SPECIFICATION FOR METAL STUD REQUIREMENTS 3 1/2" SOUND ATTENUATION BATT INSULATION PERIMETER CAULKED.	T&G TONGUE AND GROOVE TBD TO BE DETERMINED TOS TOP OF STEEL TOW TOP OF WALL		PRIME CONTRACTORS CLEAN UP THROUGHOUT THE DURATION OF THIS PROJECT WILL NOT BE TOLERATED.	Rochester   Troy   Binghamton  www.thebcgroup.com
		6*	7 1/4"	6"	U465	1 HR	Yes	- (1) LAYER OF 5/8" TYPE-X GYPSUM BOARD ON EACH SIDE OF STUD SCREW ATTACHED @ 12" O.C 6" METAL STUDS @ 16" O.C. SEE SPECIFICATION FOR METAL STUD REQUIREMENTS.	TYP TYPICAL  UNO UNLESS NOTED OTHERWISE			$D \subset \Lambda$
								- 3 1/2" SOUND ATTENUATION BATT INSULATION PERIMETER CAULKED (1) LAYER OF 5/8" TYPE-X GYPSUM BOARD ON EACH SIDE OF STUD (1) LAYER OF RESILIENT CHANNEL ON ONE SIDE OF STUD.	VCT VINYL COMPOSITION TILE VIF VERIFY IN FIELD	₹+		NOT FOR
4		6a	7 3/4"	6"		-	Yes	- SCREW ATTACHED @ 12" O.C 6" METAL STUDS @ 16" O.C. SEE SPECIFICATION FOR METAL STUD REQUIREMENTS 3 1/2" SOUND ATTENUATION BATT INSULATION.	W/ WITH	CENEDAL DOOM	VN CENTRAL SCHOOL	CONSTRUCTION ARCHITECT
								- PERIMETER CAULKED.  - (1) LAYER OF 5/8" TYPE-X GYPSUM BOARD ON EACH SIDE OF STUD.  - (1) LAYER OF RESILIENT CHANNEL ON ONE SIDE OF STUD.	MATERIAL INDICATORS	7 5,1	PITAL PROJECT	ENGINEER
		6a*	7 3/4"	6"	U465	1 HR	Yes	- SCREW ATTACHED @ 12" O.C 6" METAL STUDS @ 16" O.C. SEE SPECIFICATION FOR METAL STUD REQUIREMENTS 3 1/2" SOUND ATTENUATION BATT INSULATION PERIMETER CAULKED.	STEEL	— WHITE BACKGROUND — DEXTI	ER, NEW YORK  BLACK LETTERING, TYP.	-W
		6b	6 5/8"	6"		-	Yes	- (1) LAYER OF 5/8" TYPE-X GYPSUM BOARD ON ONE SIDE OF STUD SCREW ATTACHED @ 12" O.C 6" METAL STUDS @ 16" O.C. SEE SPECIFICATION FOR METAL STUD REQUIREMENTS.	BRICK	SUPERINTENDENT OF SCHOOLS:	CONTRACT NO. 1 - GENERAL CONTRACTOR  Municipality, State	
_								- 3 1/2" SOUND ATTENUATION BATT INSULATION PERIMETER CAULKED (1) LAYER OF 5/8" BACKERBOARD AND 1/4" PORCELAIN TILE ON EACH SIDE OF STUD (1) LAYER OF 5/8" TYPE-X GYPSUM BOARD ON ONE SIDE OF STUD.	UNEXCAVATED	SUPERINTENDENT	CONTRACT NO. 2 - MECHANICAL CONTRACTOR Municipality, State	
		6c*	7 1/2"	6"		1 HOUR	Yes	- SCREW ATTACHED @ 12" O.C.  - 6" METAL STUDS @ 16" O.C. SEE SPECIFICATION FOR METAL STUD REQUIREMENTS.  - 3 1/2" SOUND ATTENUATION BATT INSULATION.	EARTH CONCRETE	BOARD OF EDUCATION: PRESIDENT	CONTRACT NO. 3 - PLUMBING CONTRACTOR Municipality, State	The state of the s
								- PERIMETER CAULKED.  - (1) LAYER OF 5/8" BACKERBOARD AND 1/4" PORCELAIN TILE ON ONE SIDE OF STUD.  - (1) LAYER OF 5/8" TYPE-X GYPSUM BOARD ON ONE SIDE OF STUD.	GWB	VICE PRESIDENT  SCHOOL LOGO —— RED LOGO-	CONTRACT NO. 4 - ELECTRICAL CONTRACTOR Municipality, State	
		6d*	8"	6"		1 HOUR	Yes	- (1) LAYER OF 1/2" RESILIENT CHANNEL ON ONE SIDE OF STUD SCREW ATTACHED @ 12" O.C 6" METAL STUDS @ 16" O.C. SEE SPECIFICATION FOR METAL STUD REQUIREMENTS 3 1/2" SOUND ATTENUATION BATT INSULATION.	PLYWOOD	4.7		
-								- PERIMETER CAULKED.  - (1) LAYER OF 5/8" BACKERBOARD AND 1/4" PORCELAIN TILE ON ONE SIDE OF STUD.  - (1) LAYER OF 5/8" TYPE-X GYPSUM BOARD ON ONE SIDE OF STUD.	CONCRETE BLOCK		BCA	
5		6e*	7 1/4"	6"		1 HOUR	Yes	- SCREW ATTACHED @ 12" O.C 6" METAL STUDS @ 16" O.C. SEE SPECIFICATION FOR METAL STUD REQUIREMENTS 3 1/2" SOUND ATTENUATION BATT INSULATION PERIMETER CAULKED.	CONCRETE		ARCHITECTS ENGINEERS	
								- FENIMETER GAOLRED.	BLOCK (SECTION)		- 1'-8" <u>2'-4"</u>	
									BATT INSULATION	2x4 FRAME	4x4 POSTS @ A DEPTH	GENERAL BROWN CSD
									RIGID WALL INSULATION	BLACK——	OF 48" BELOW GRADE & BACKBRACE AS REQUIRED	JUNIOR SENIOR HIGH SCHOOL
									ROOF INSULATION			17643 CEMETERY RD DEXTER - JEFFERSON - NEW YORK
									SPRAY FOAM	1.4		REV DATE DESCRIPTION
									WOOD BLOCKING			
												DRAWN BY PROJECT NUMBER
6											GRADE	MHK/ALS 2023-105  CHECKED BY DATE
12 PM												ARCHITECTURAL GENERAL NOTES
5:09:4										PRO\	ERAL CONTRACTOR SHALL  IDE (1) PROJECT SIGN TO BE	ABBREVIATIONS AND LEGENDS
2024 (										PROJECT SIGN DETAIL	TED IN A LOCATION AS CTED BY THE ARCHITECT	BUILDING NUMBER SHEET NUMBER
2/17/2										1 SCALE: 3/4" = 1'-0"		HS AS000
<u> </u>	H		F				Е	D	С	В	А	

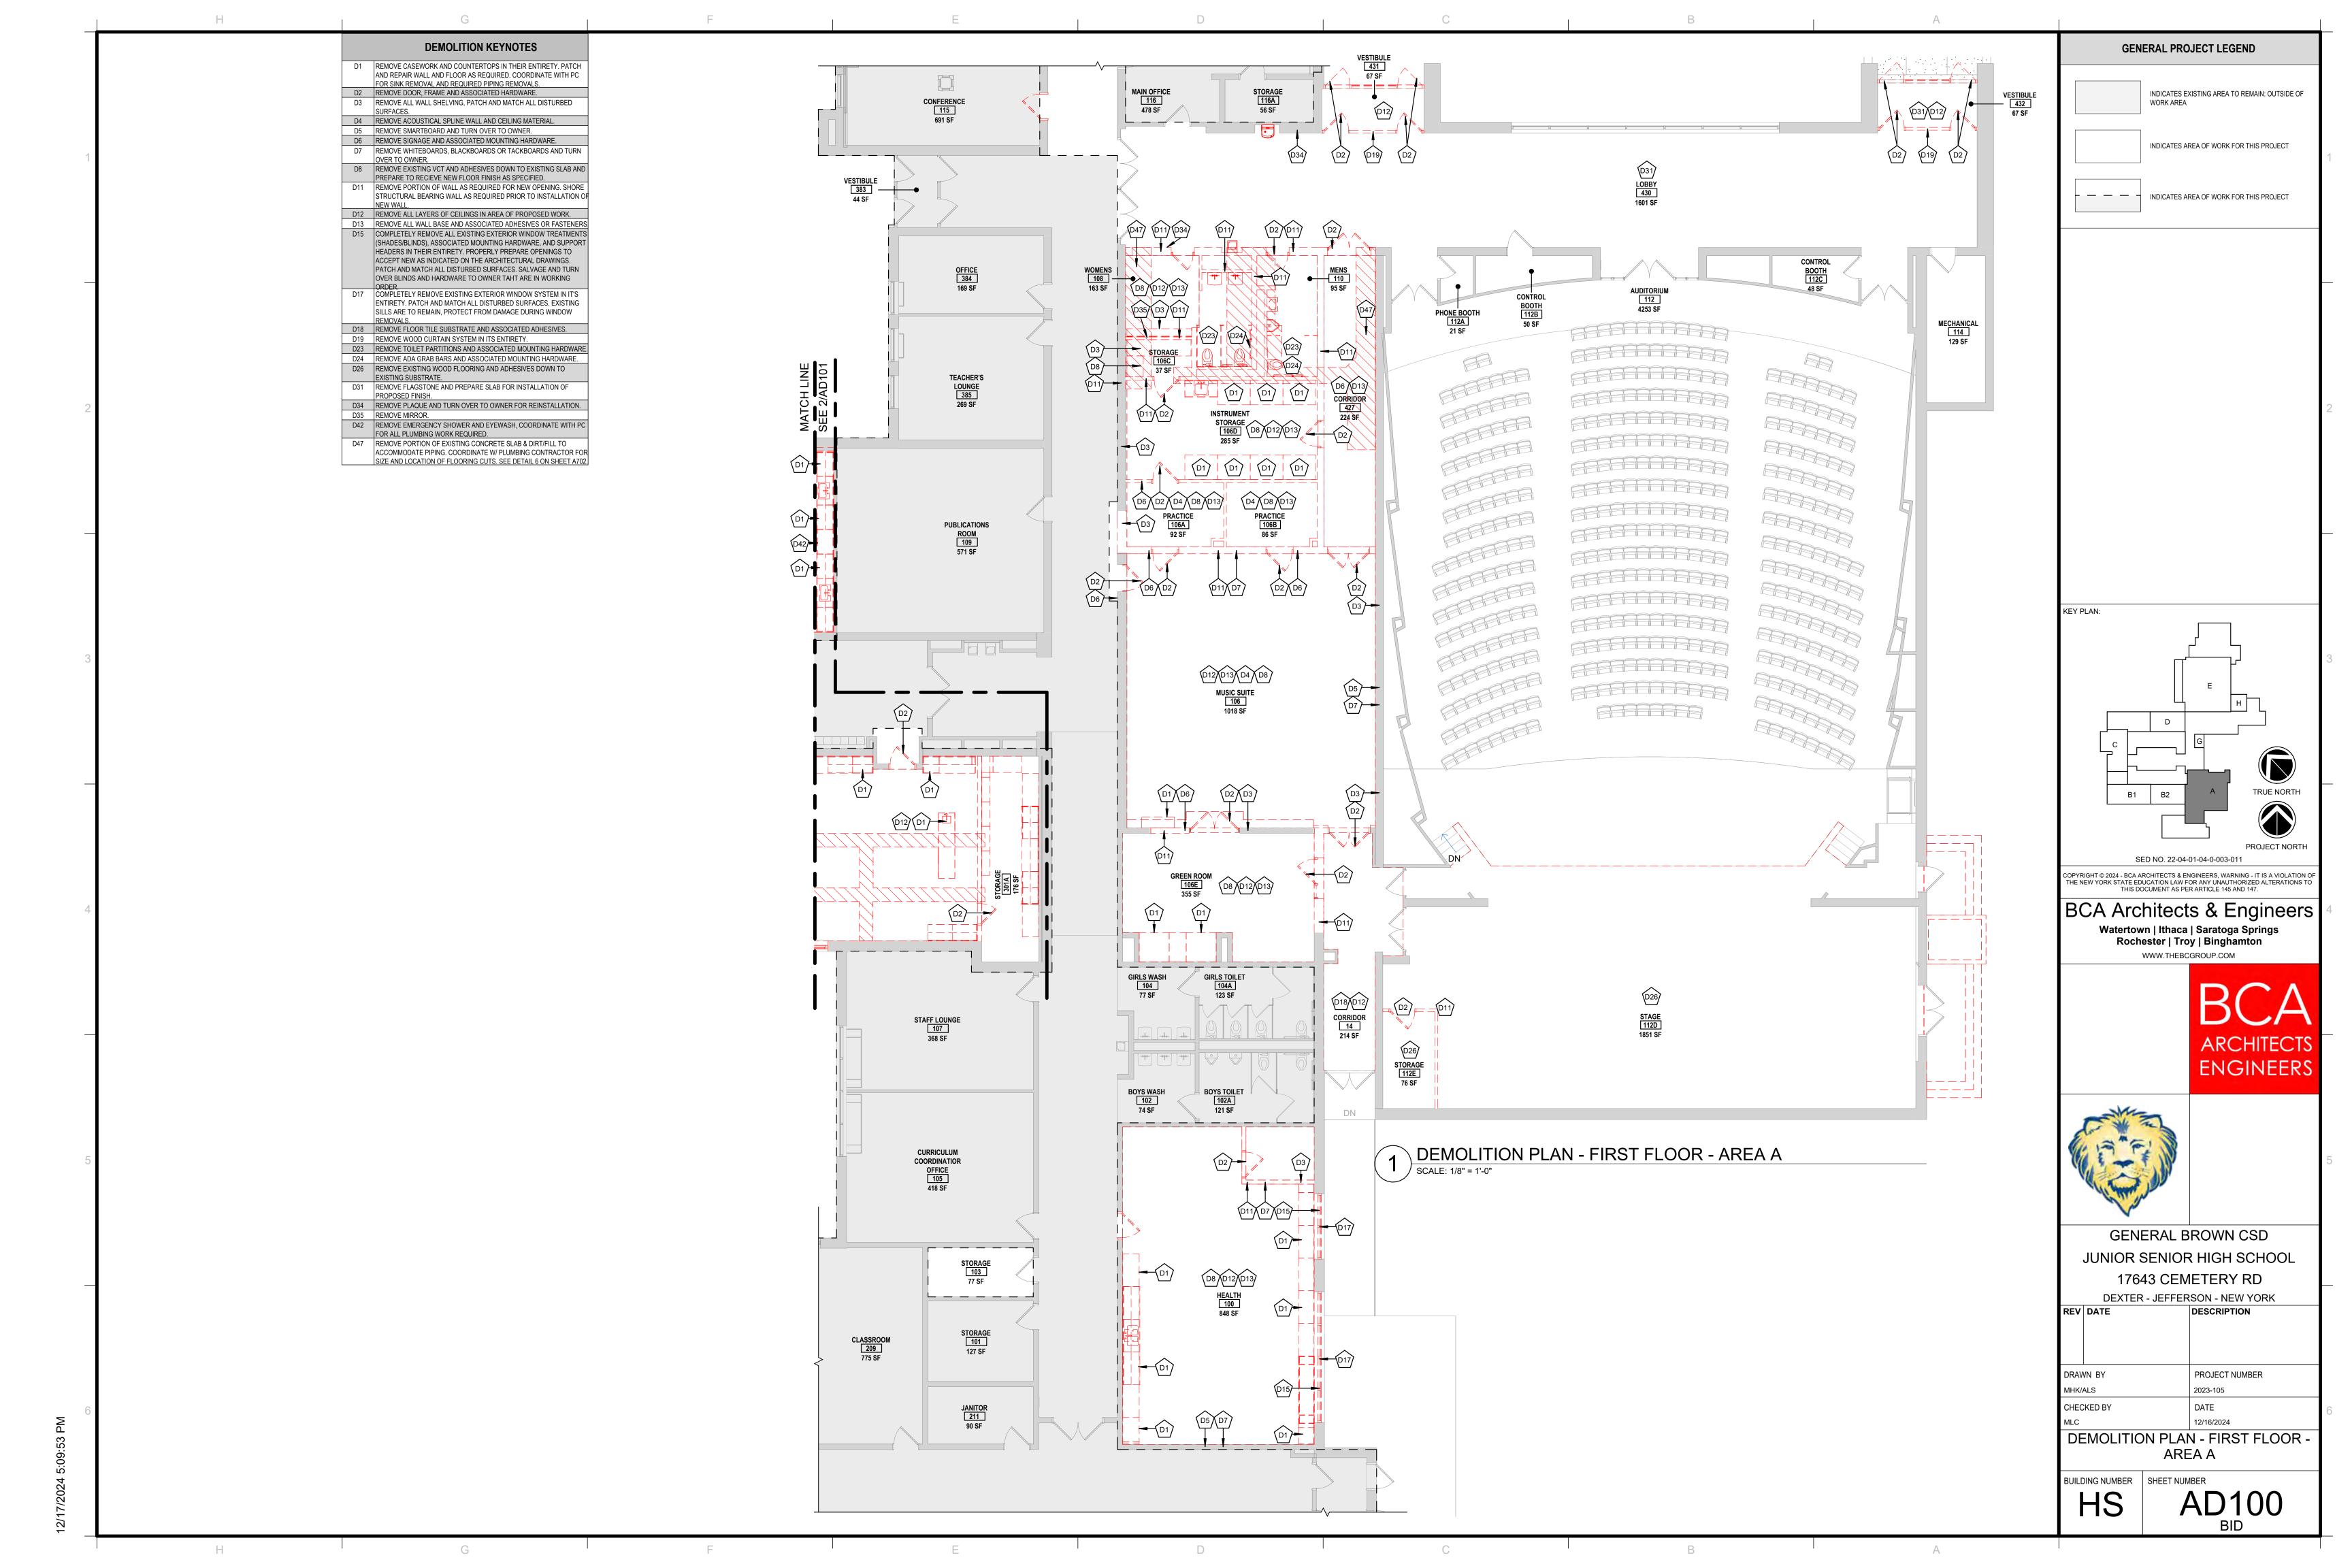


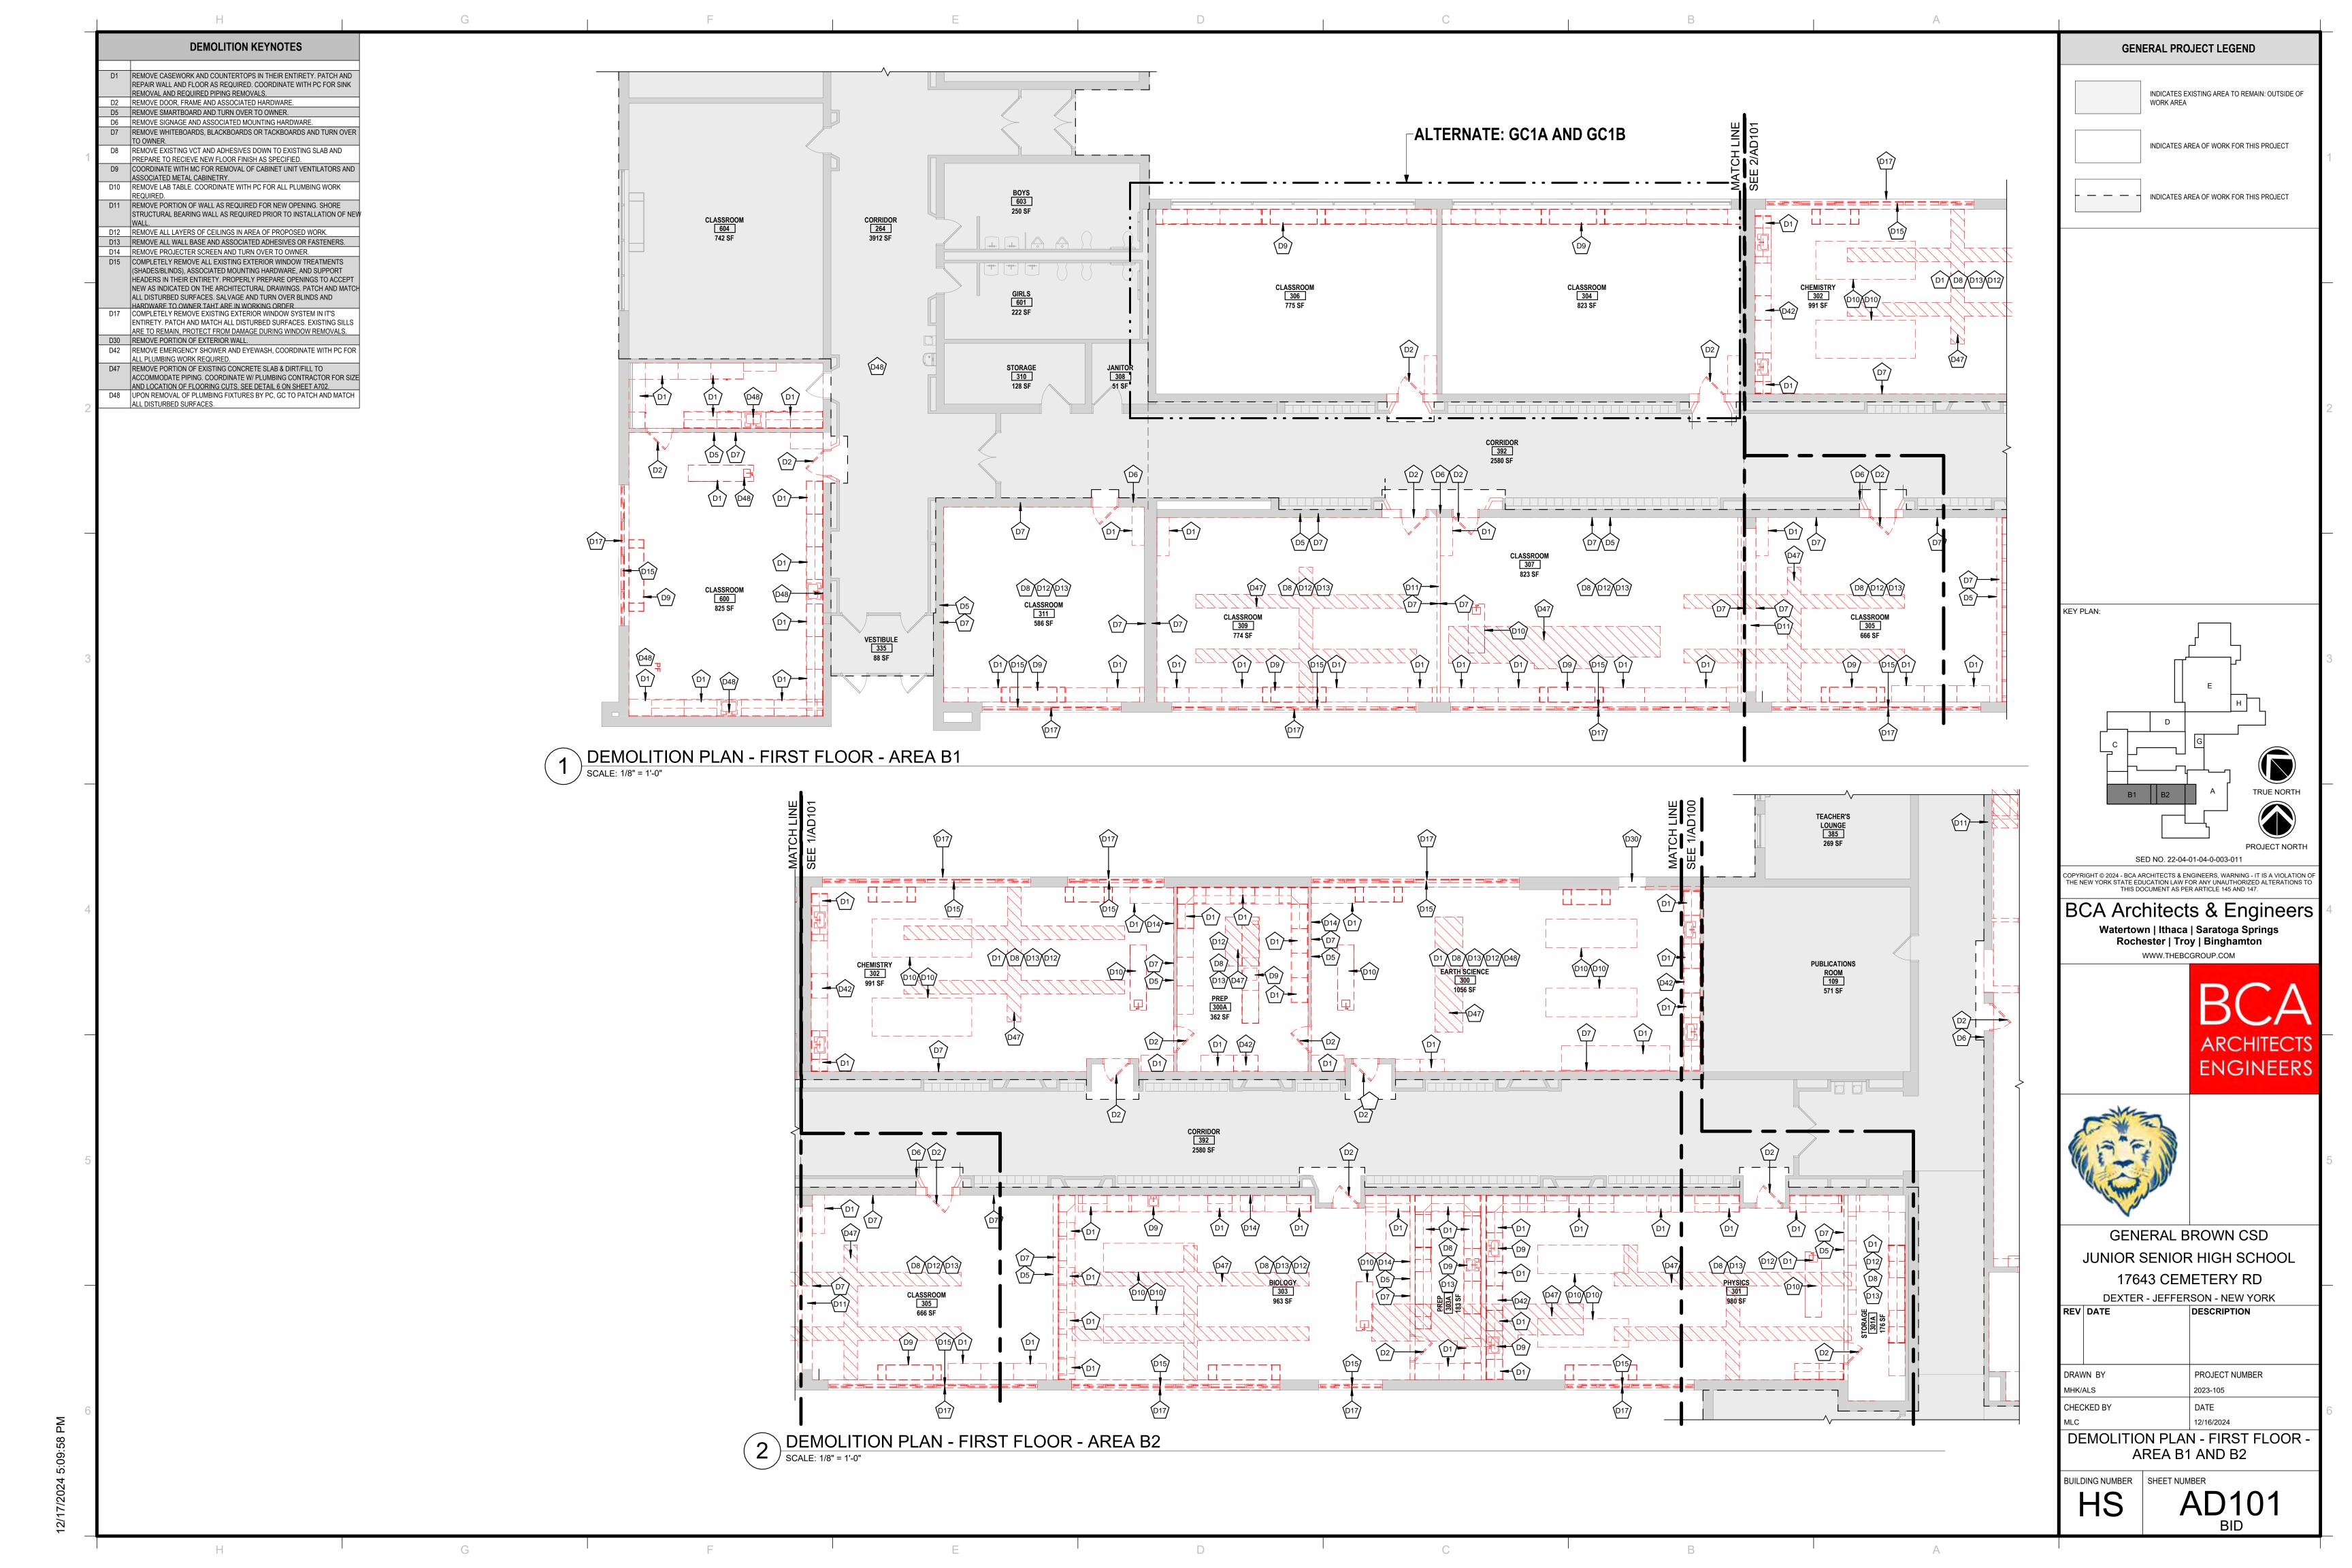


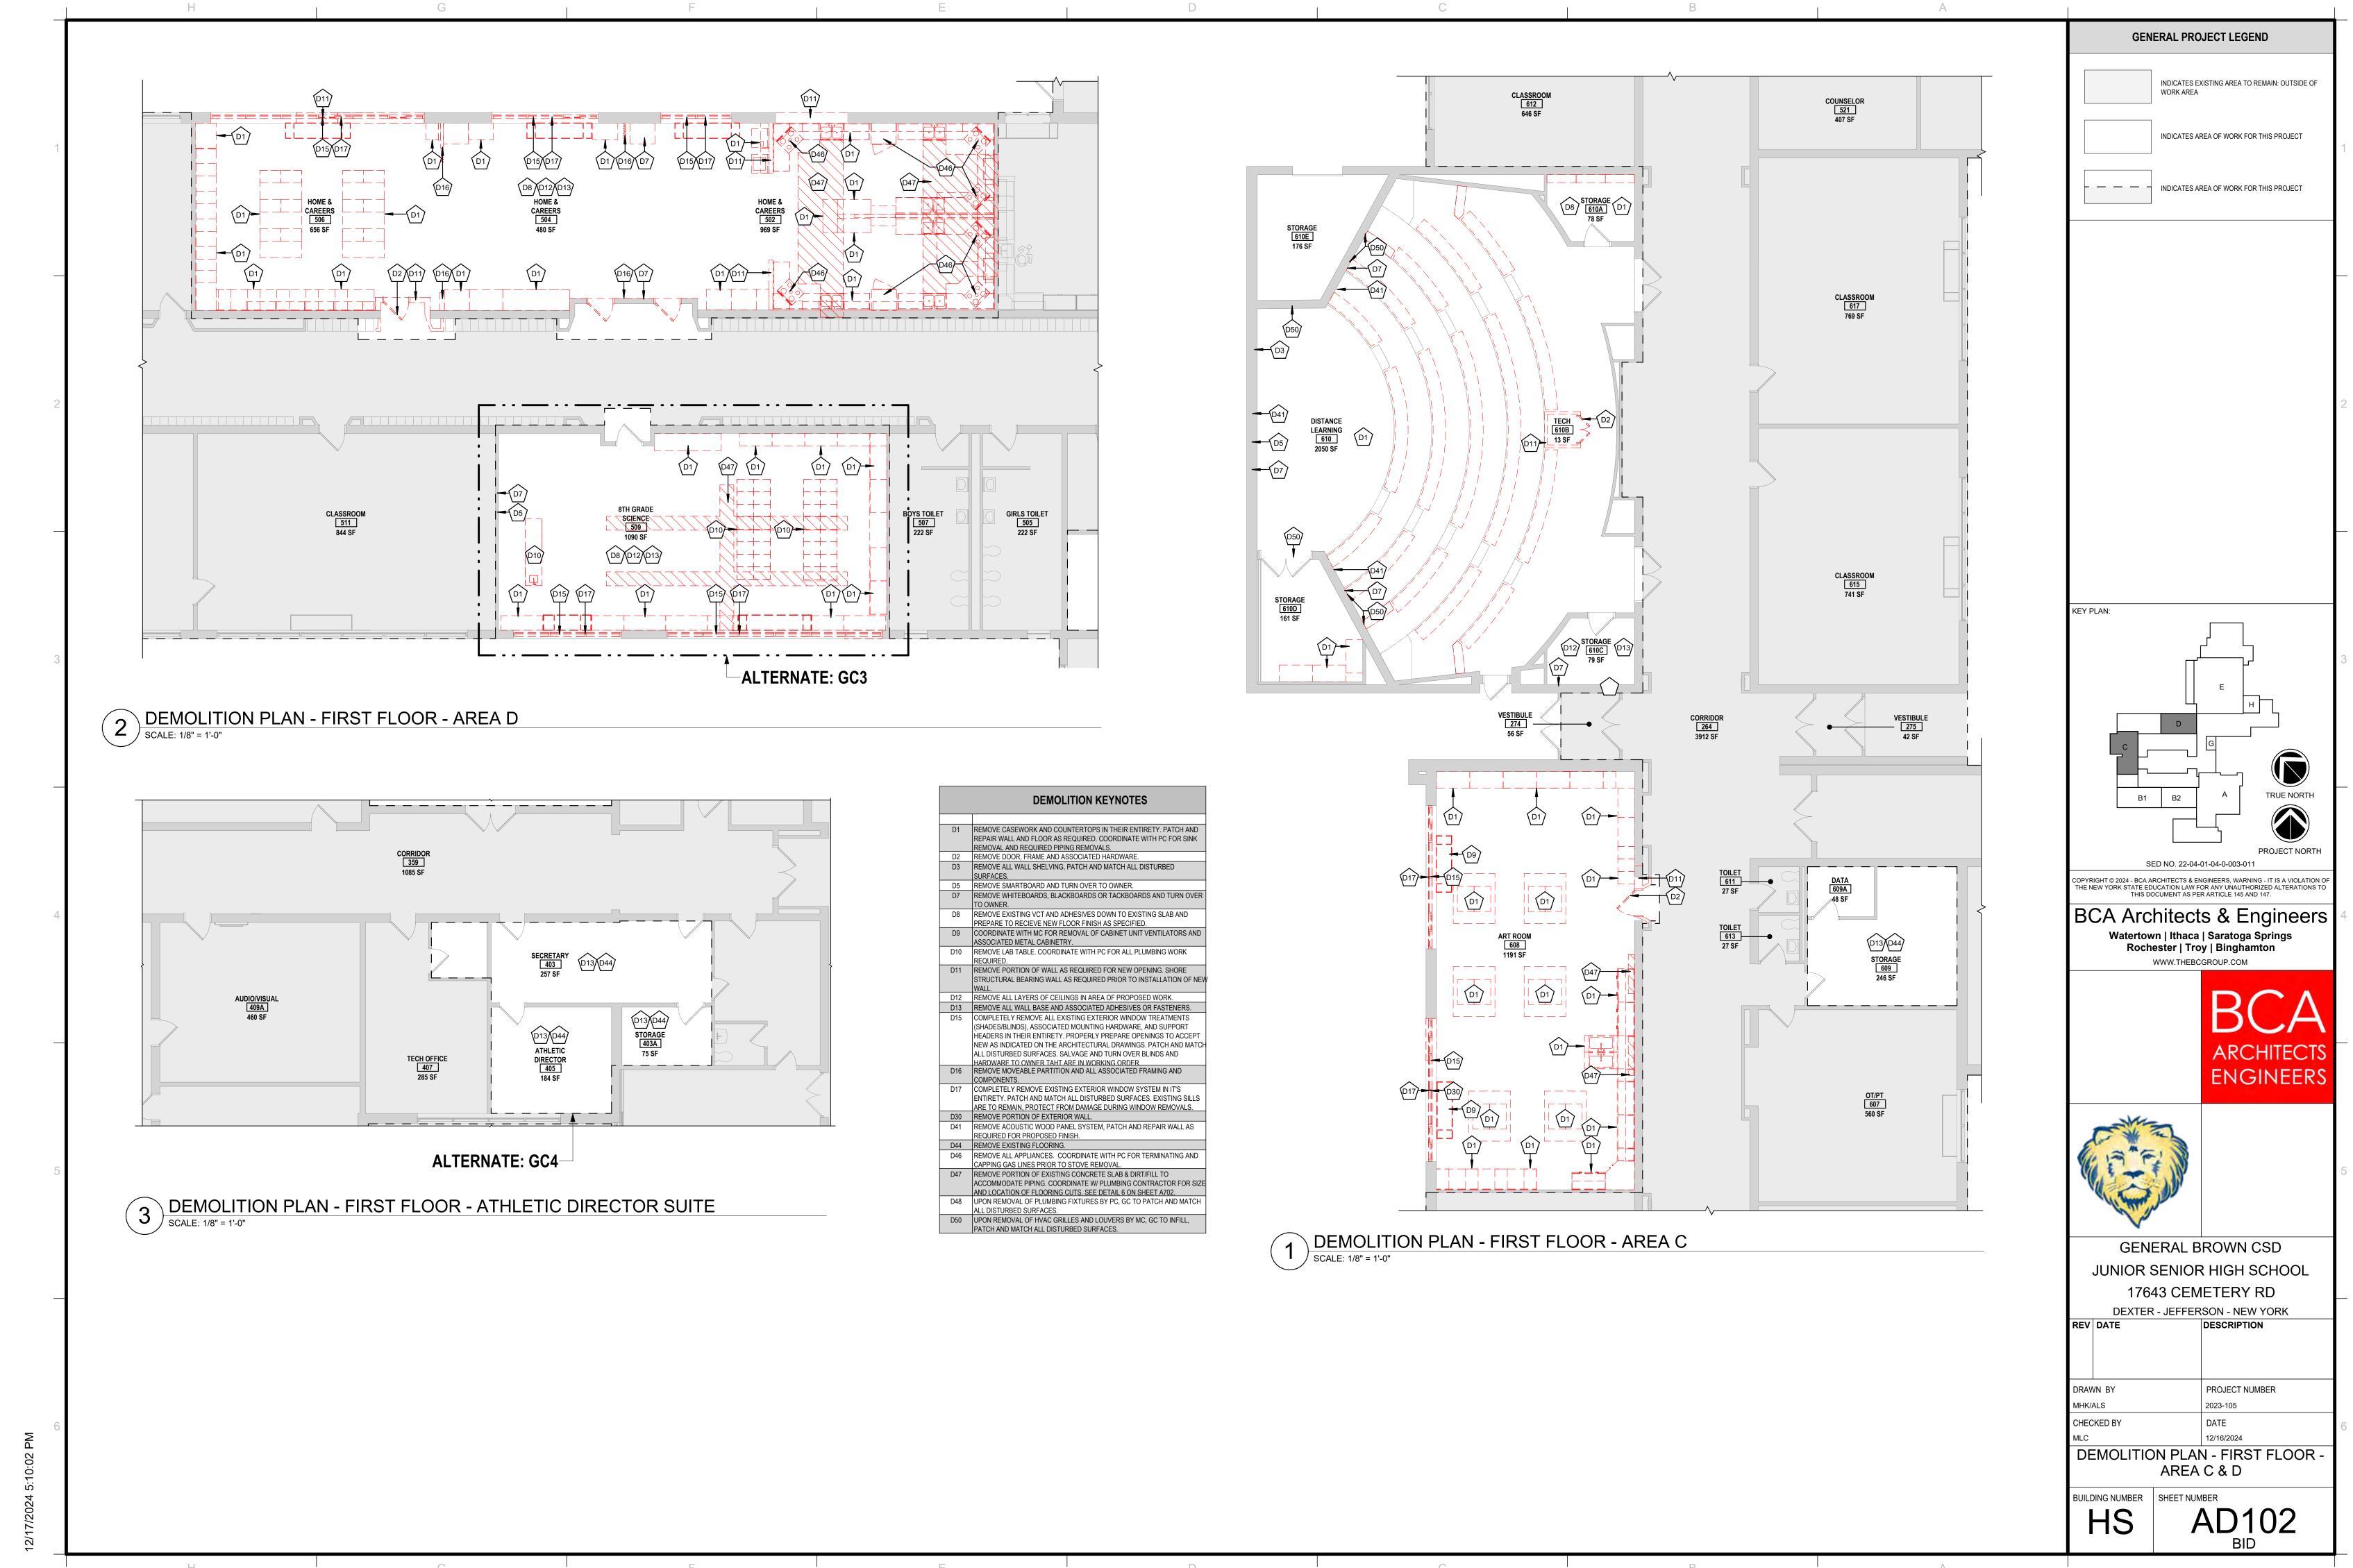


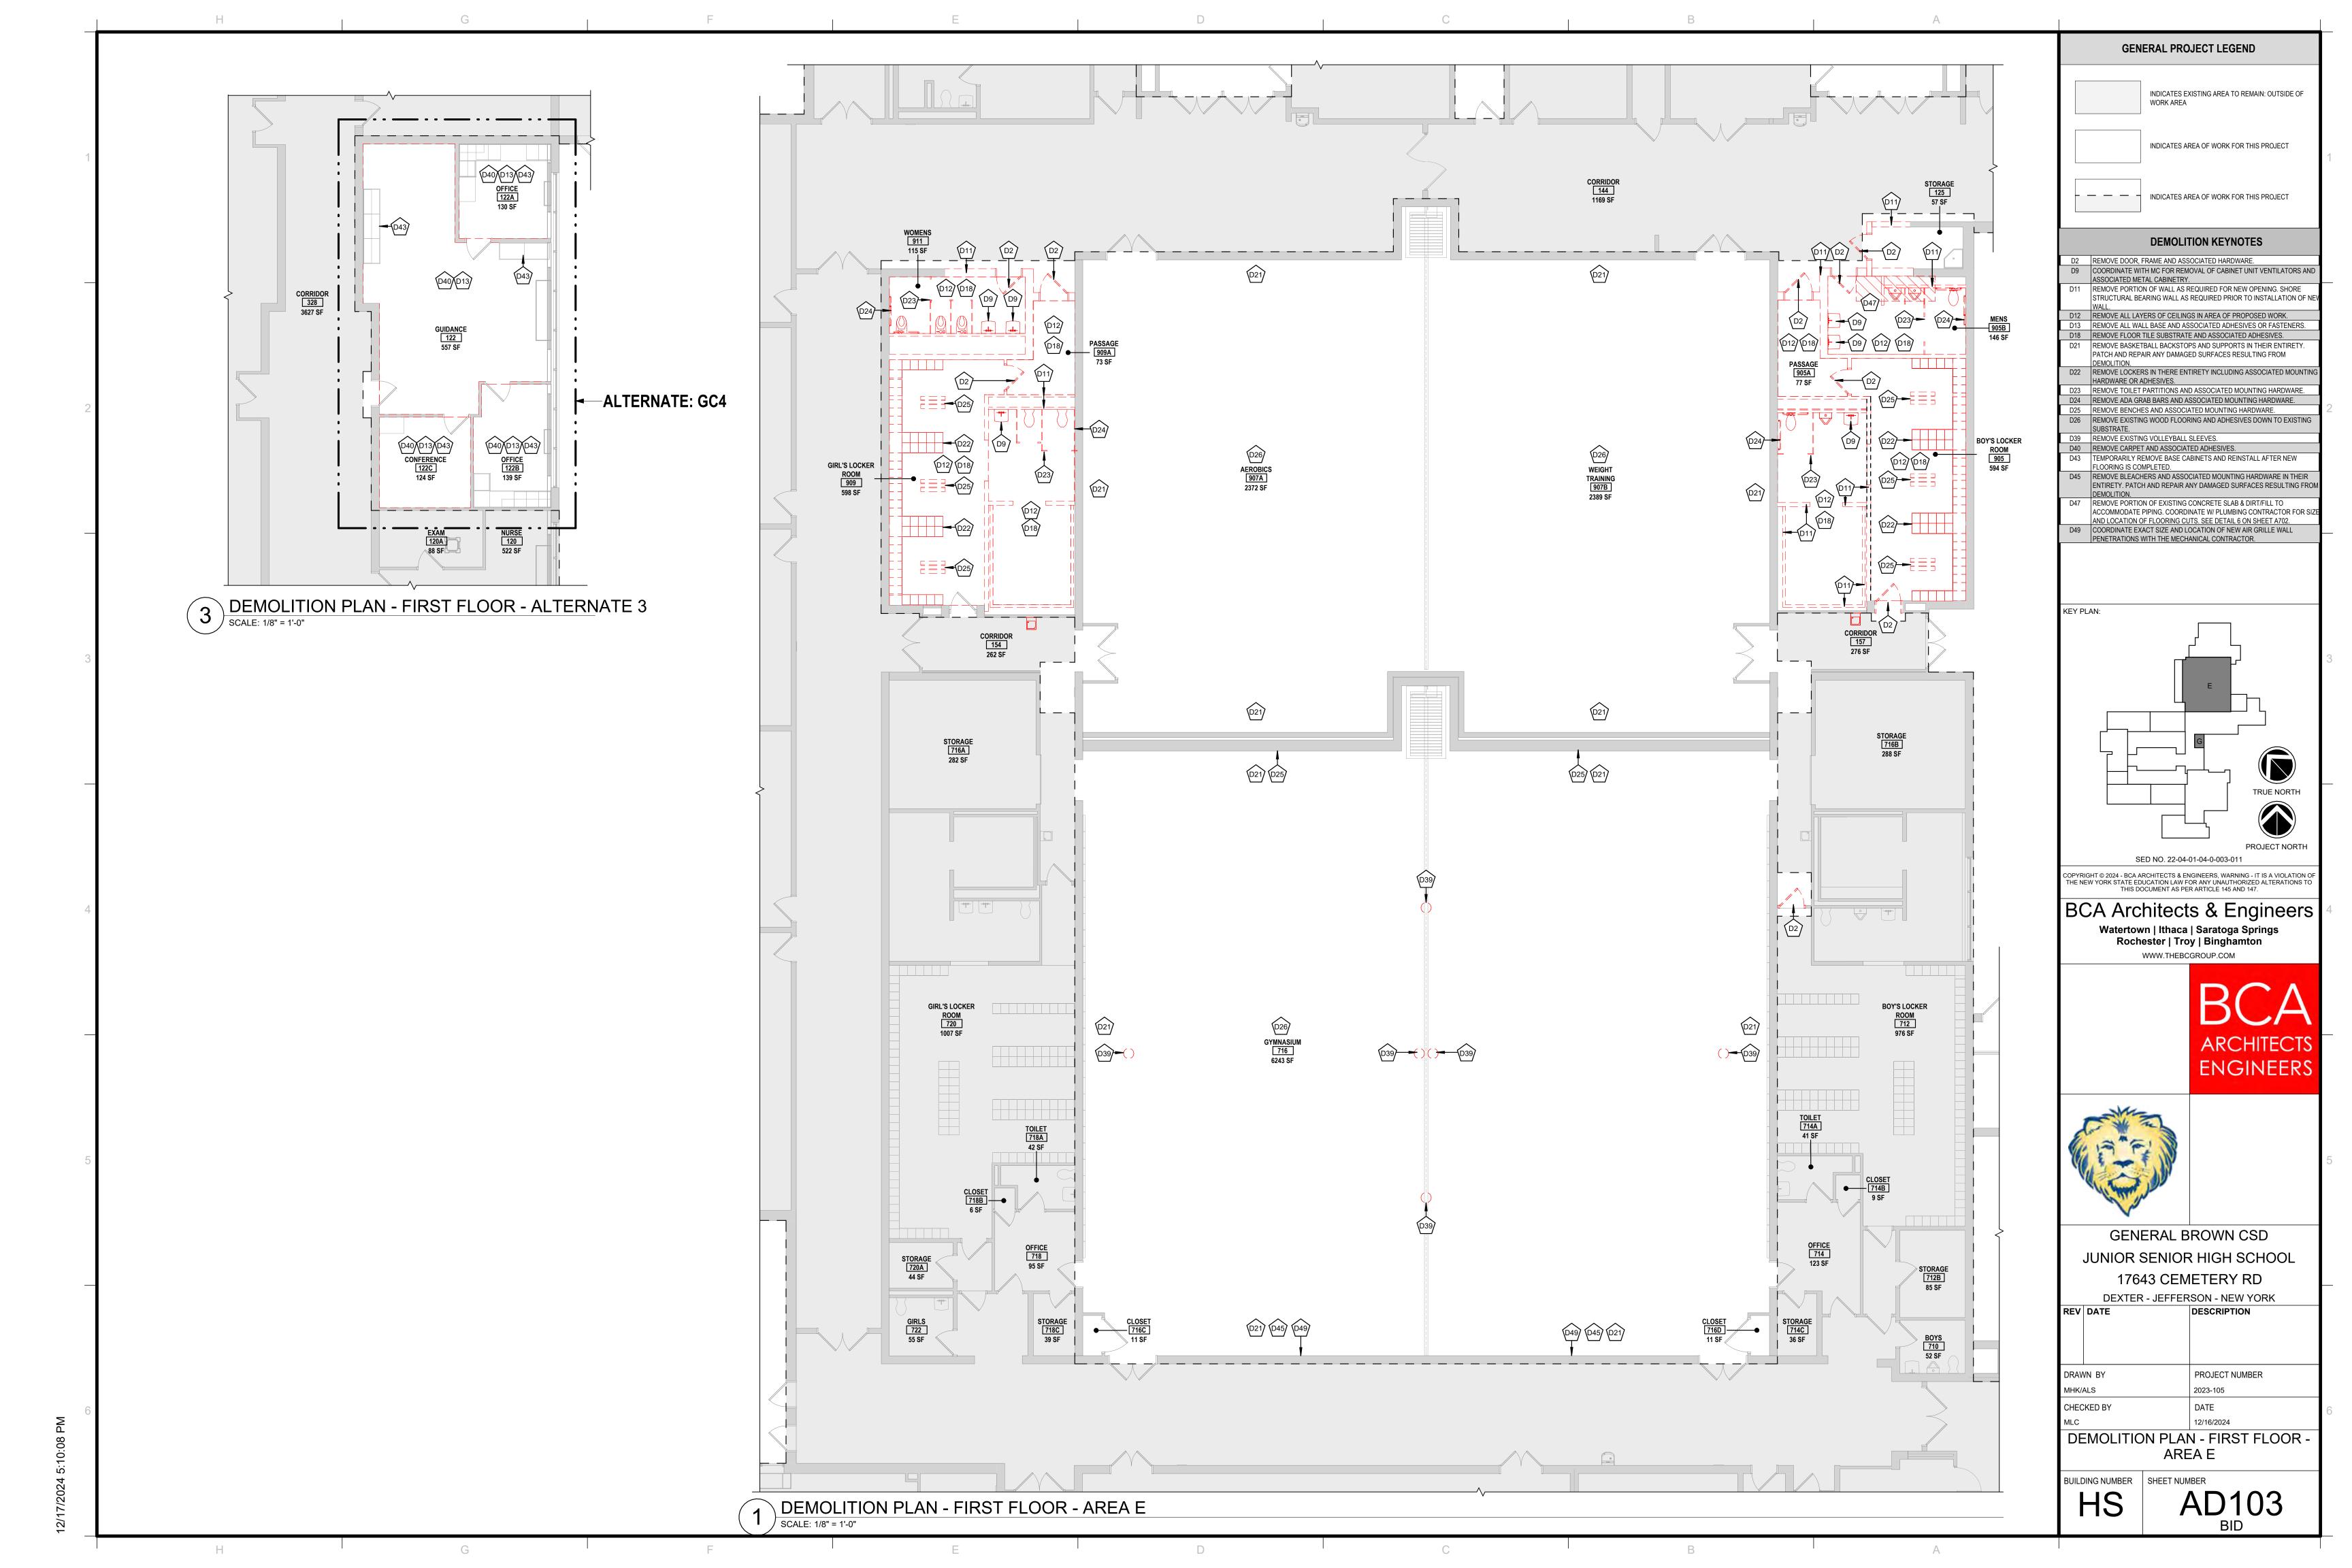

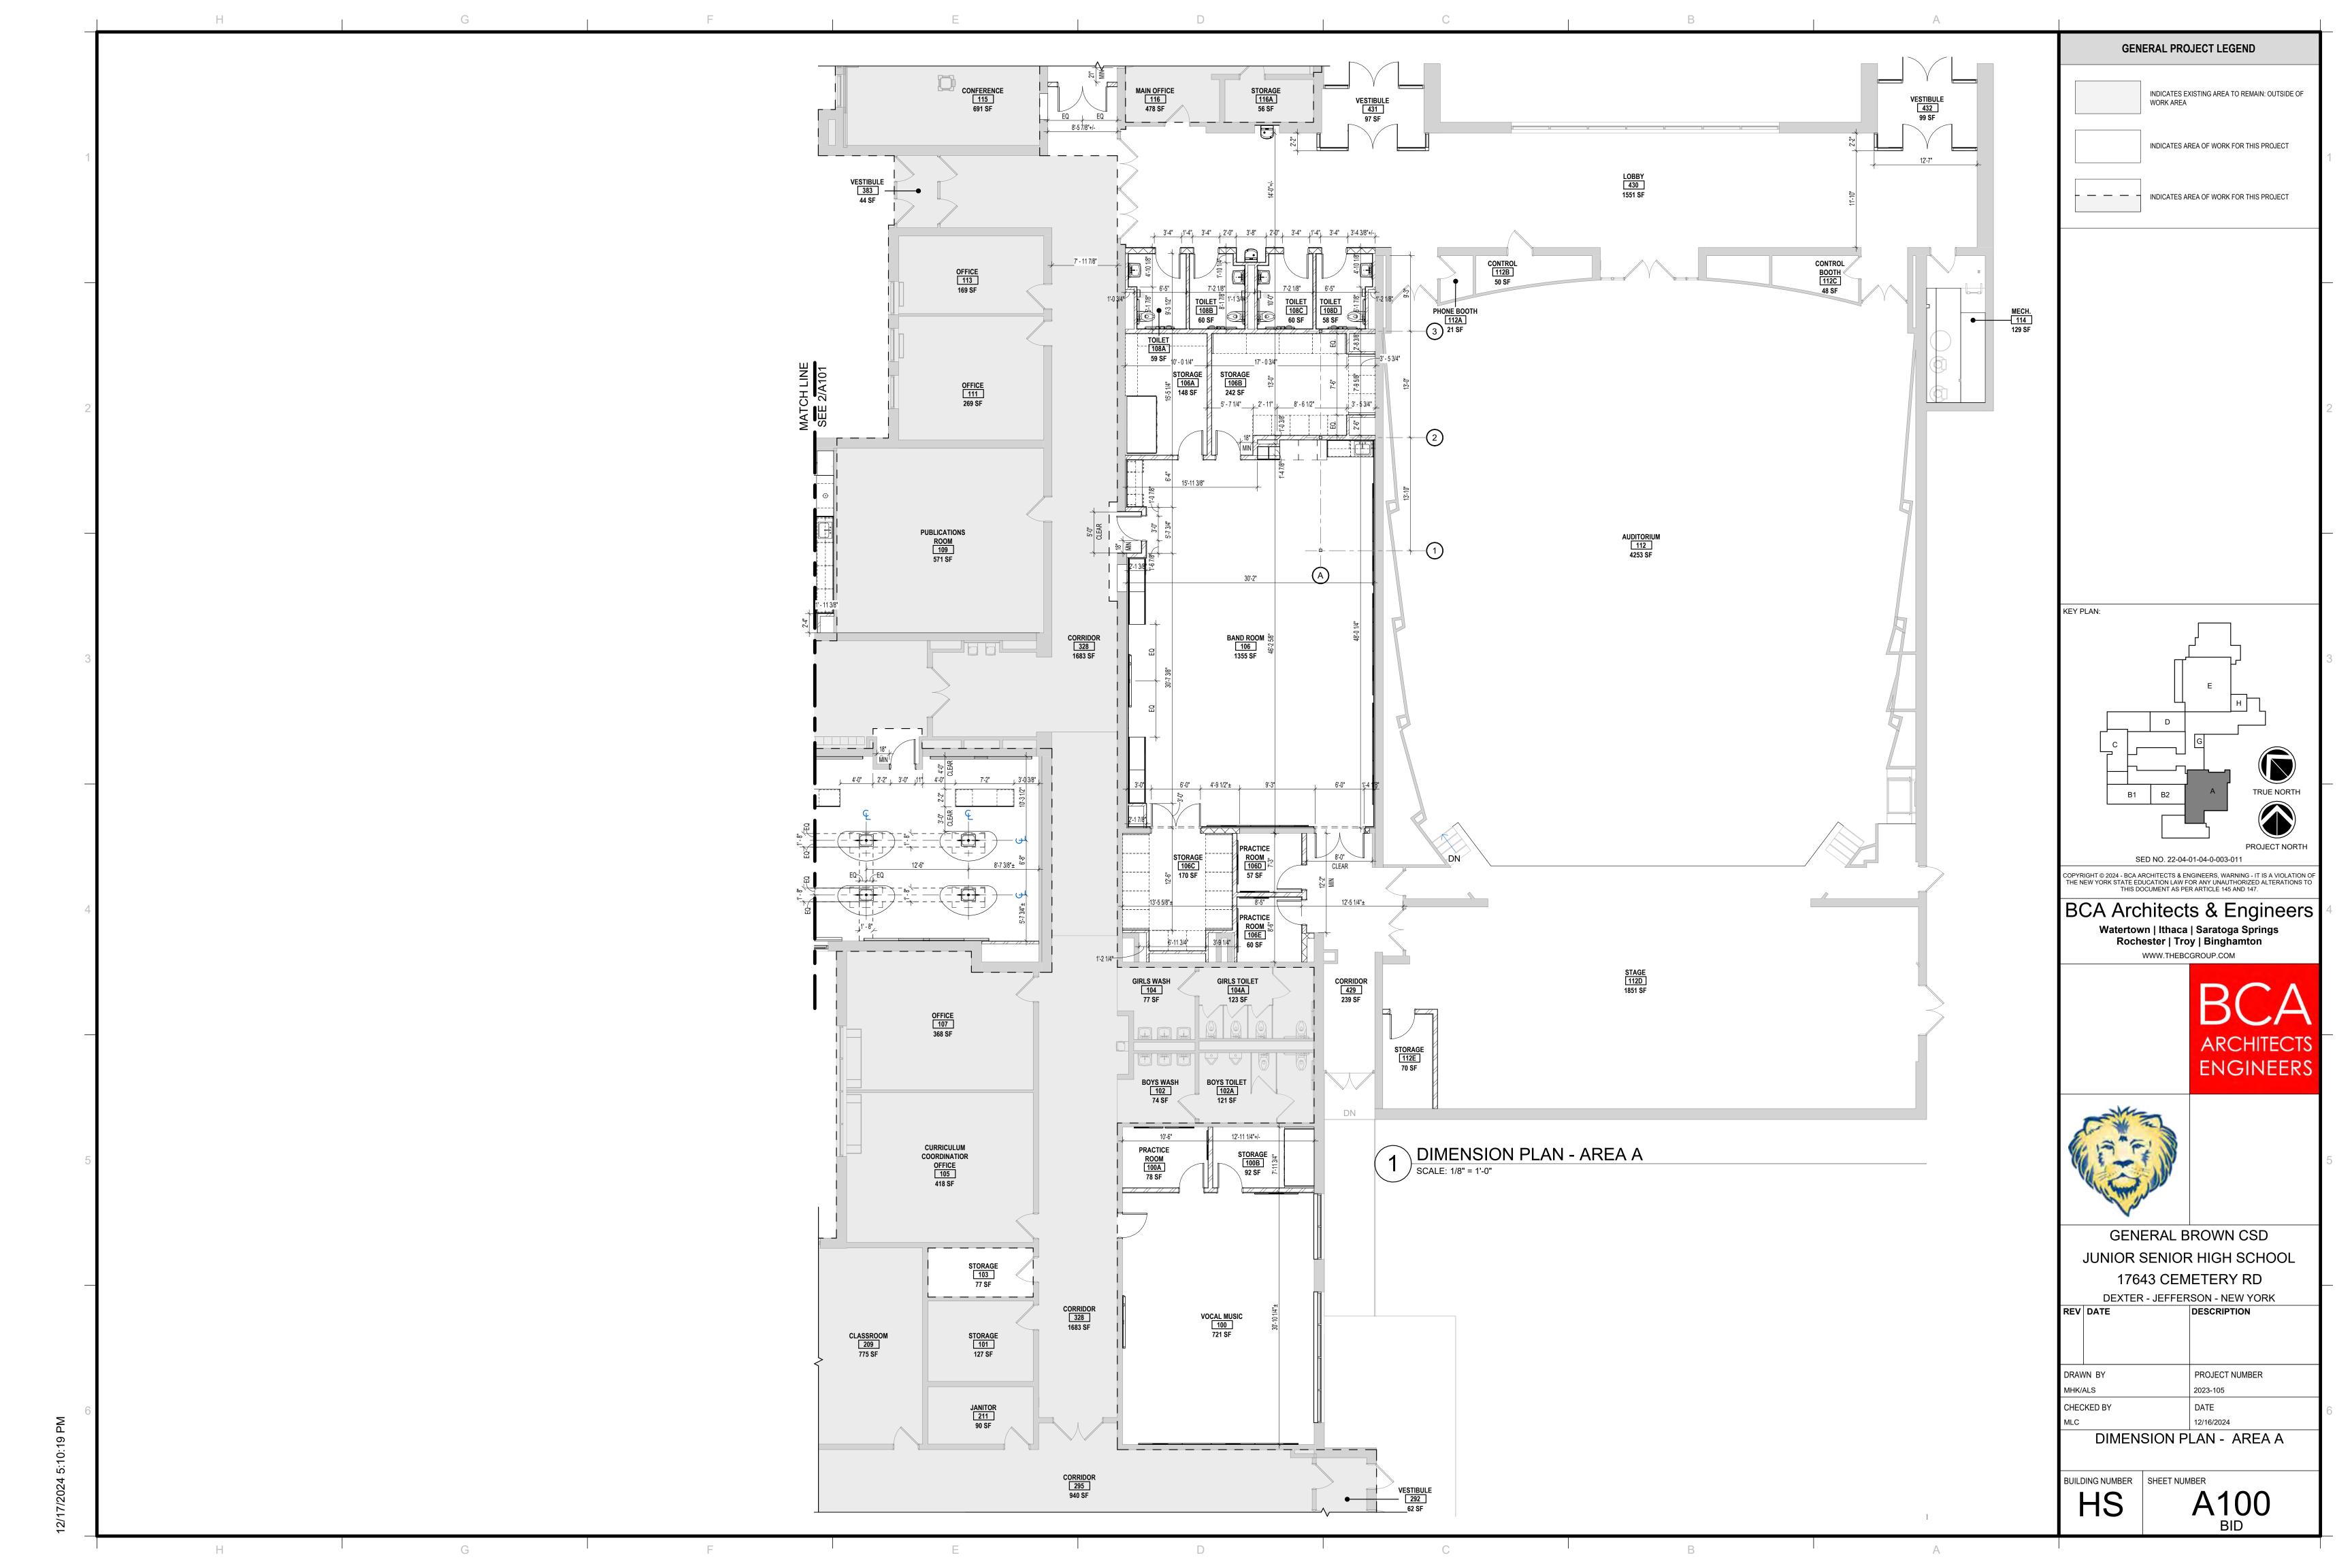


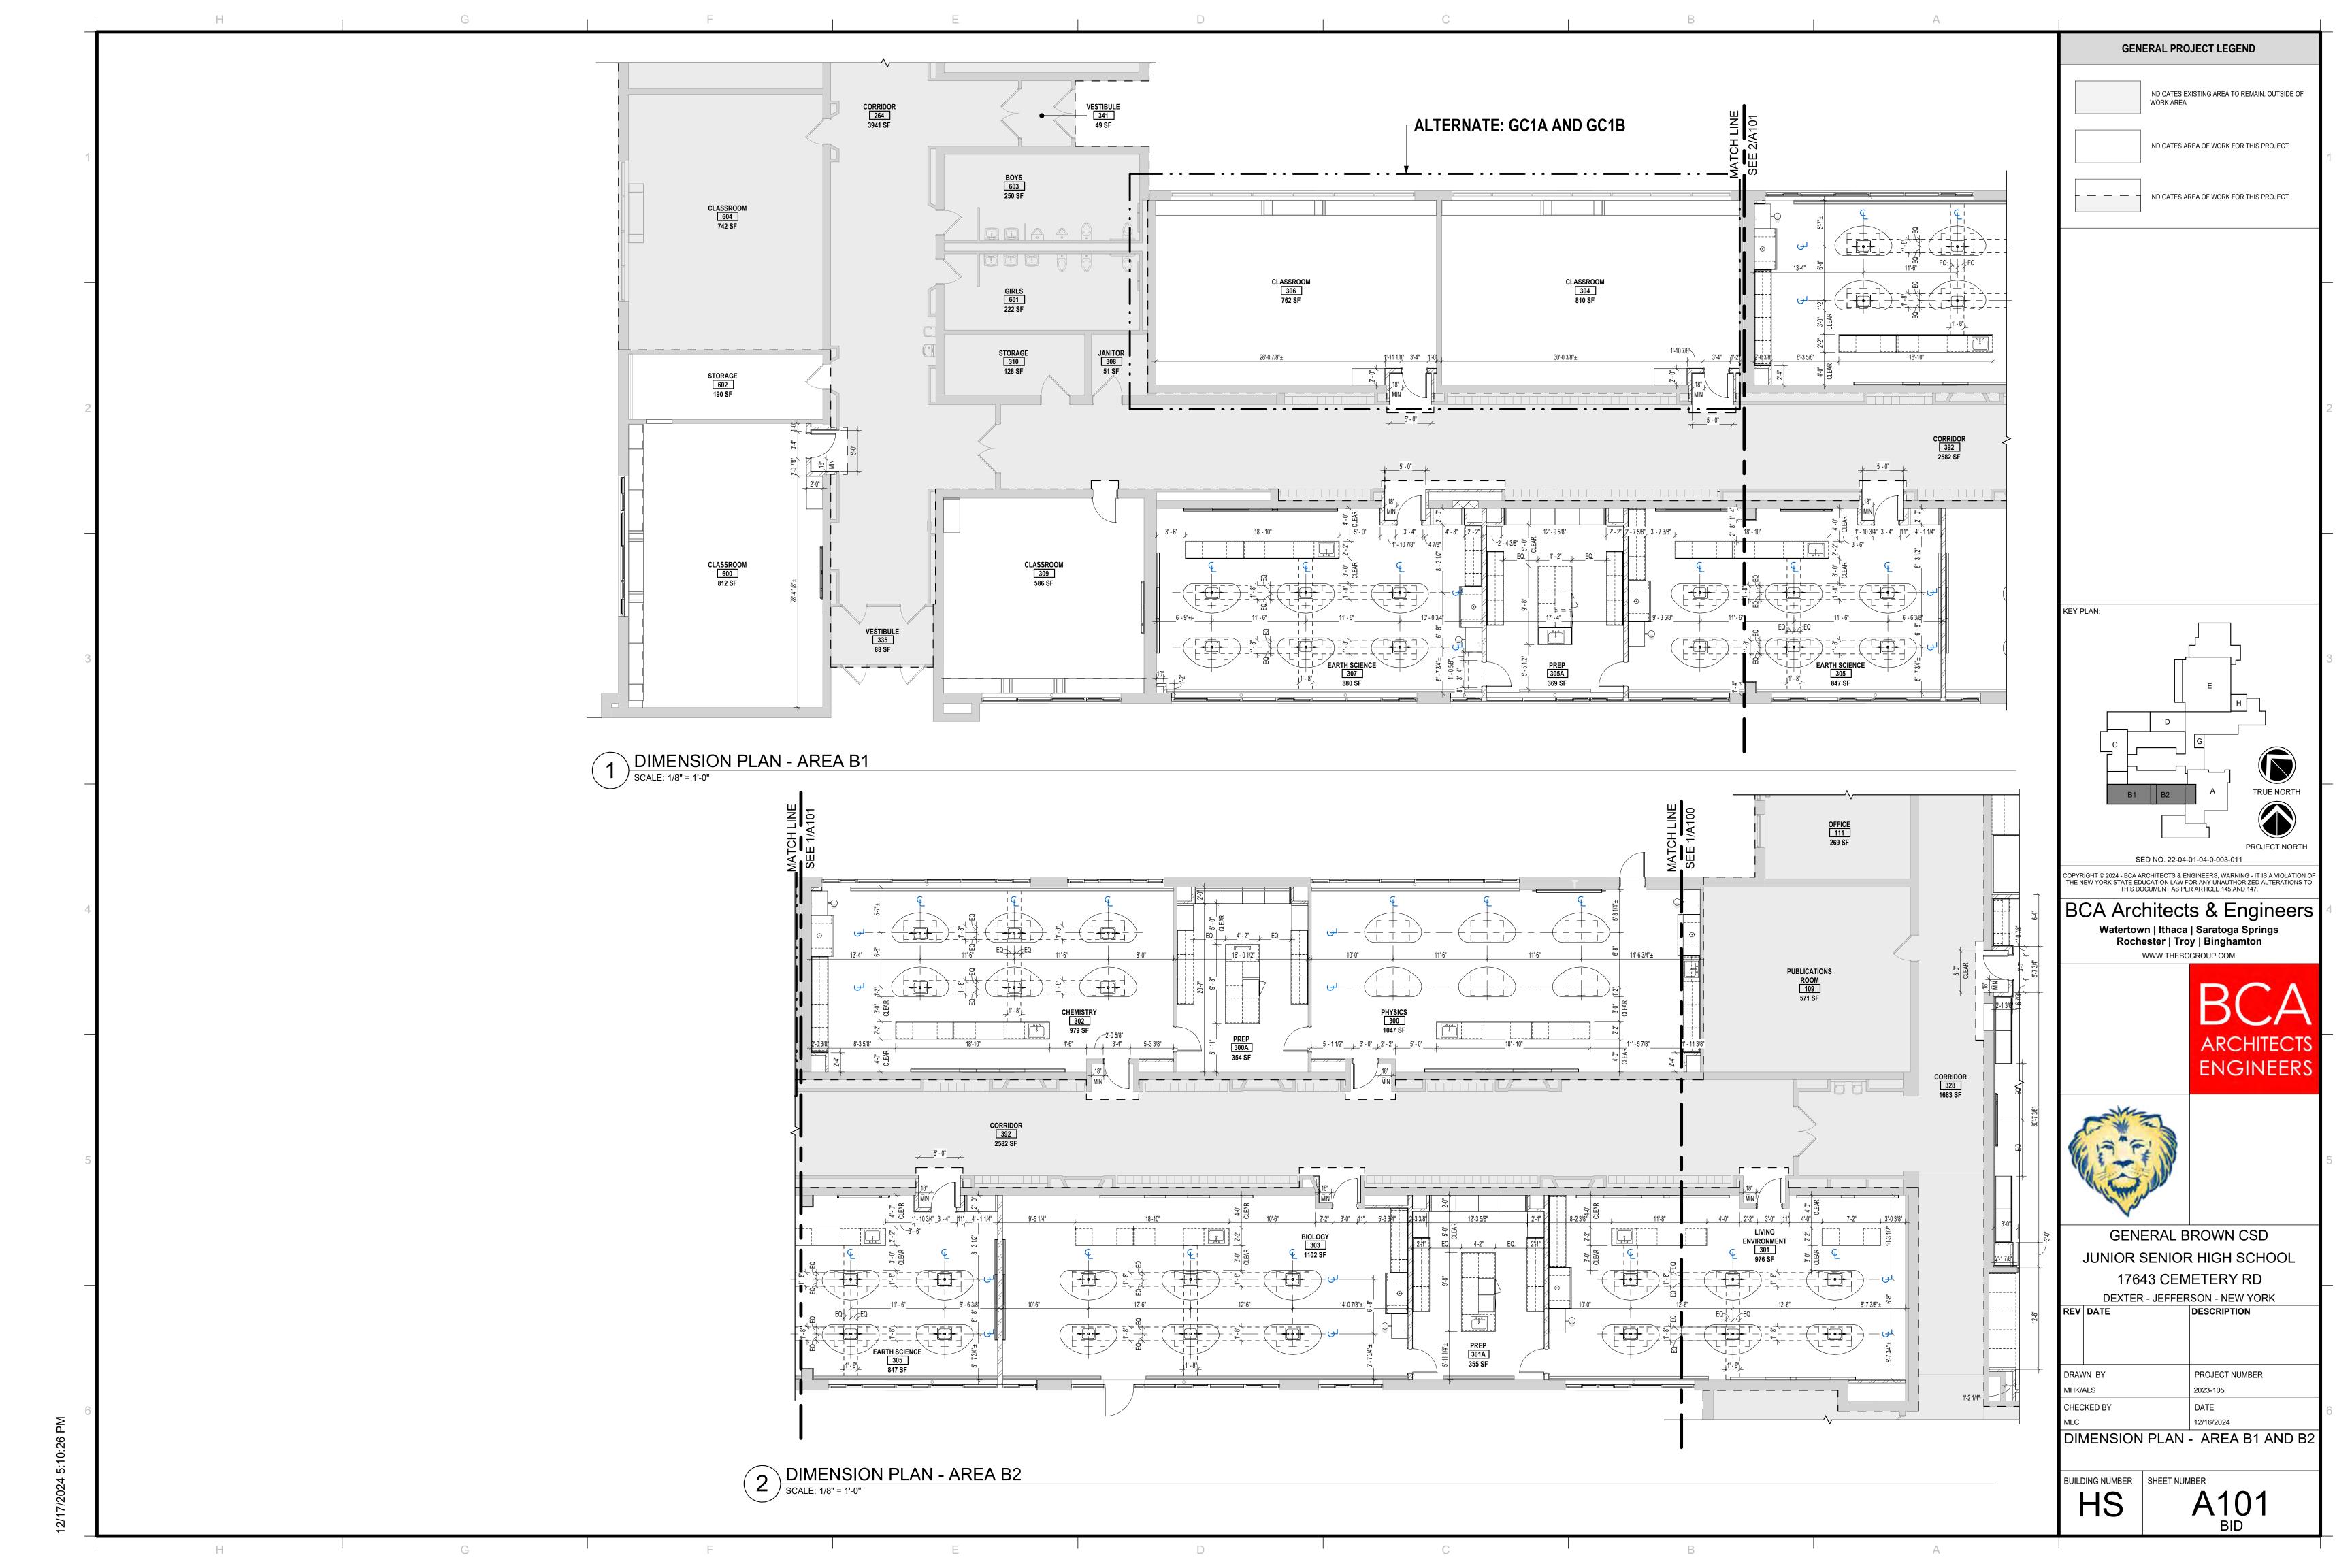


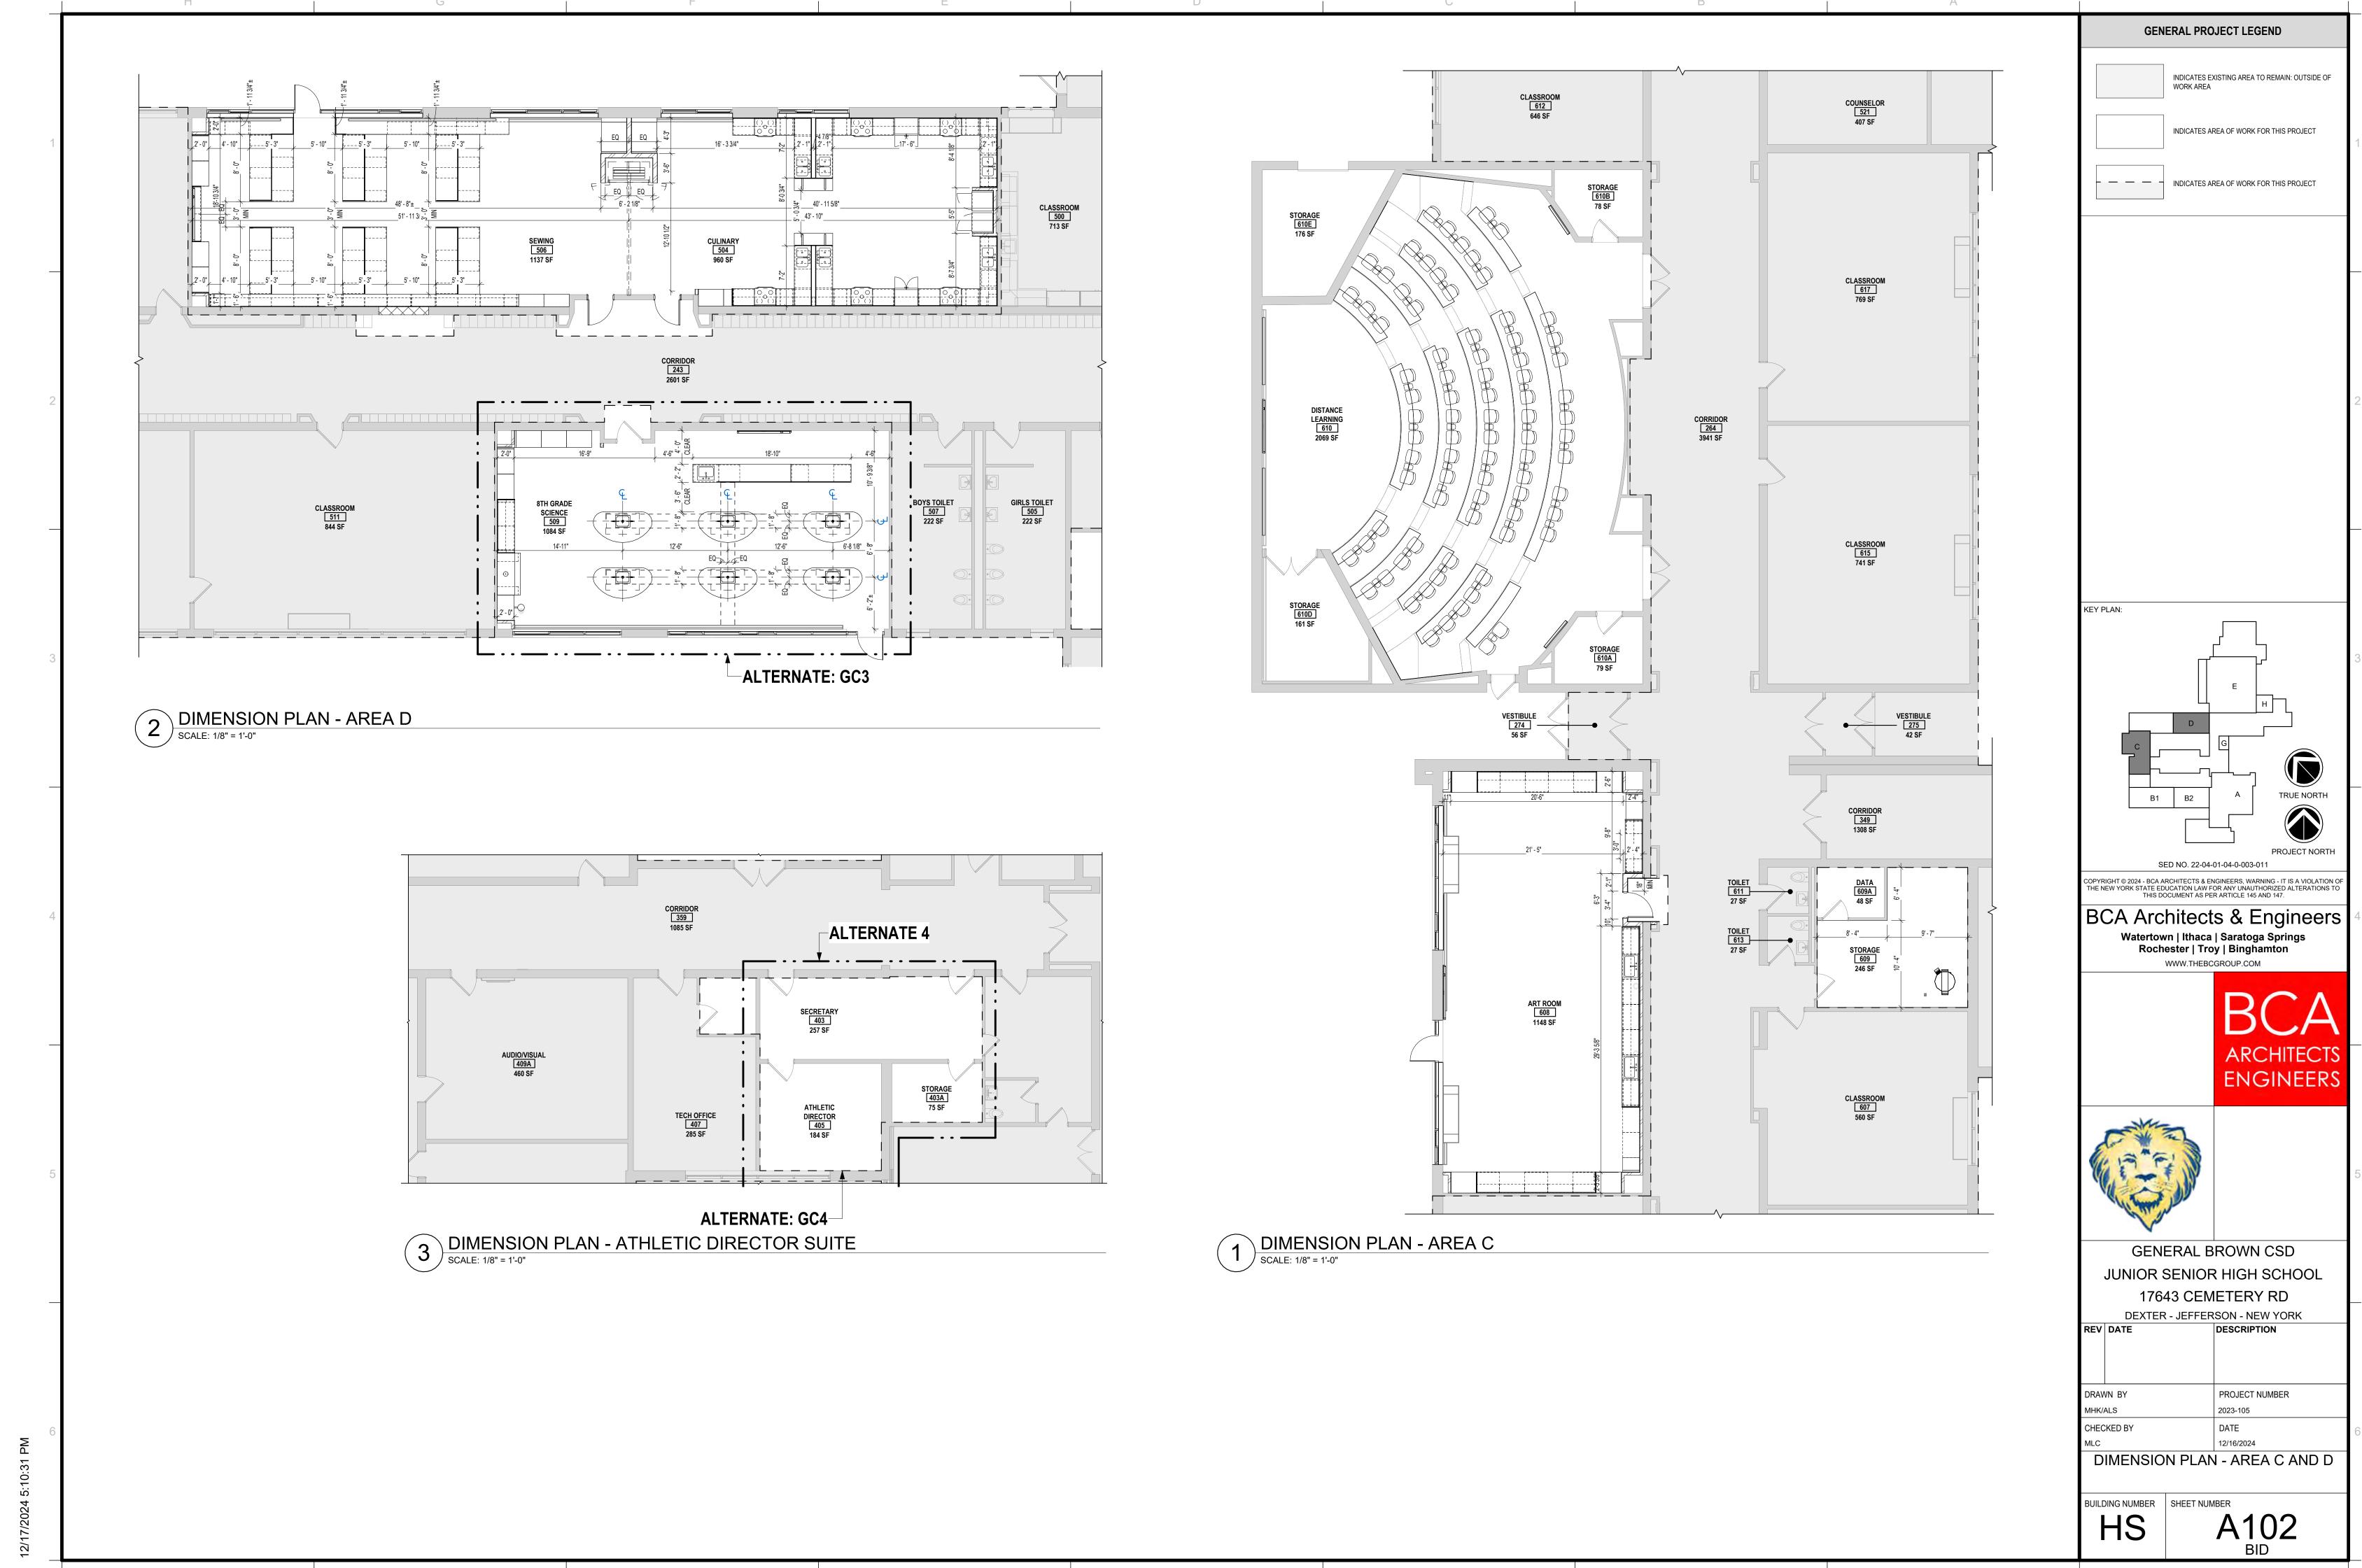


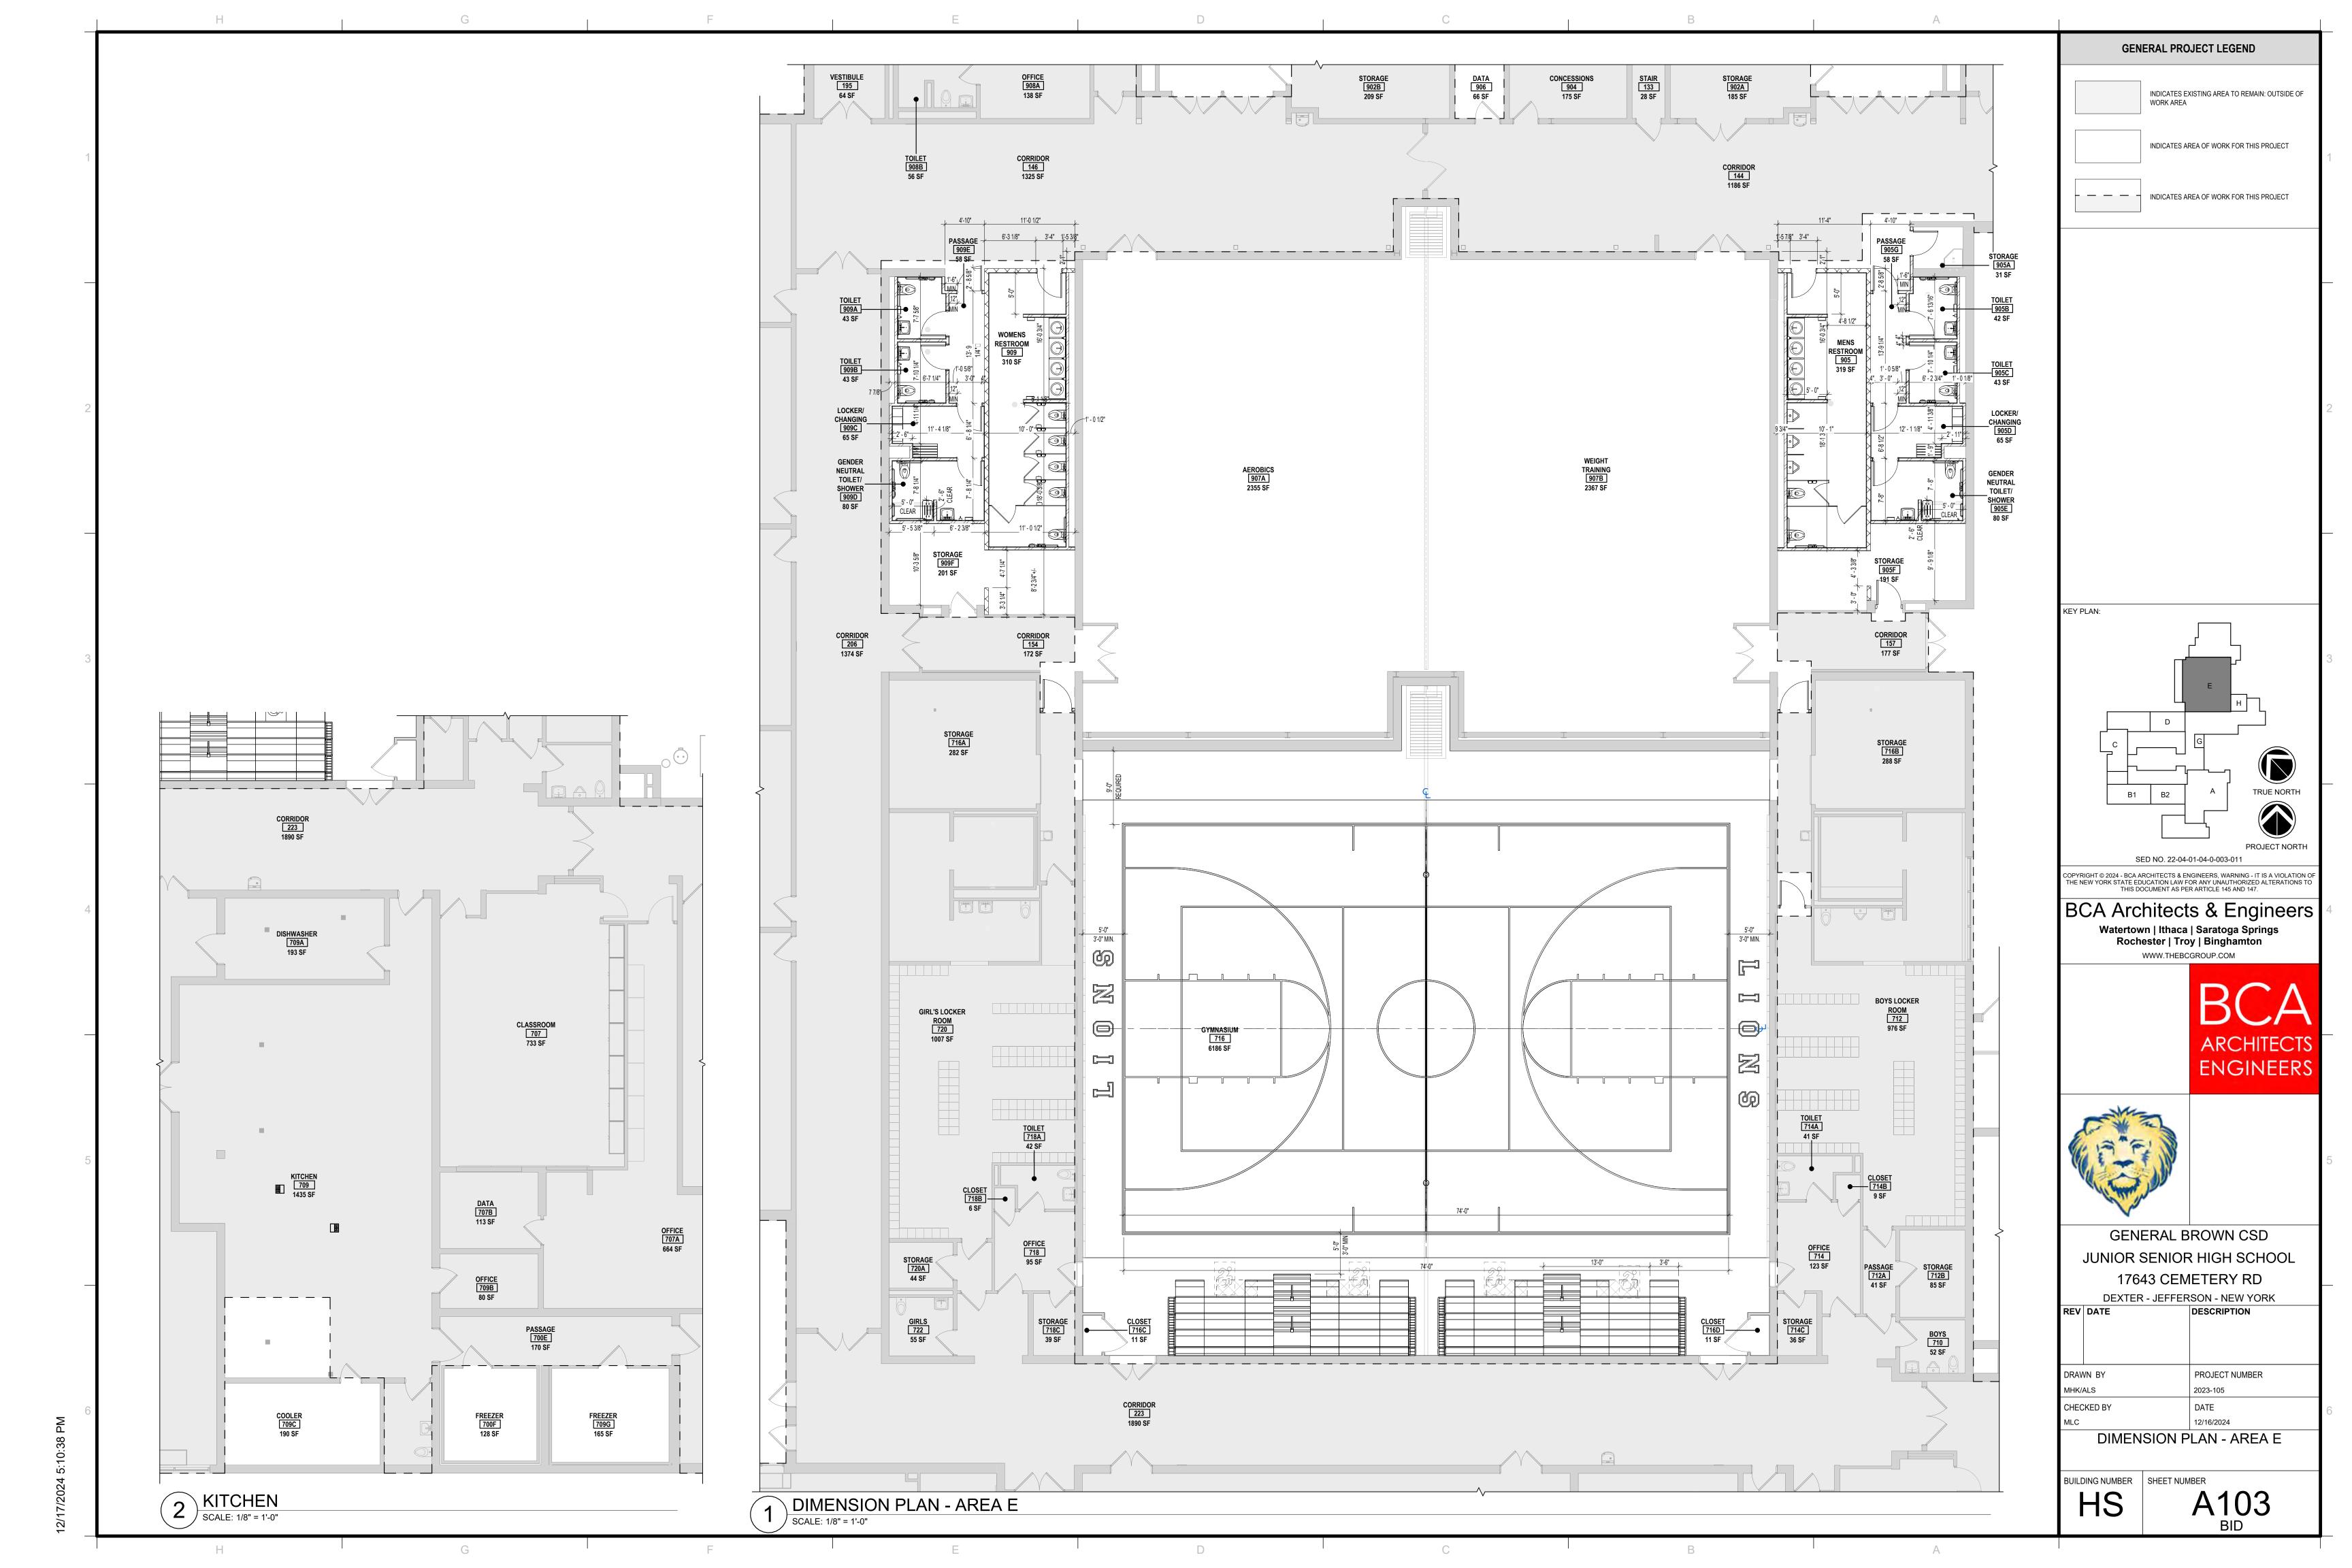





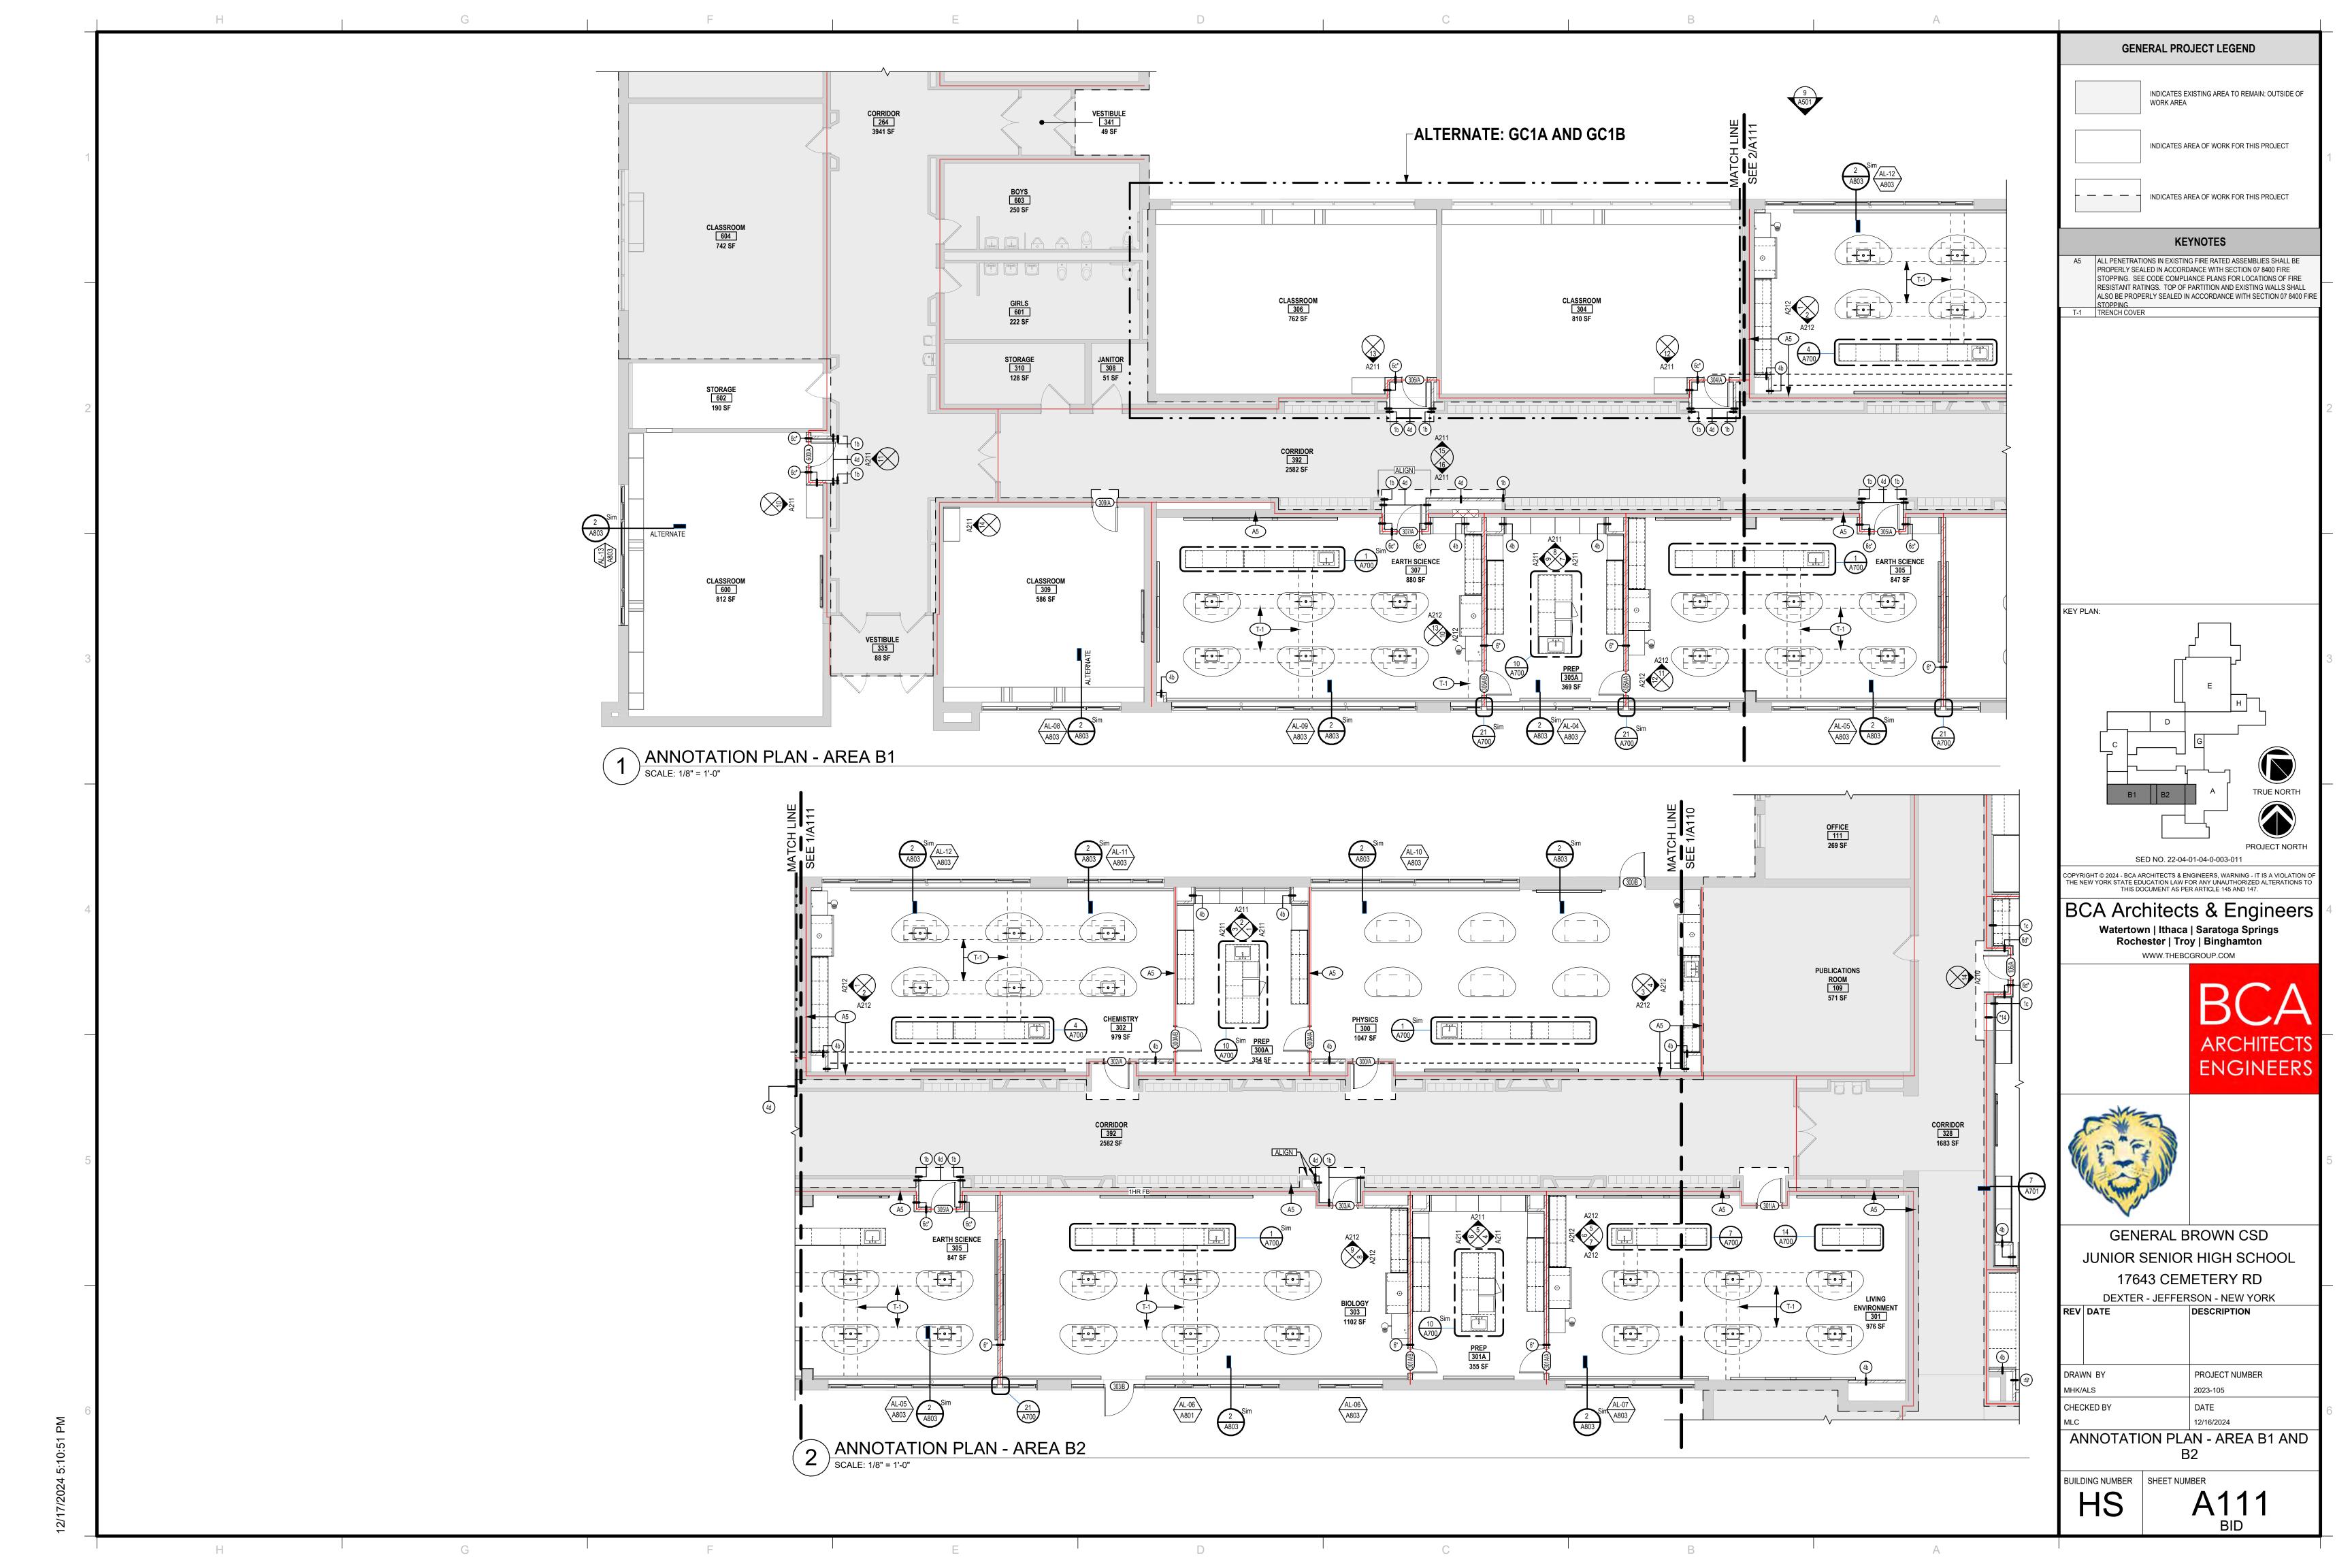


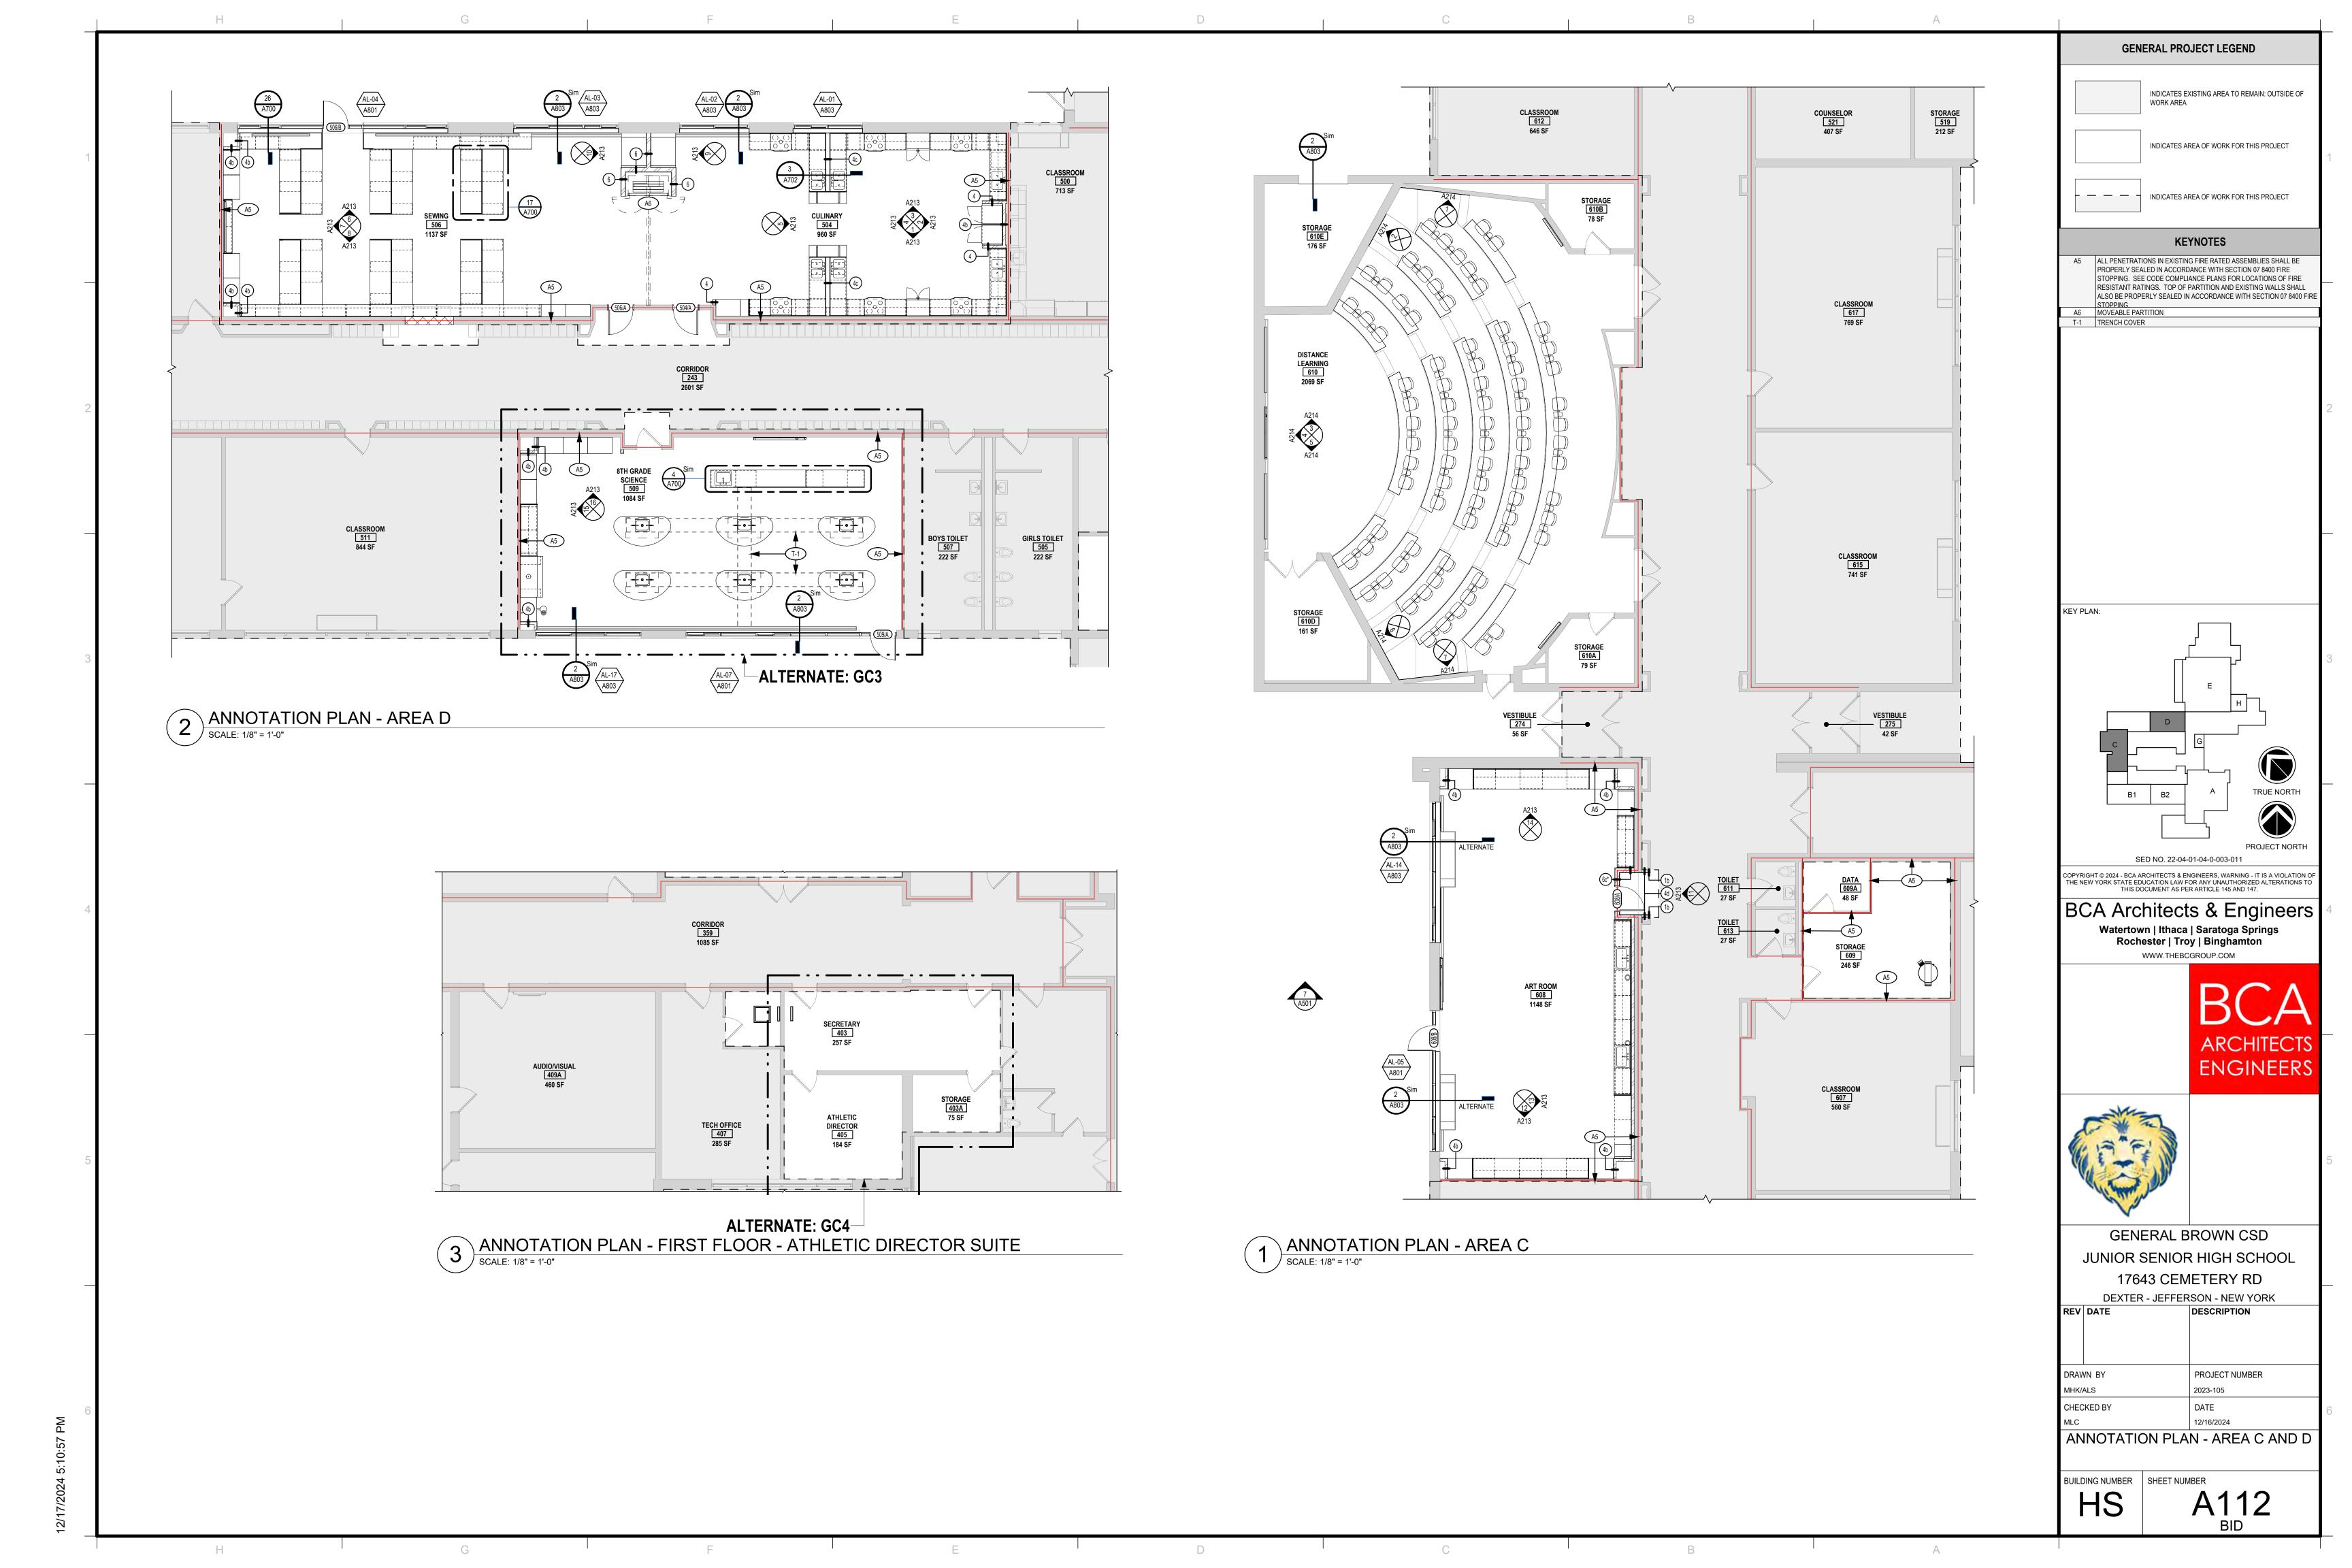


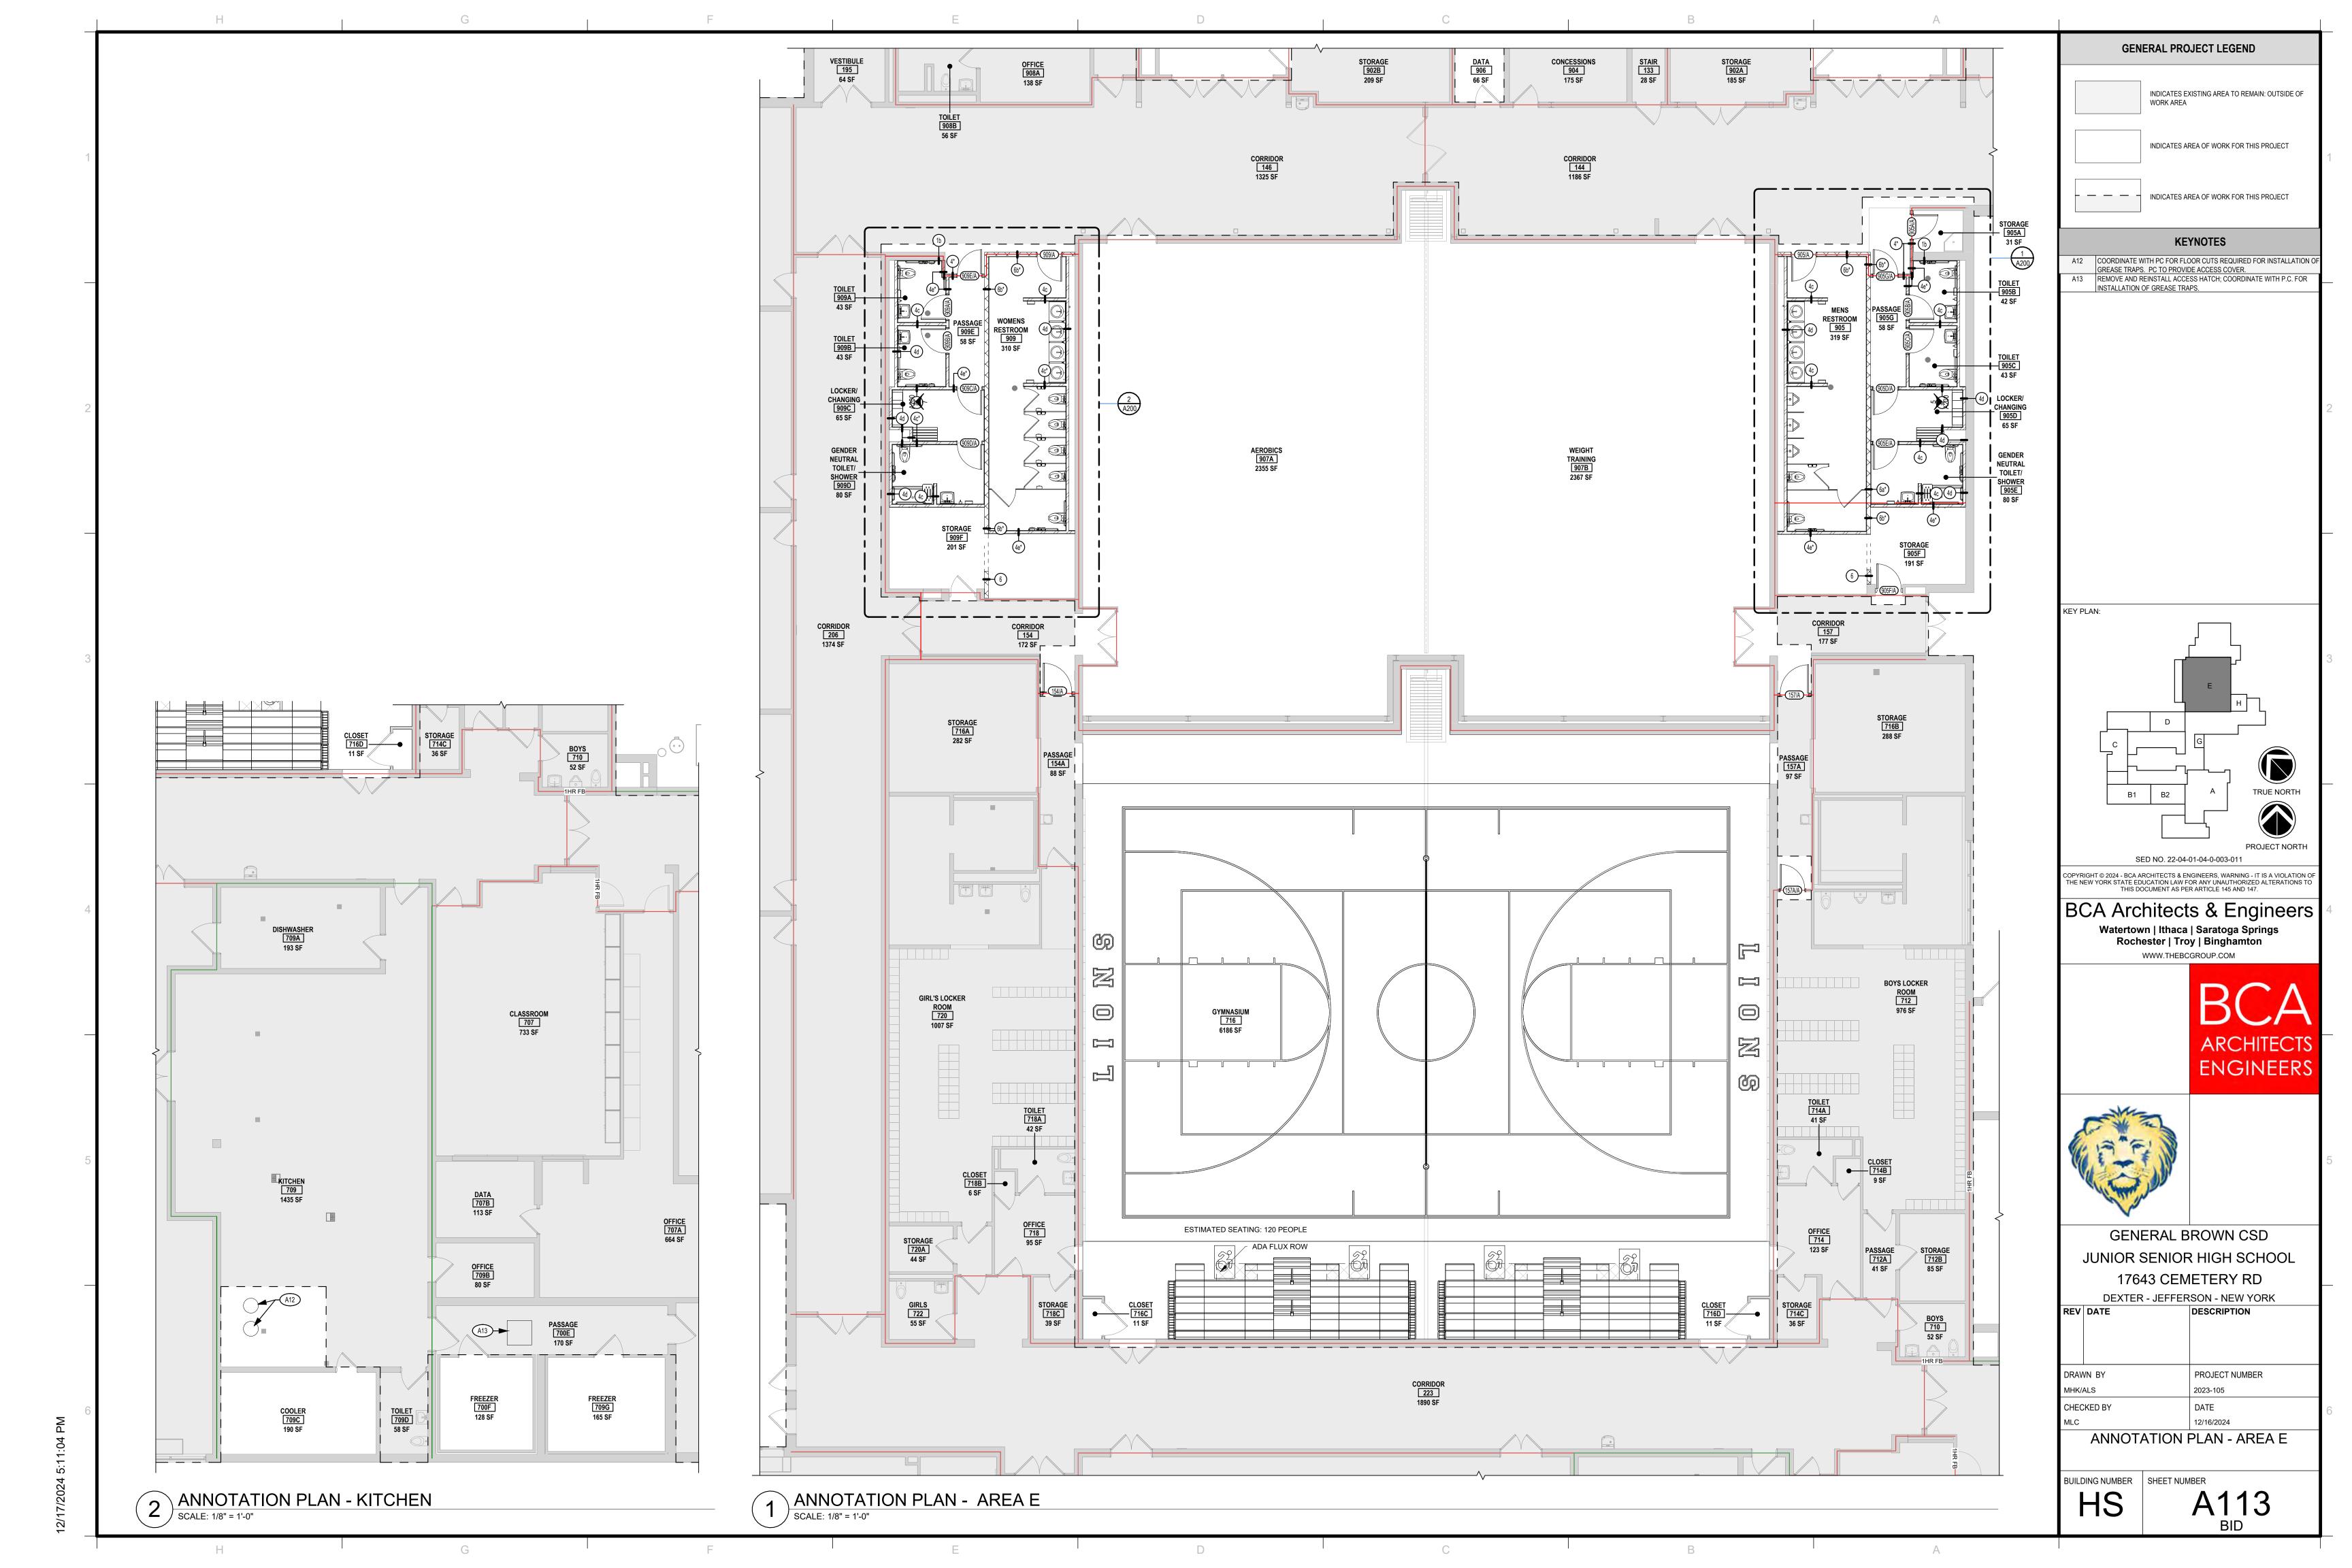


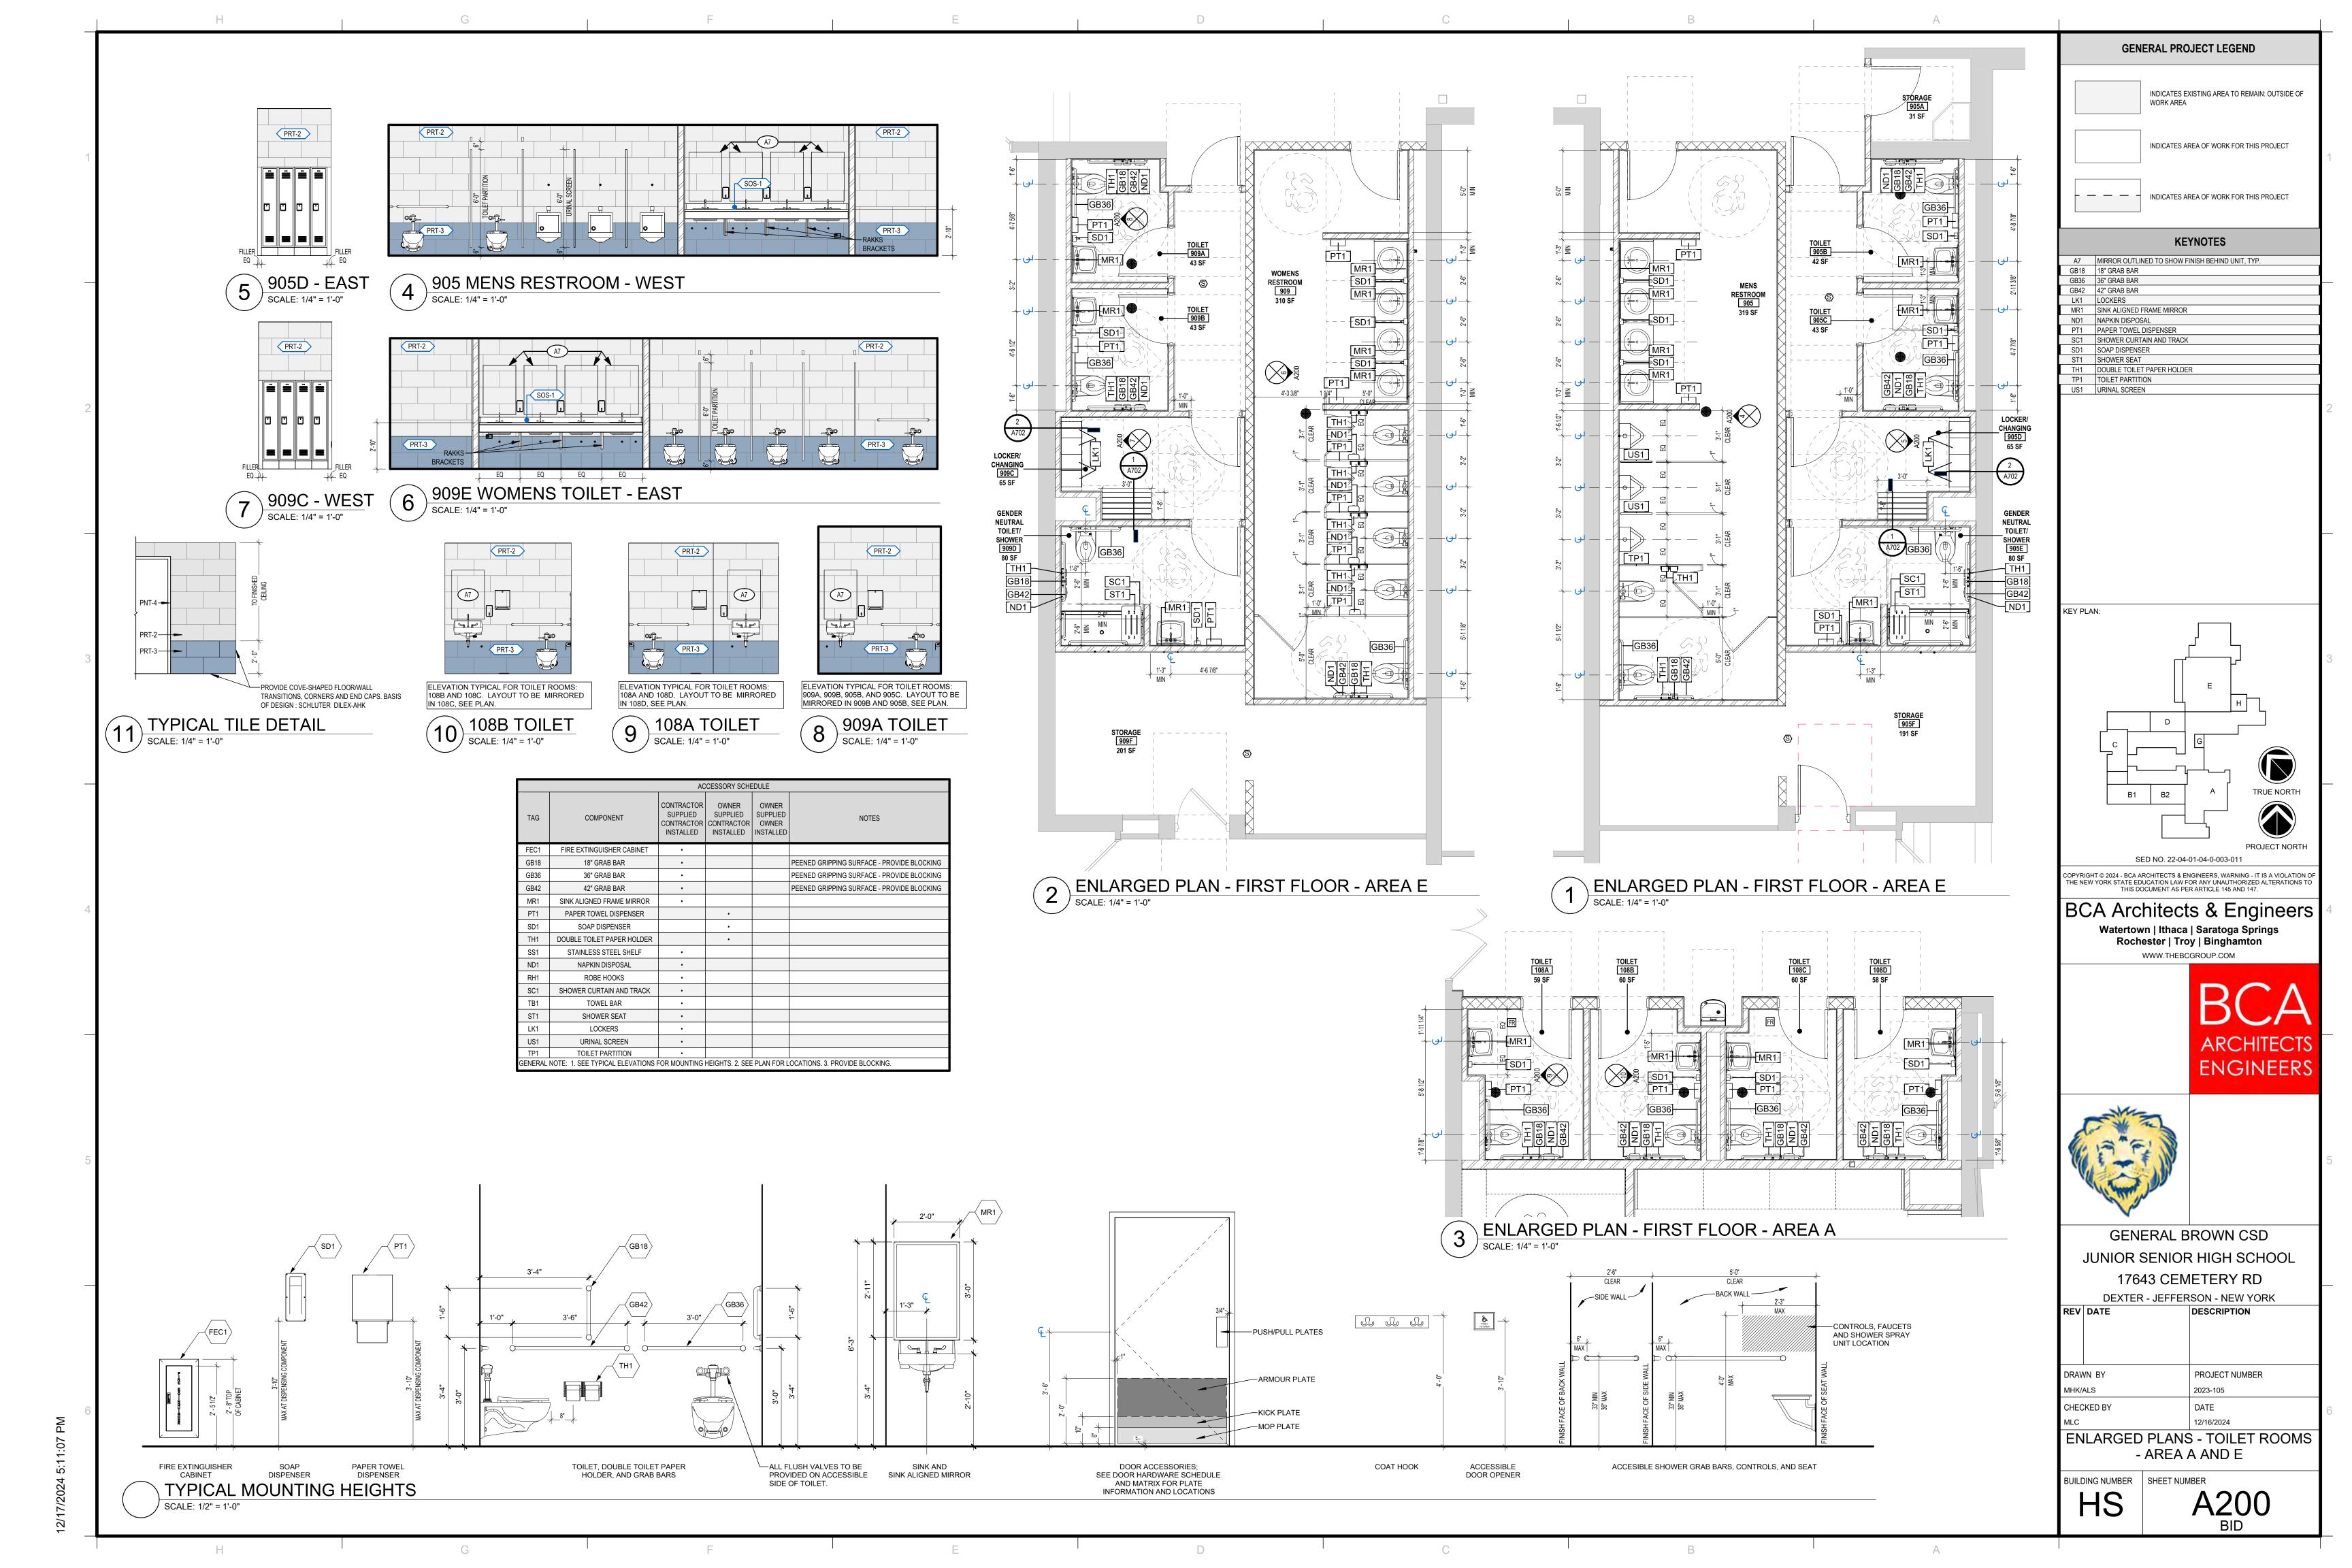


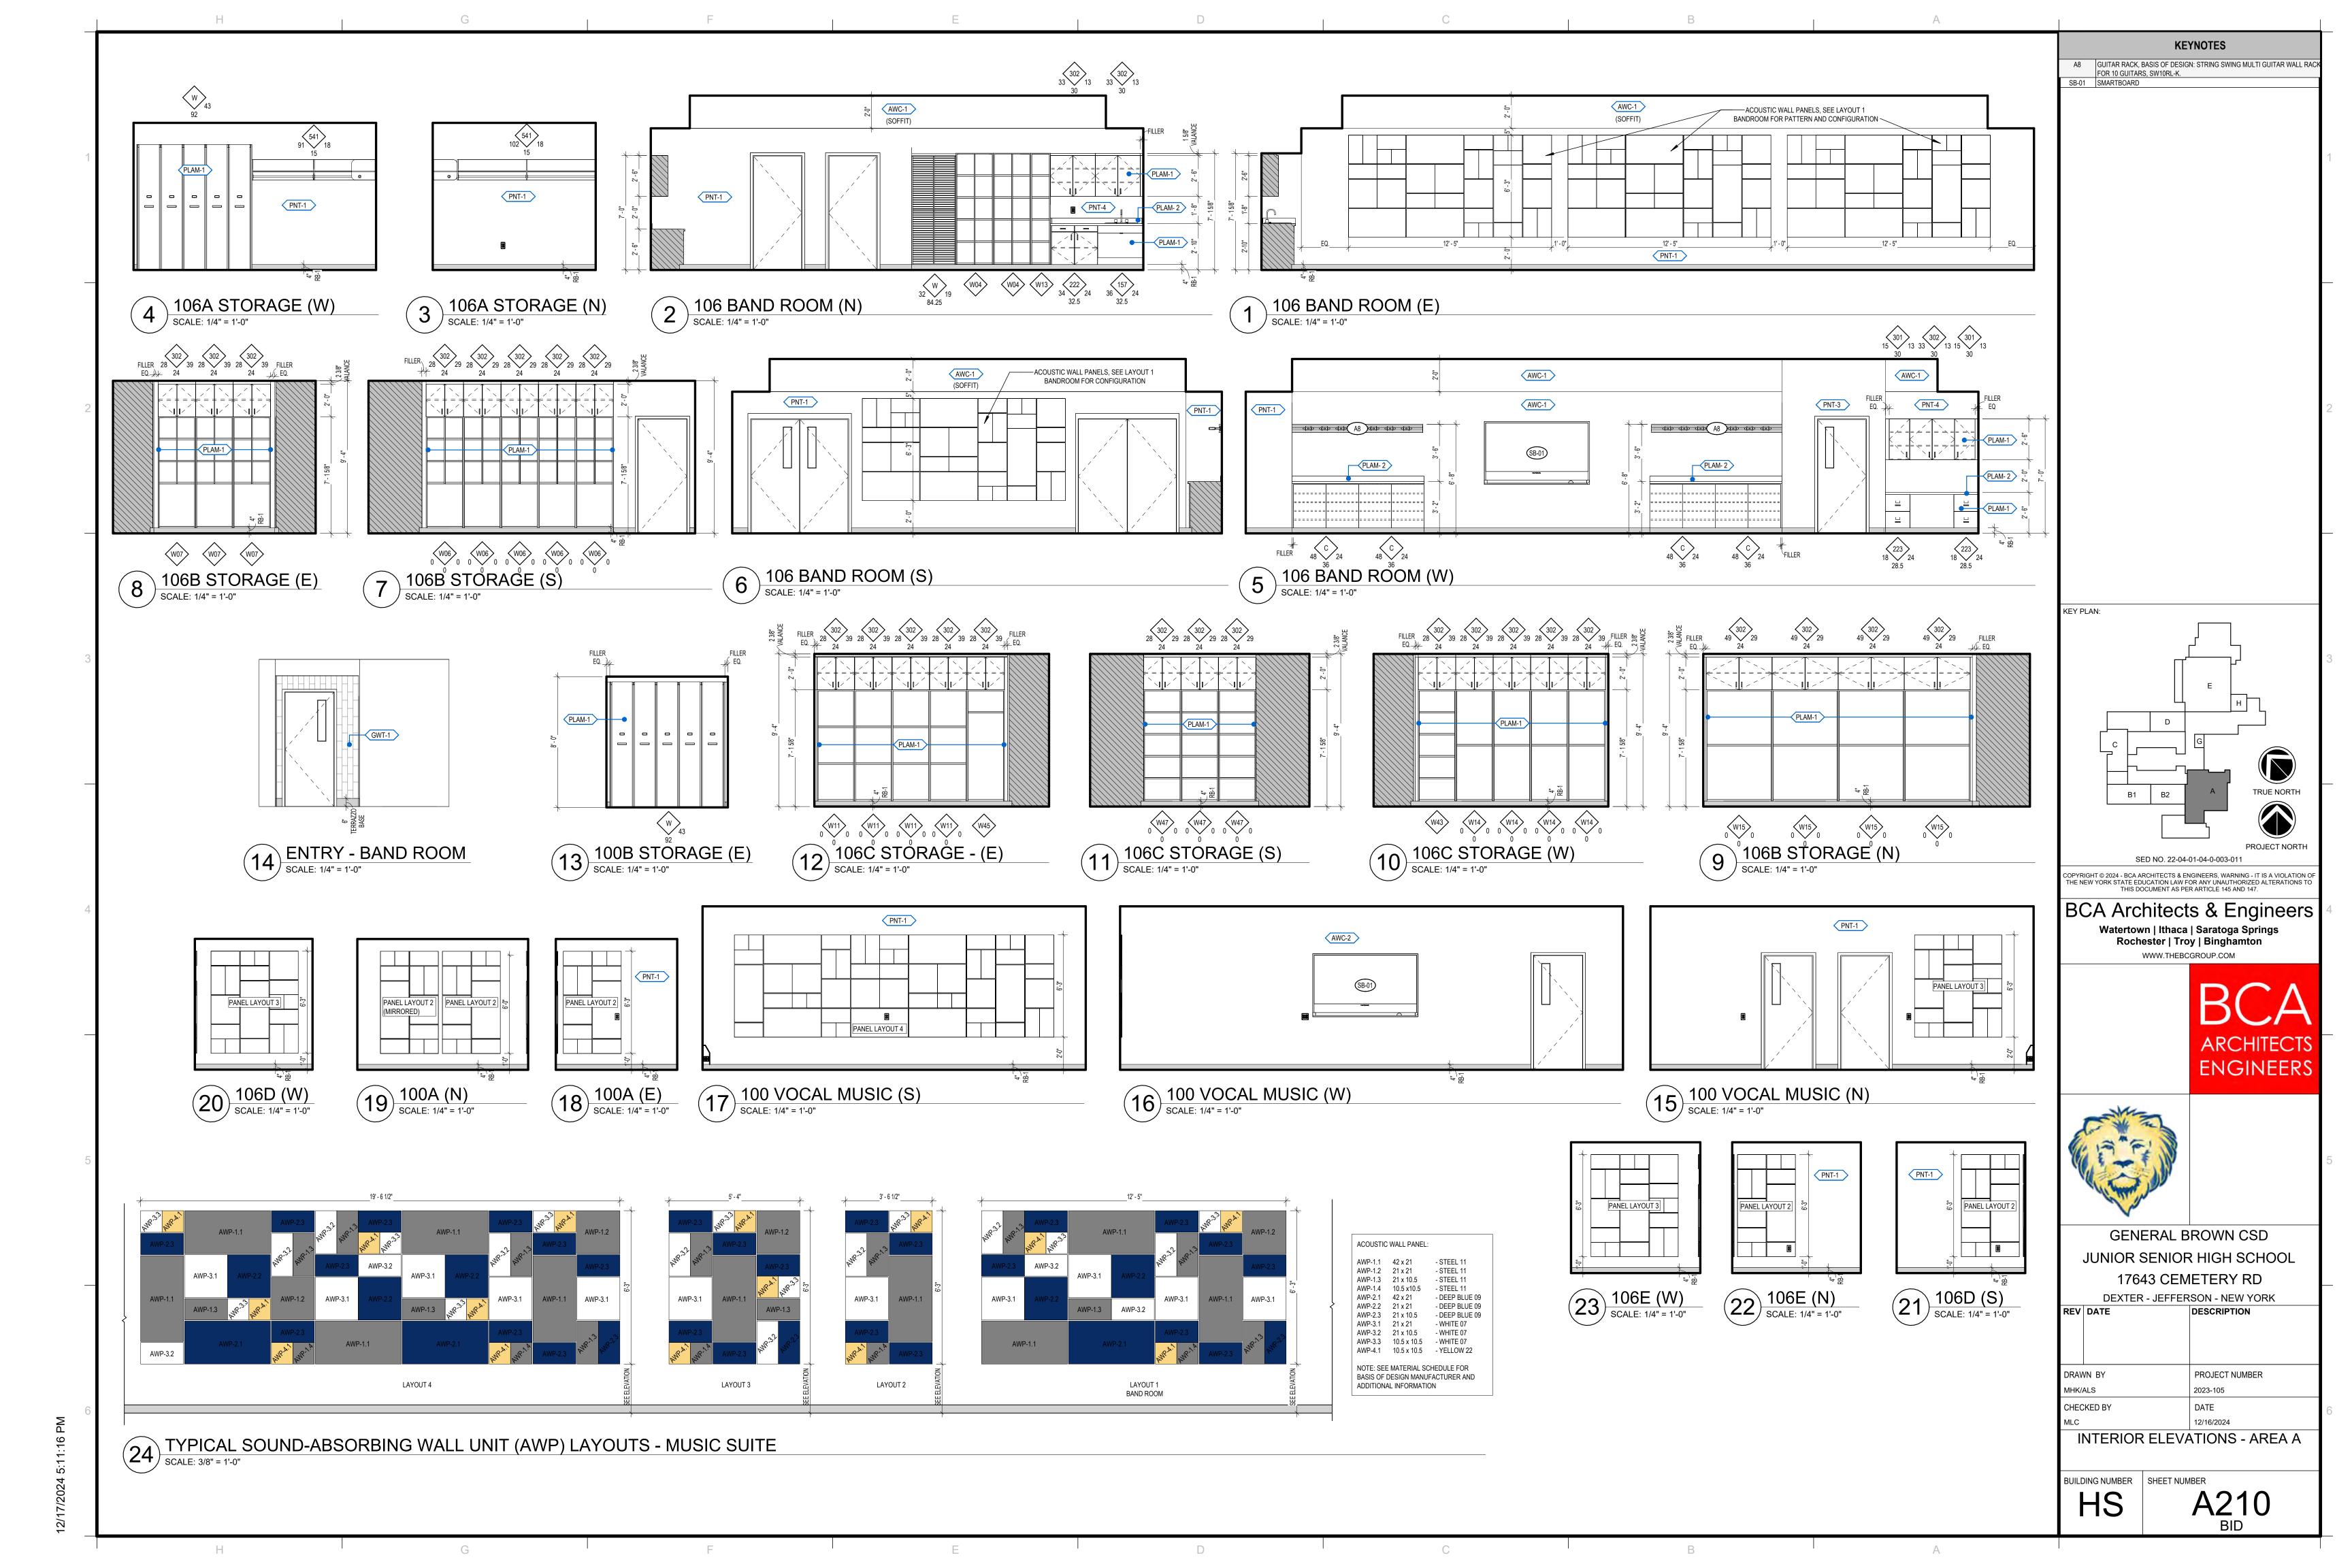


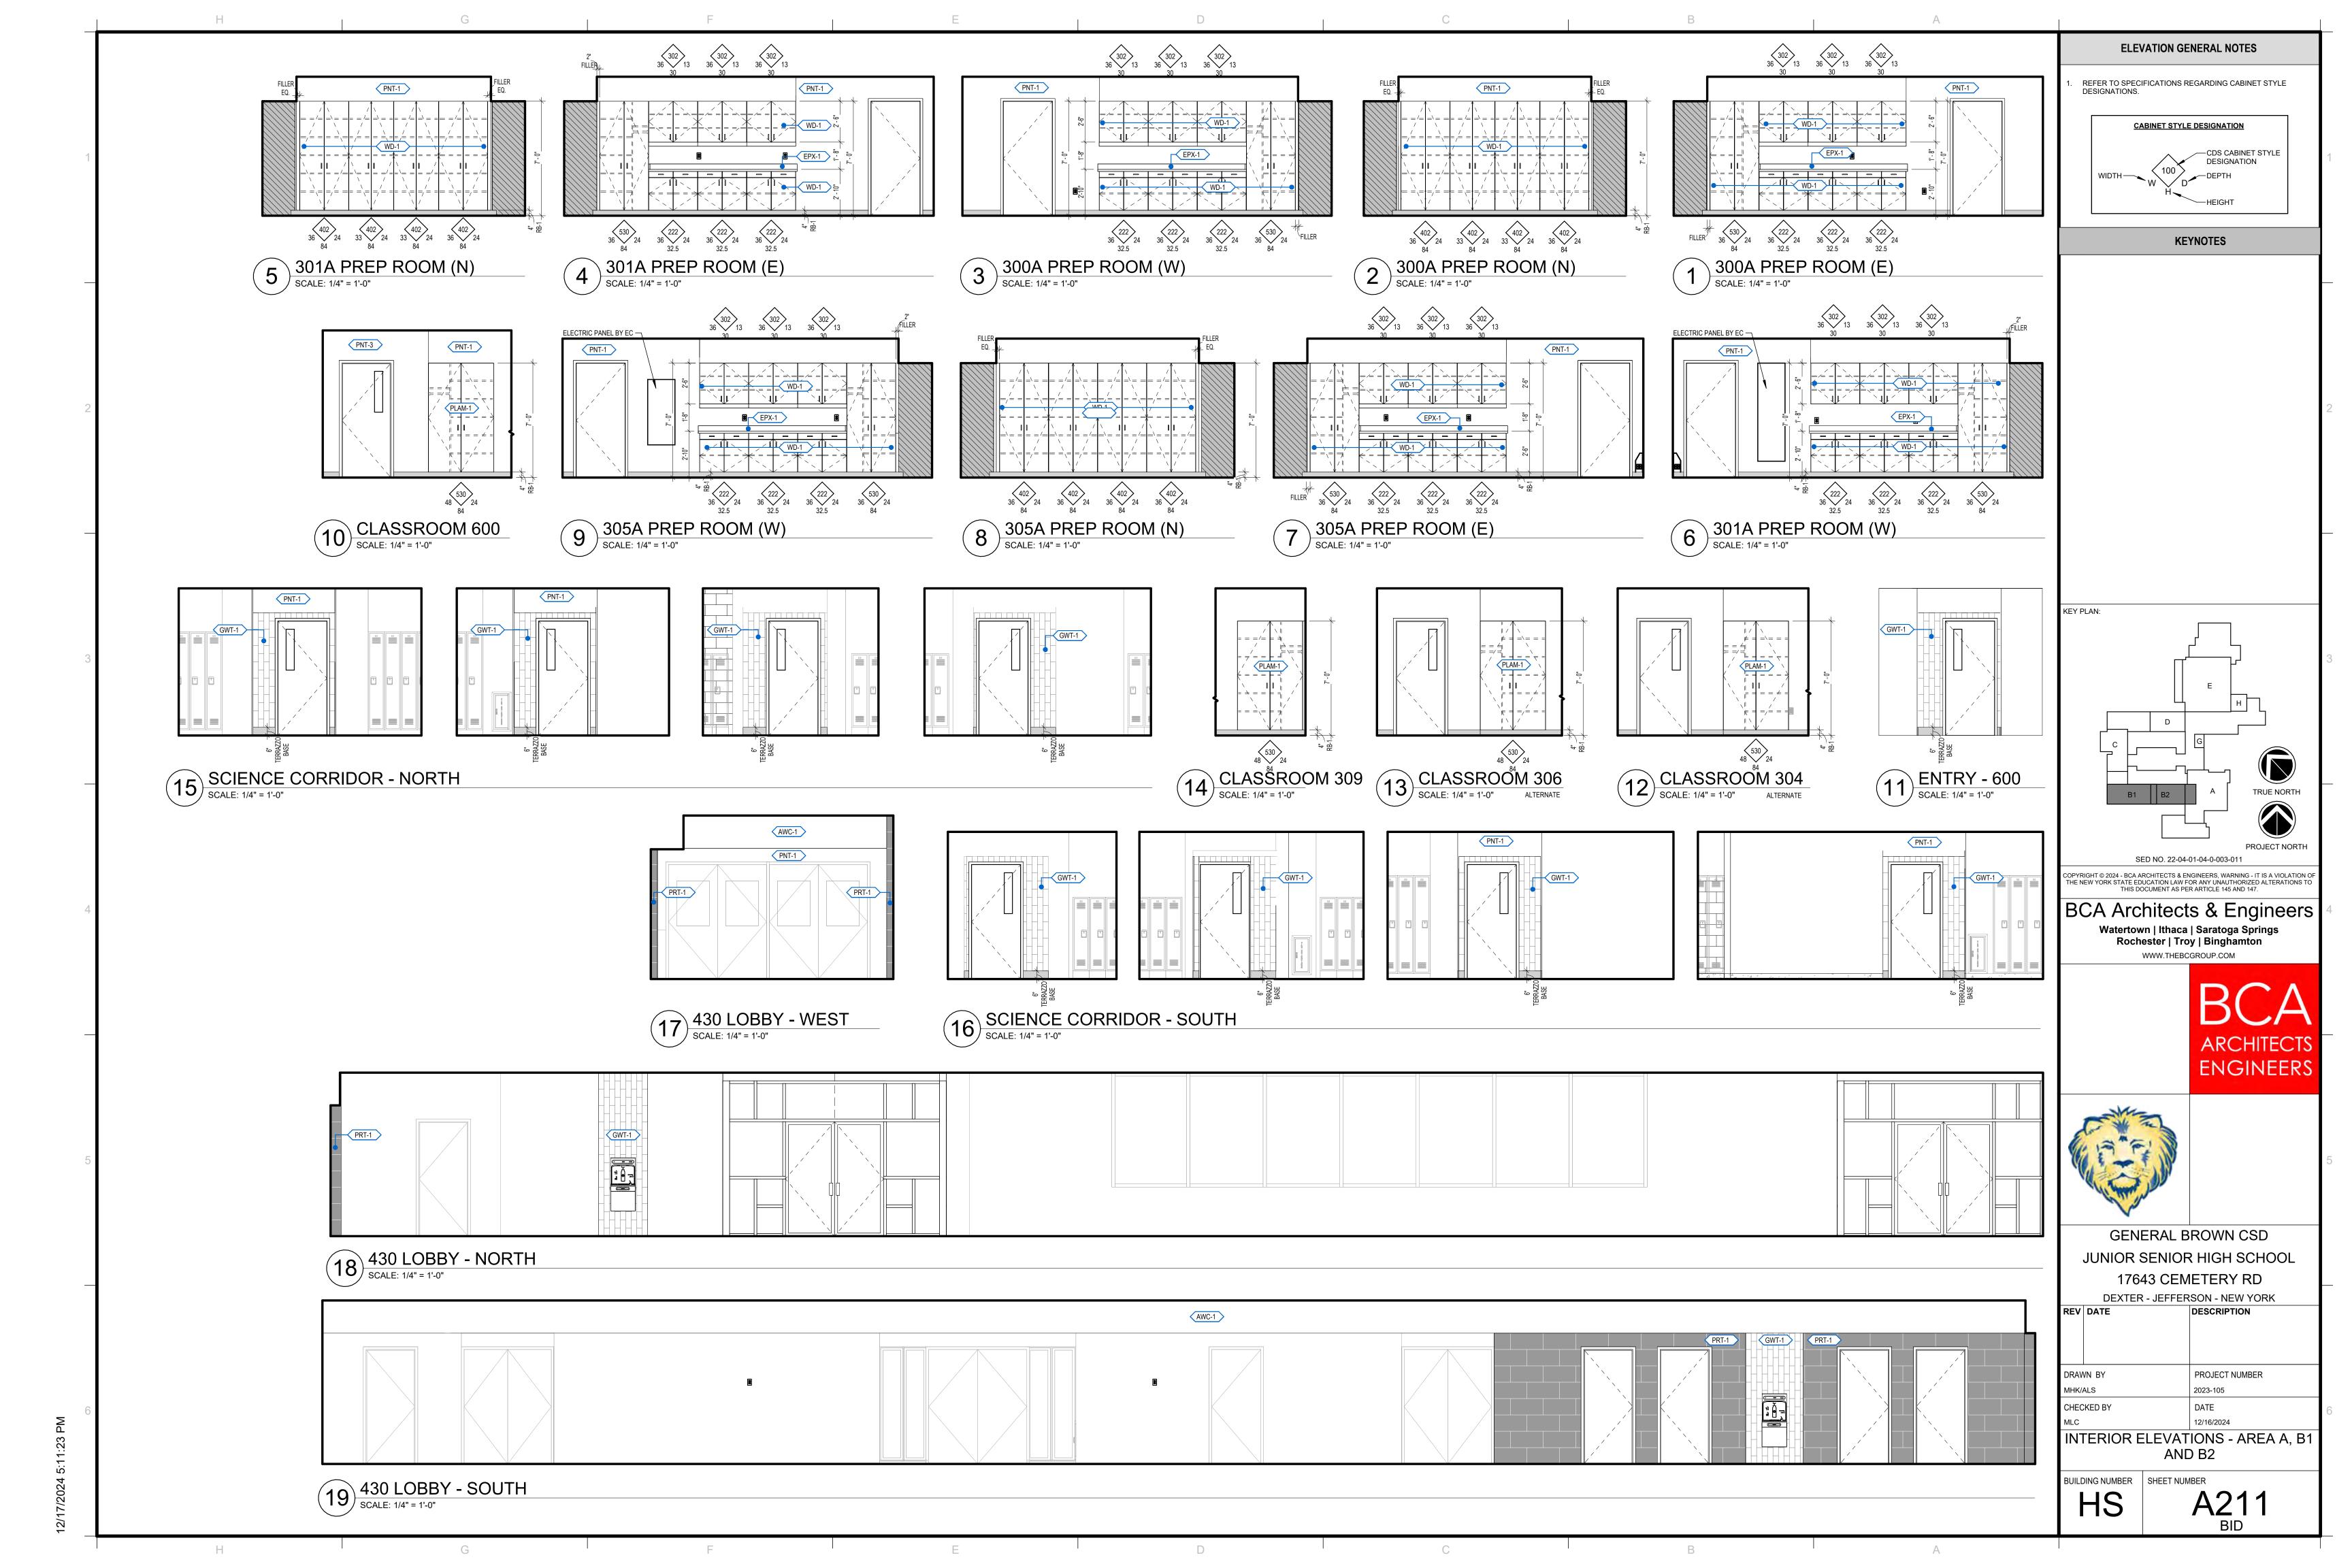

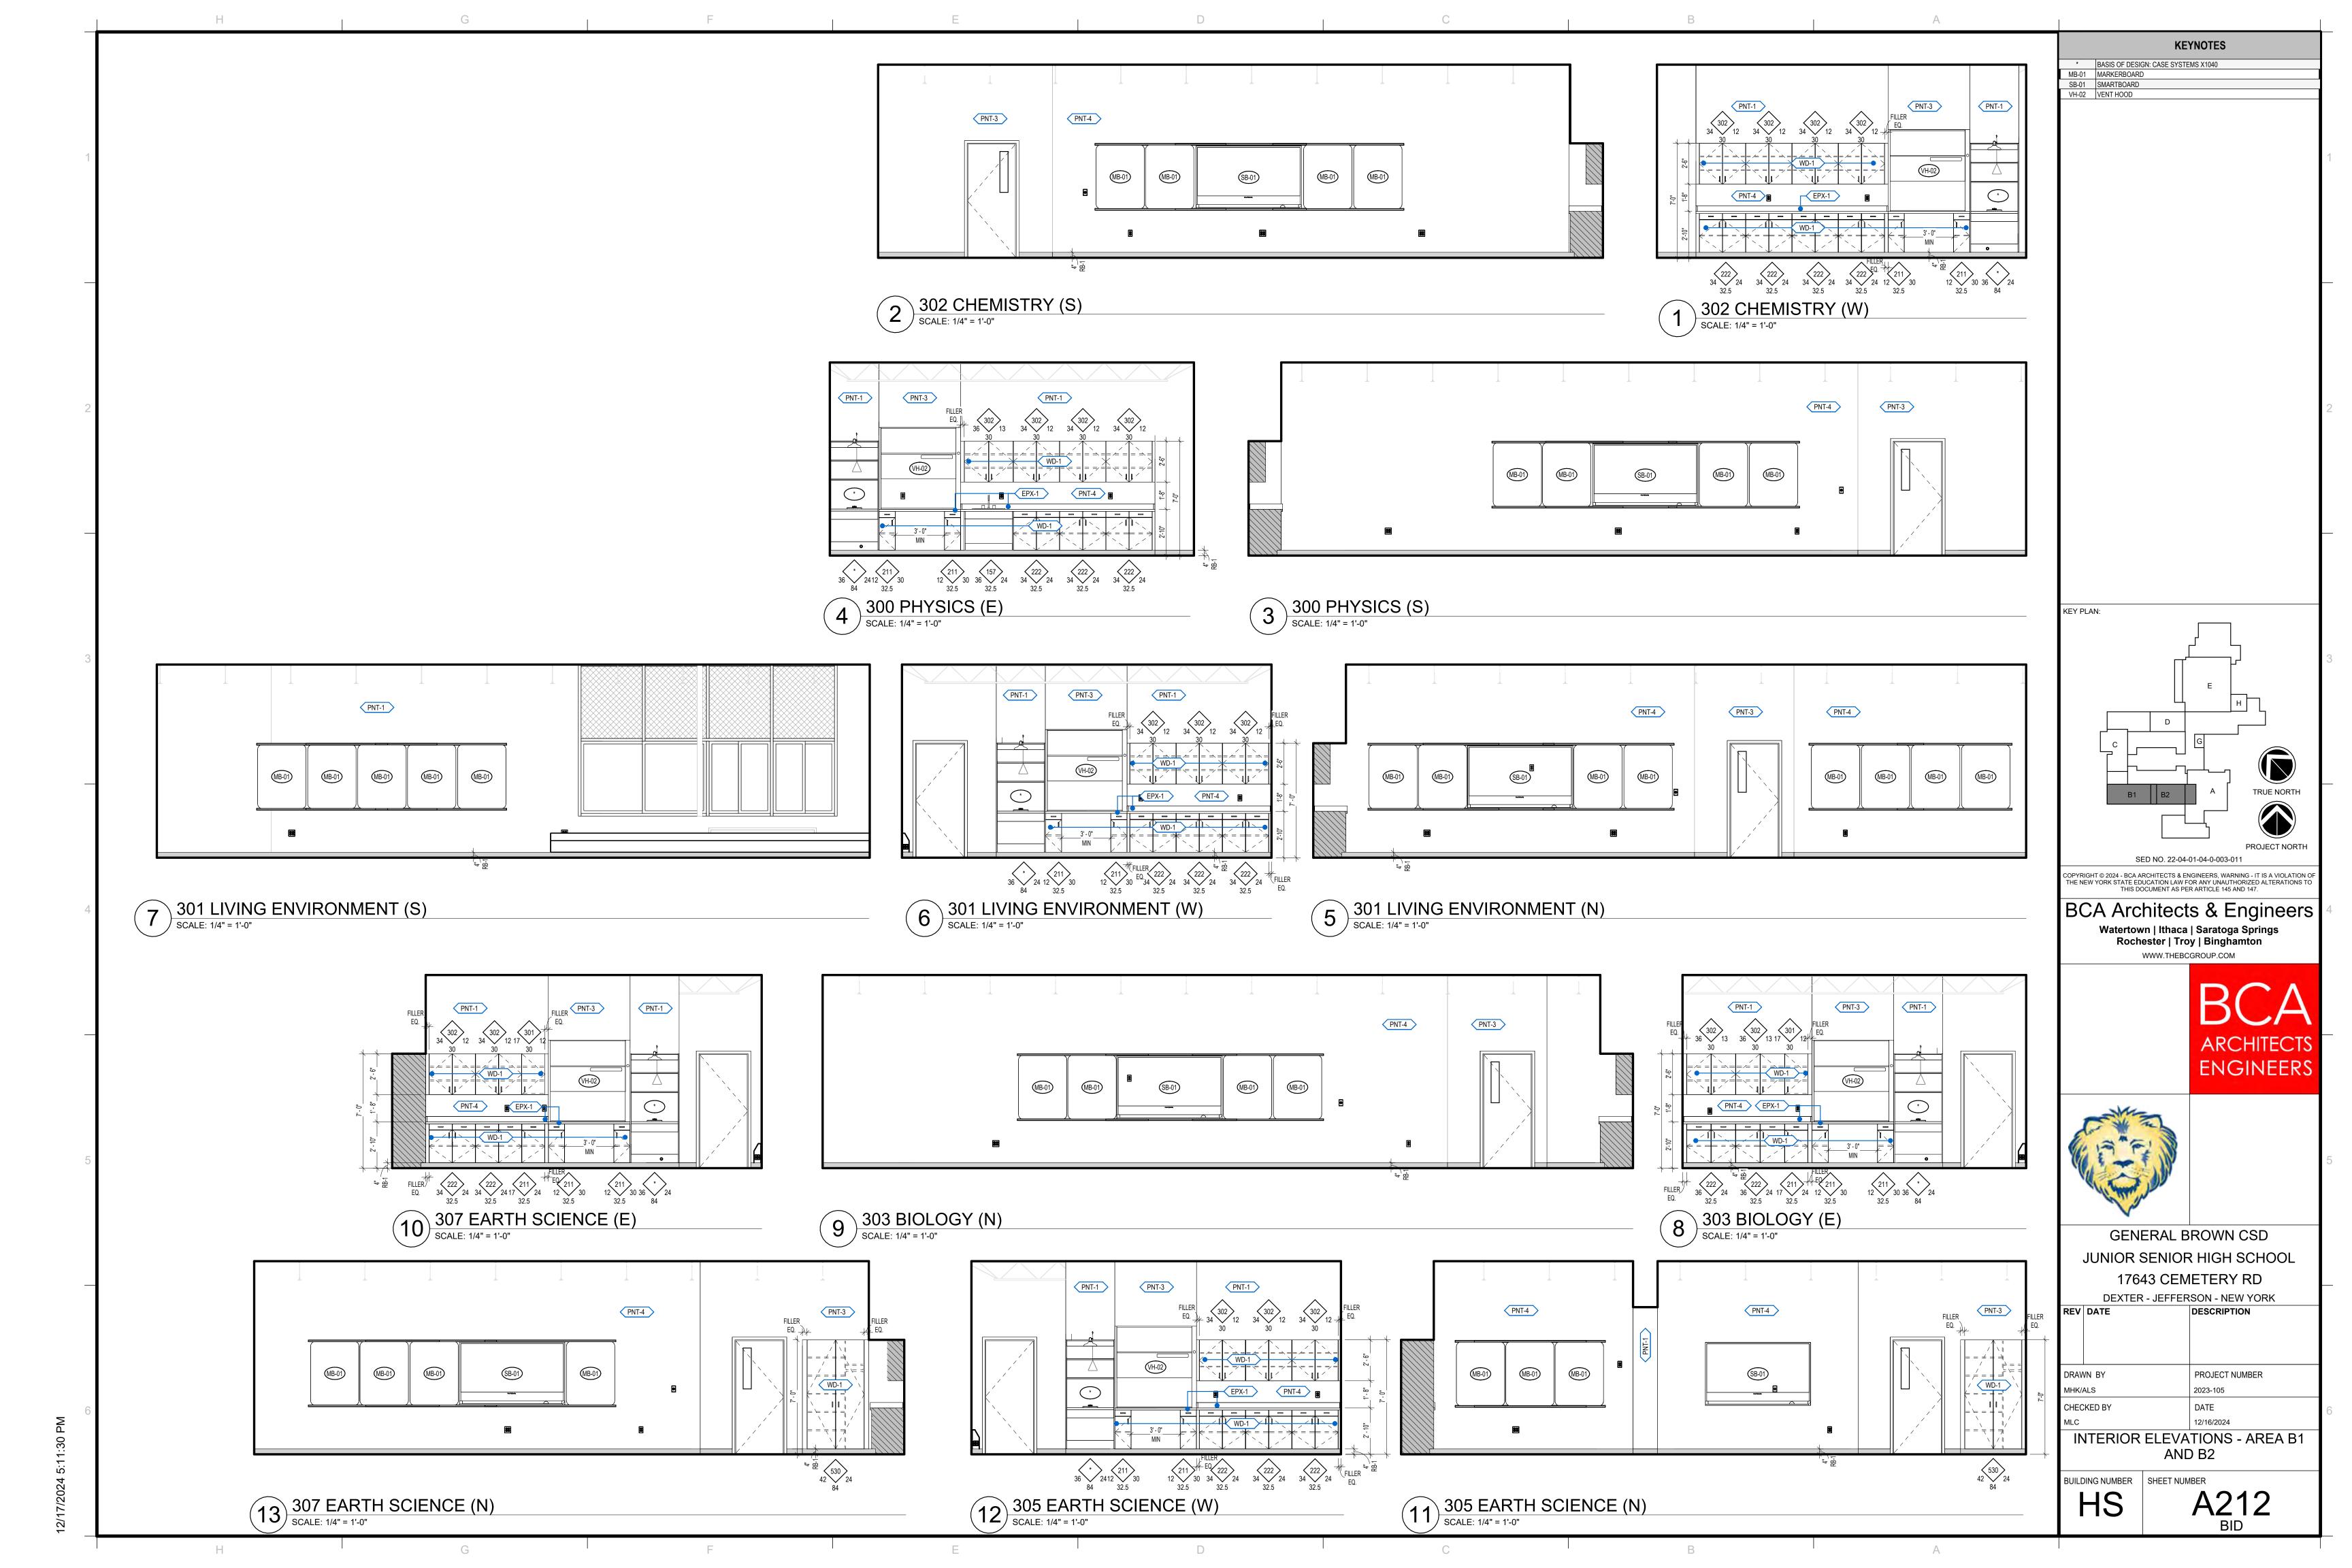


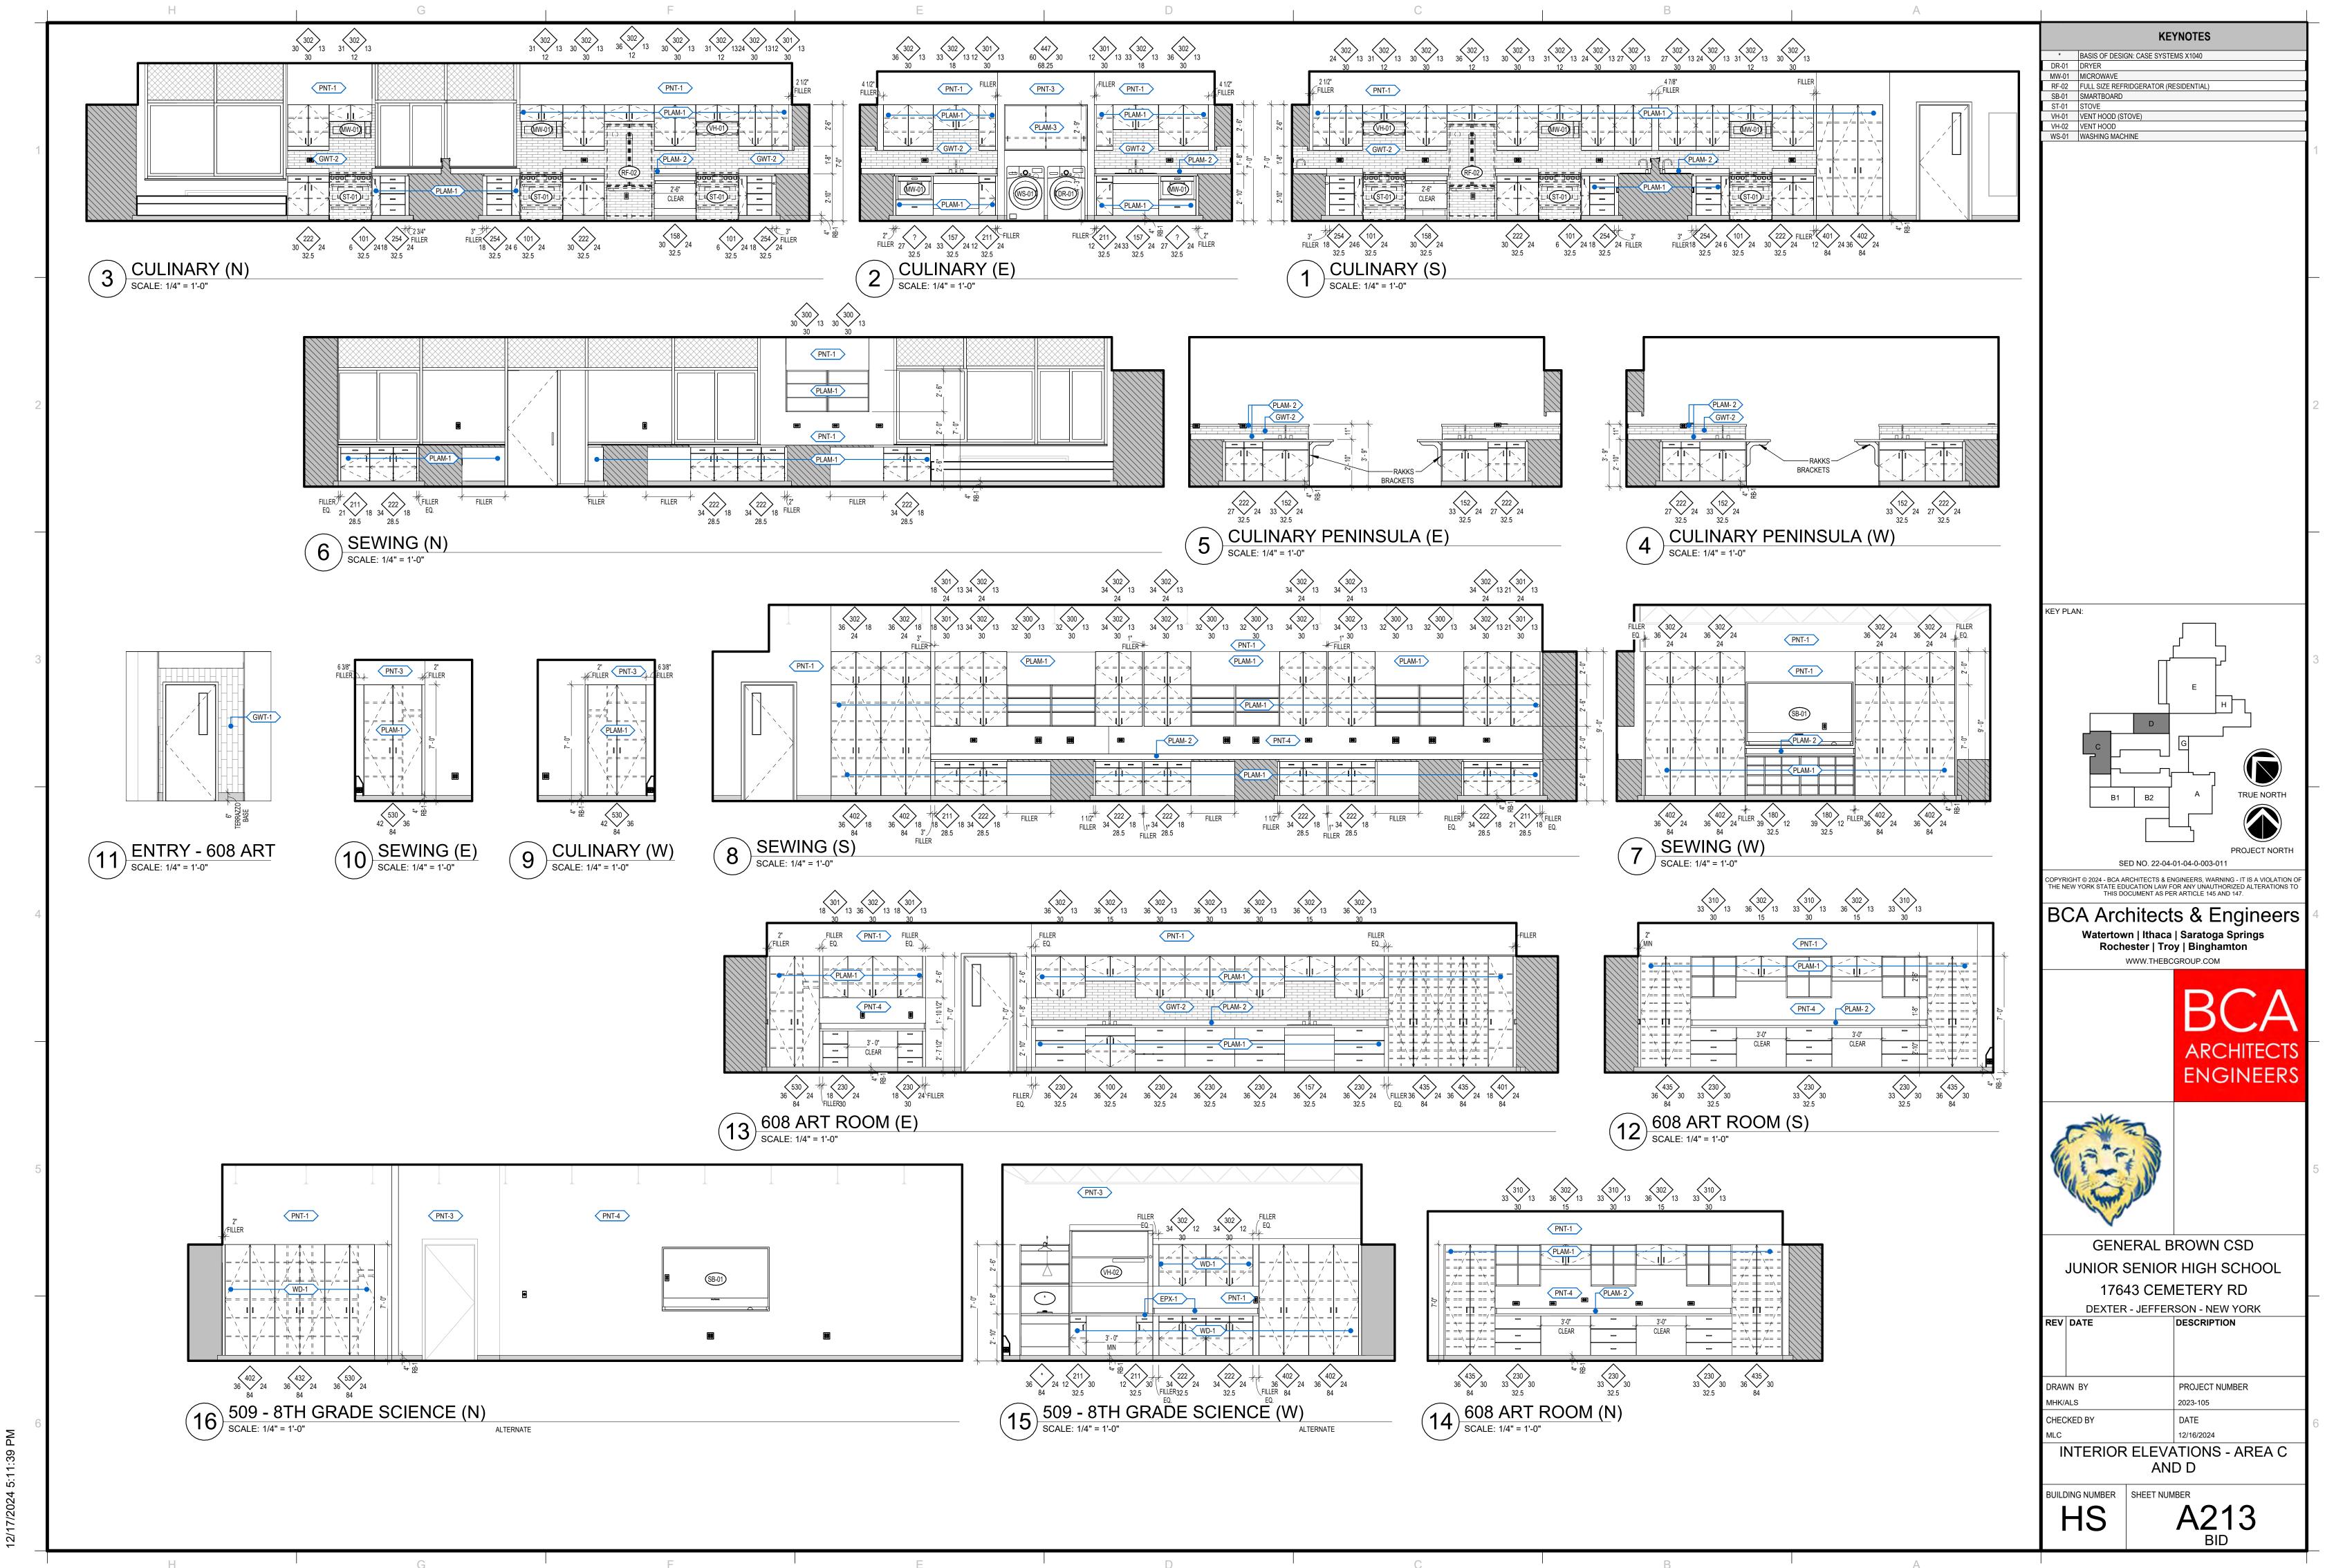


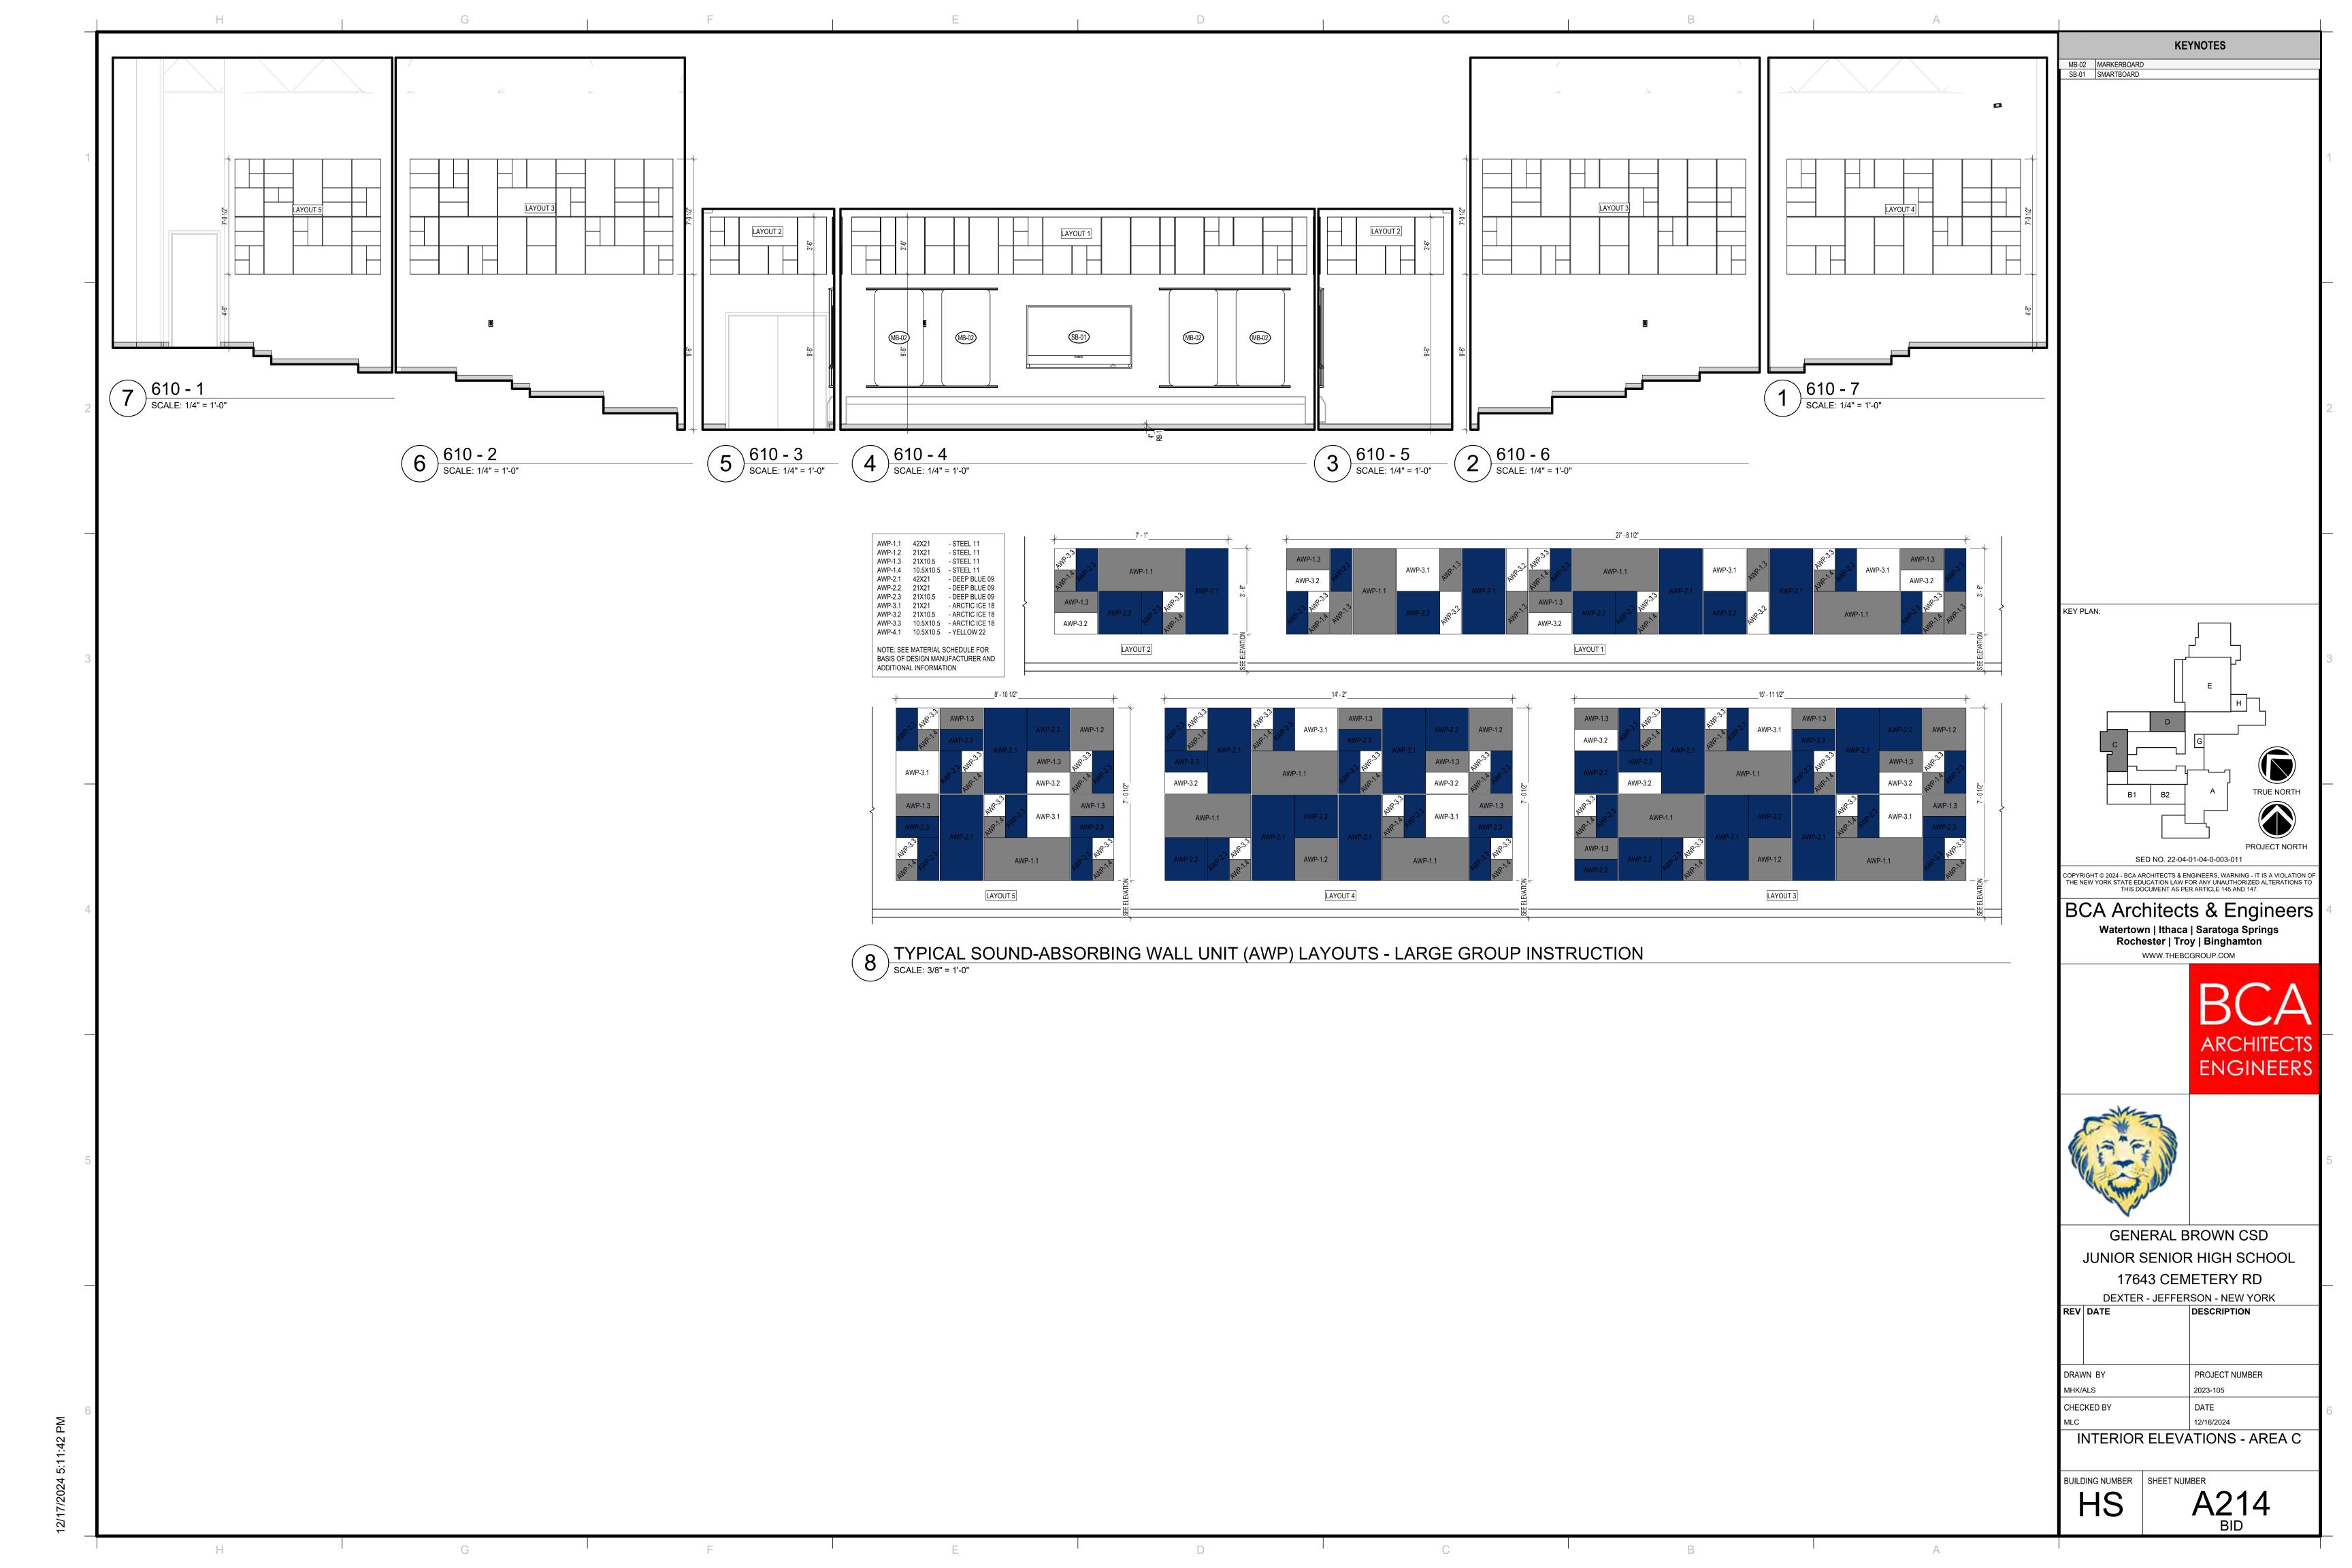


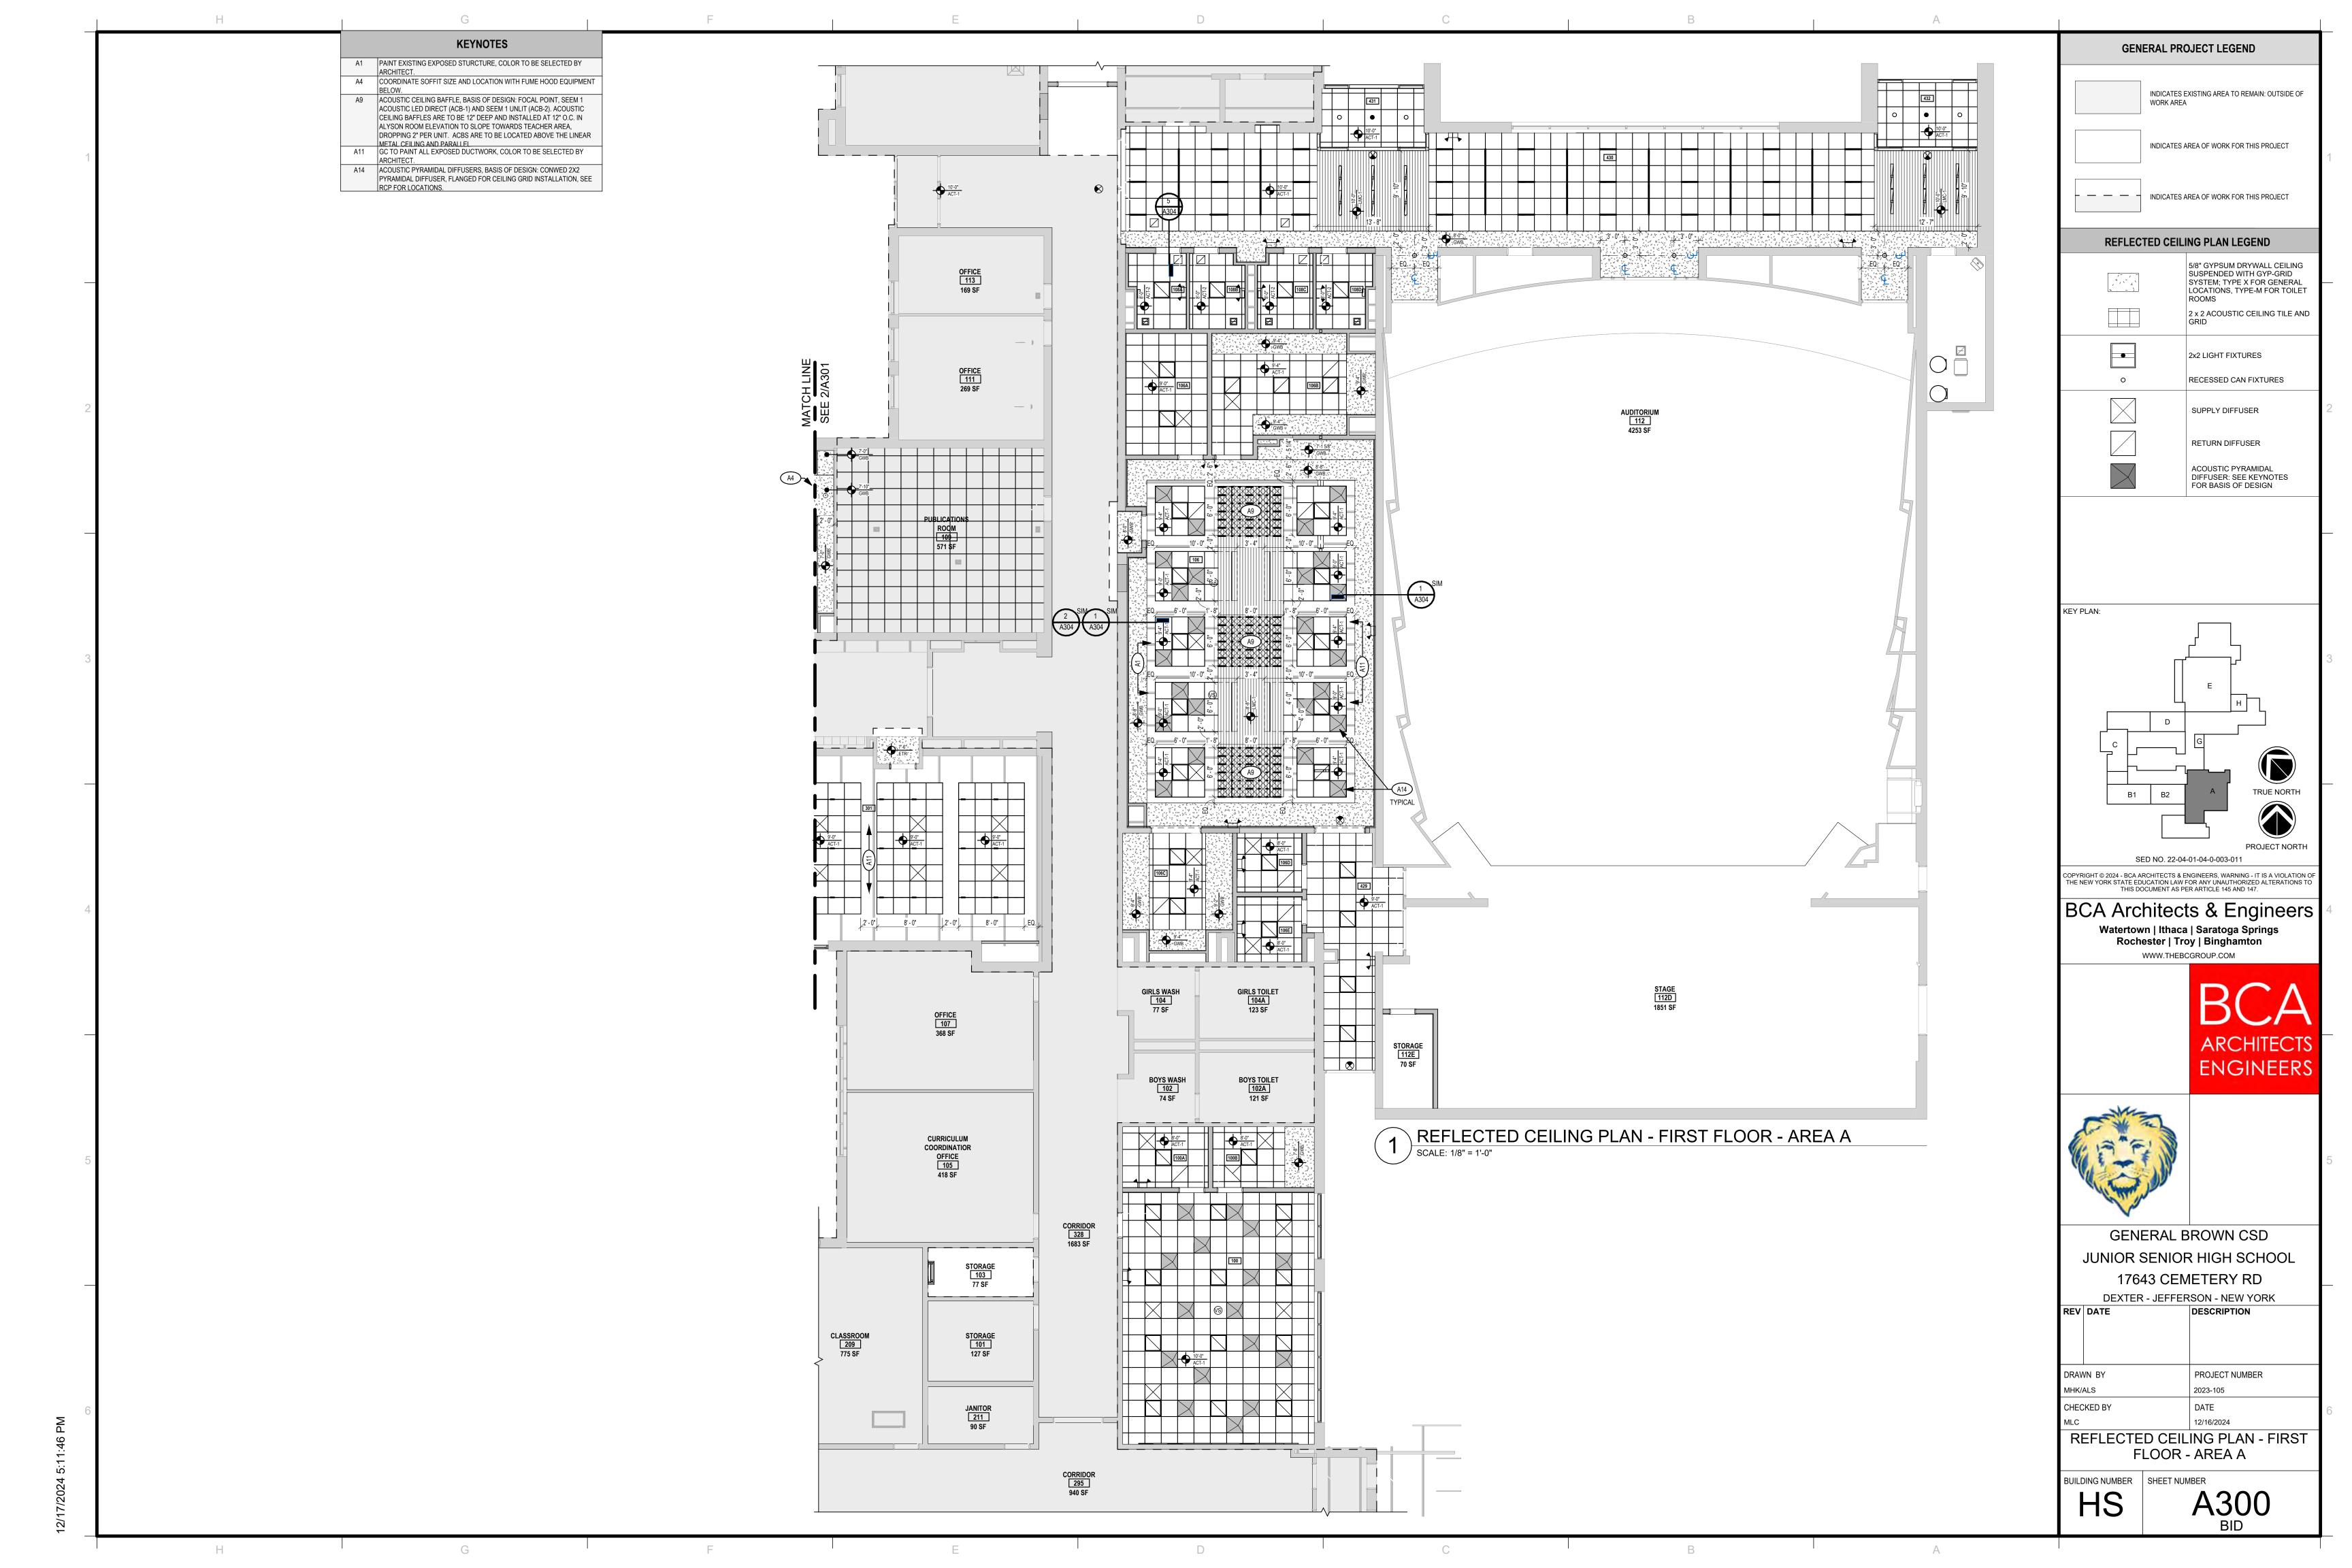





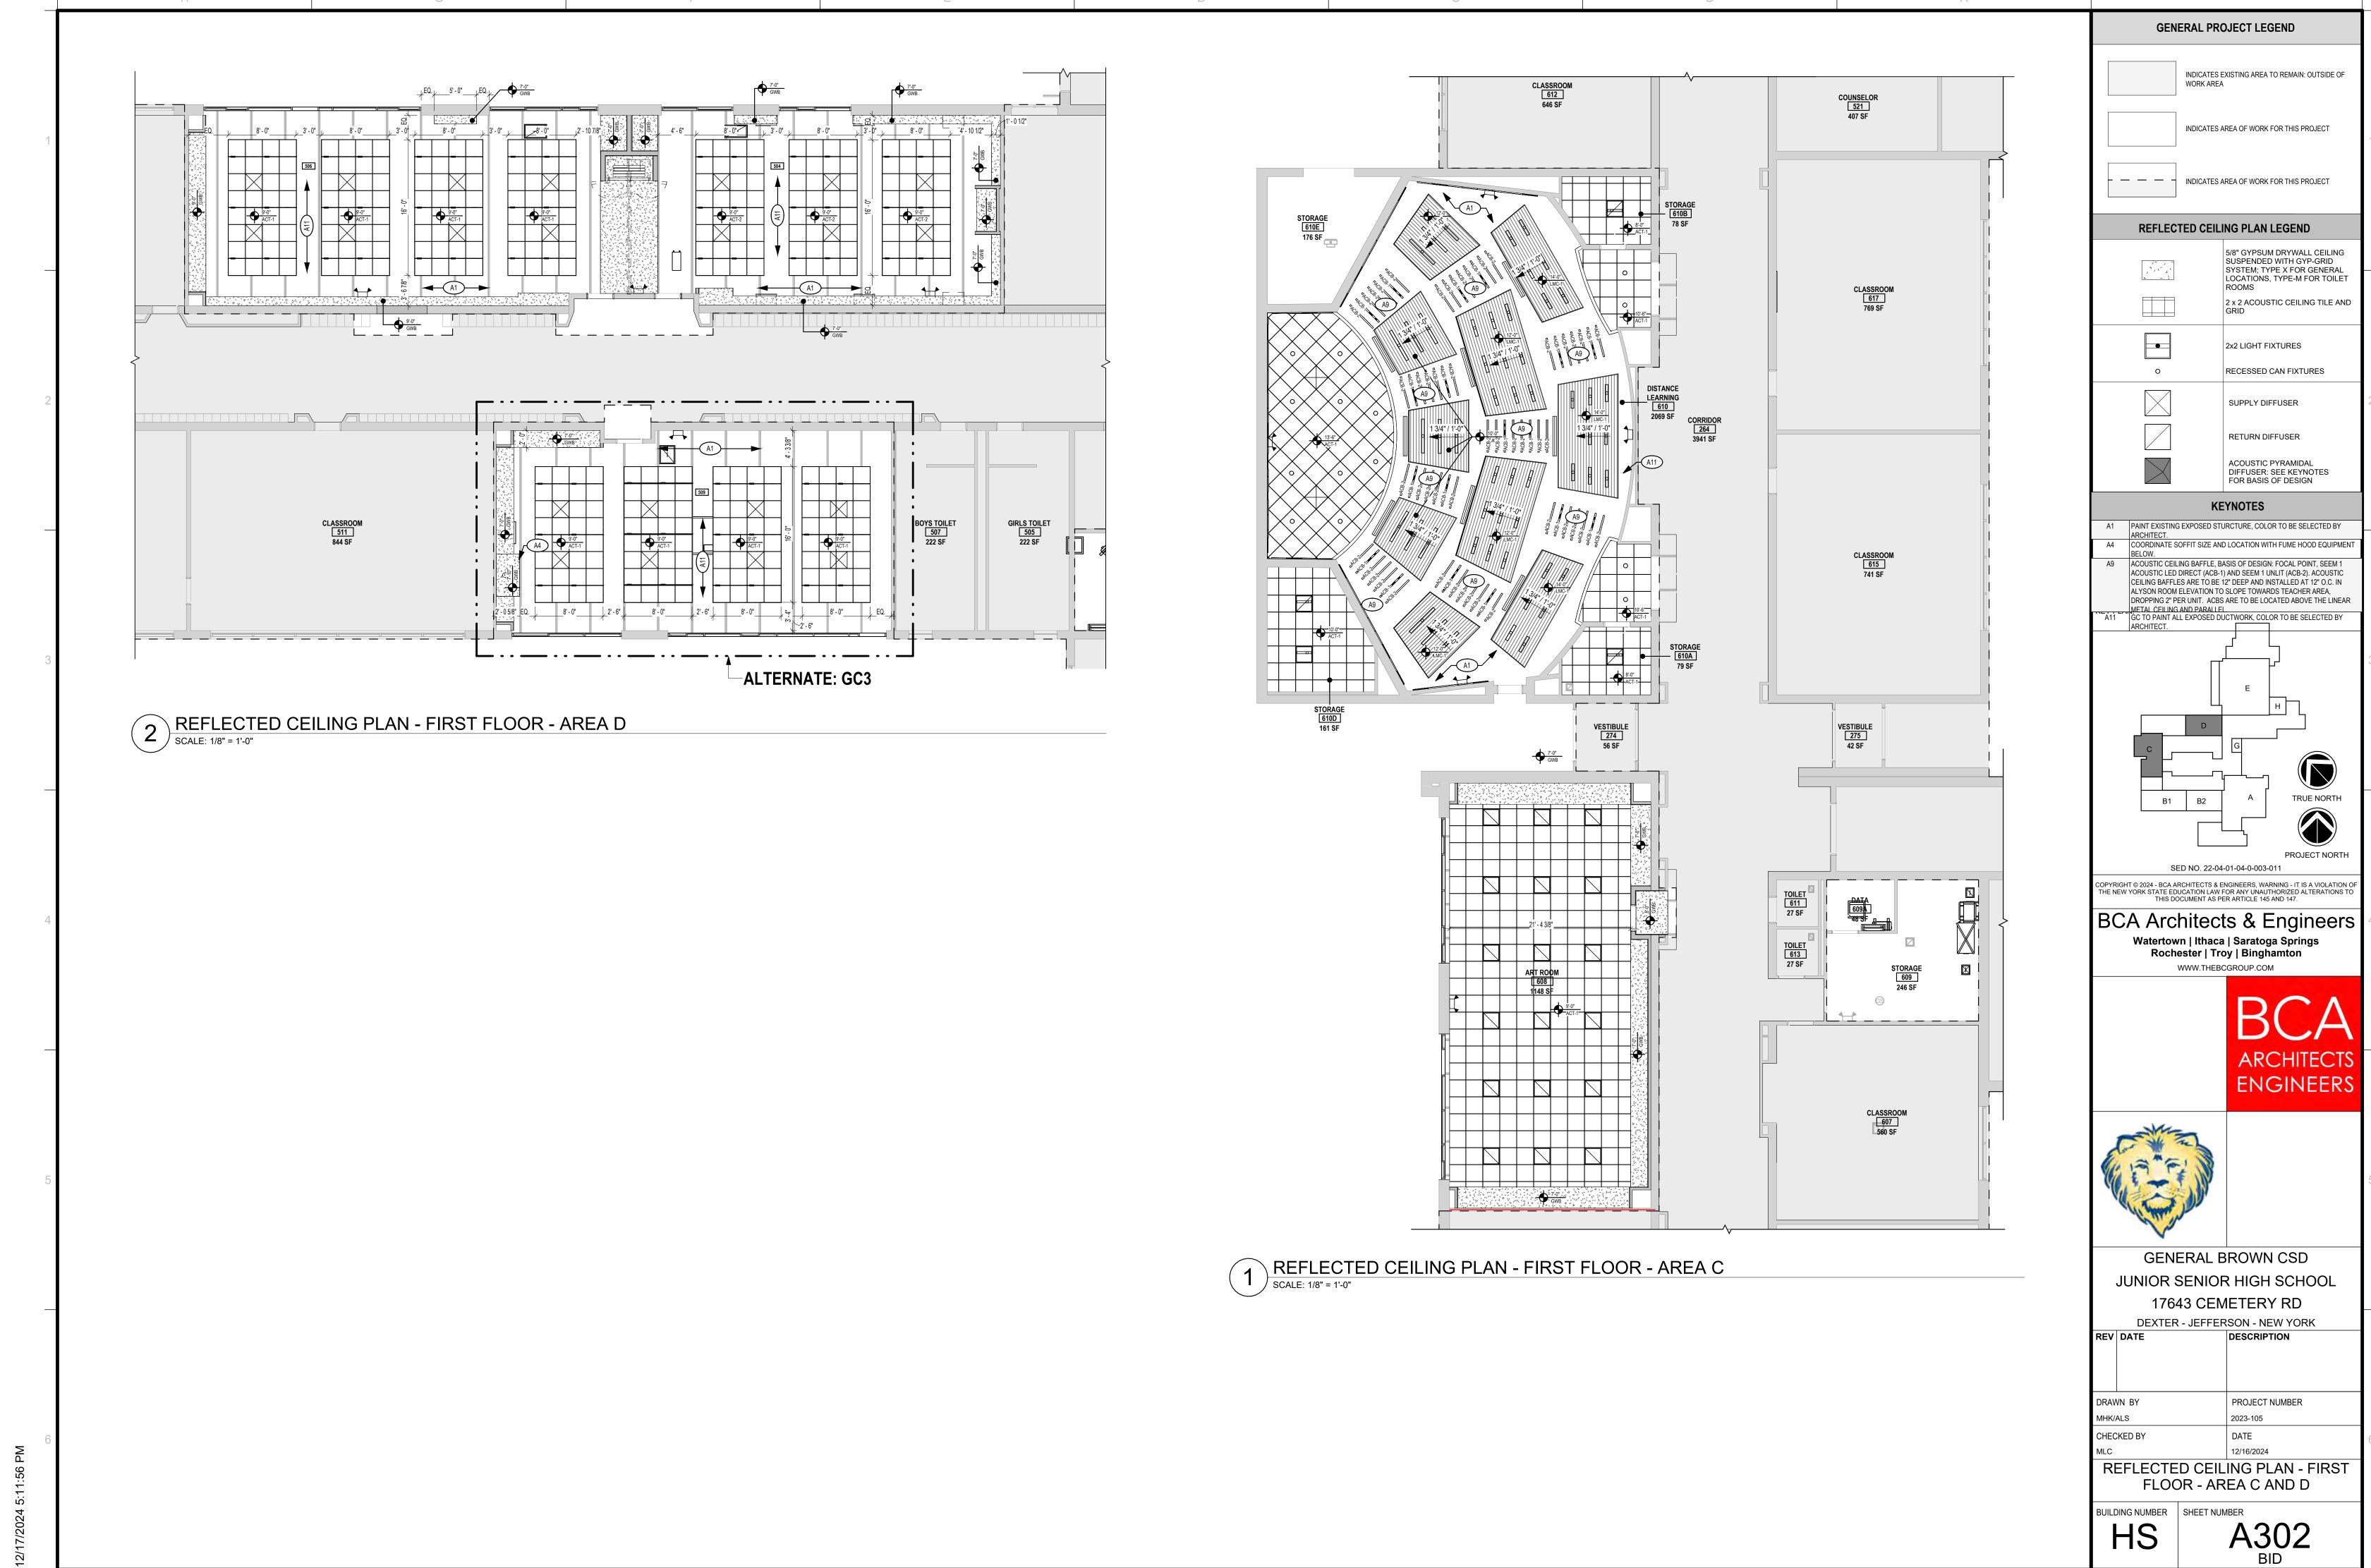


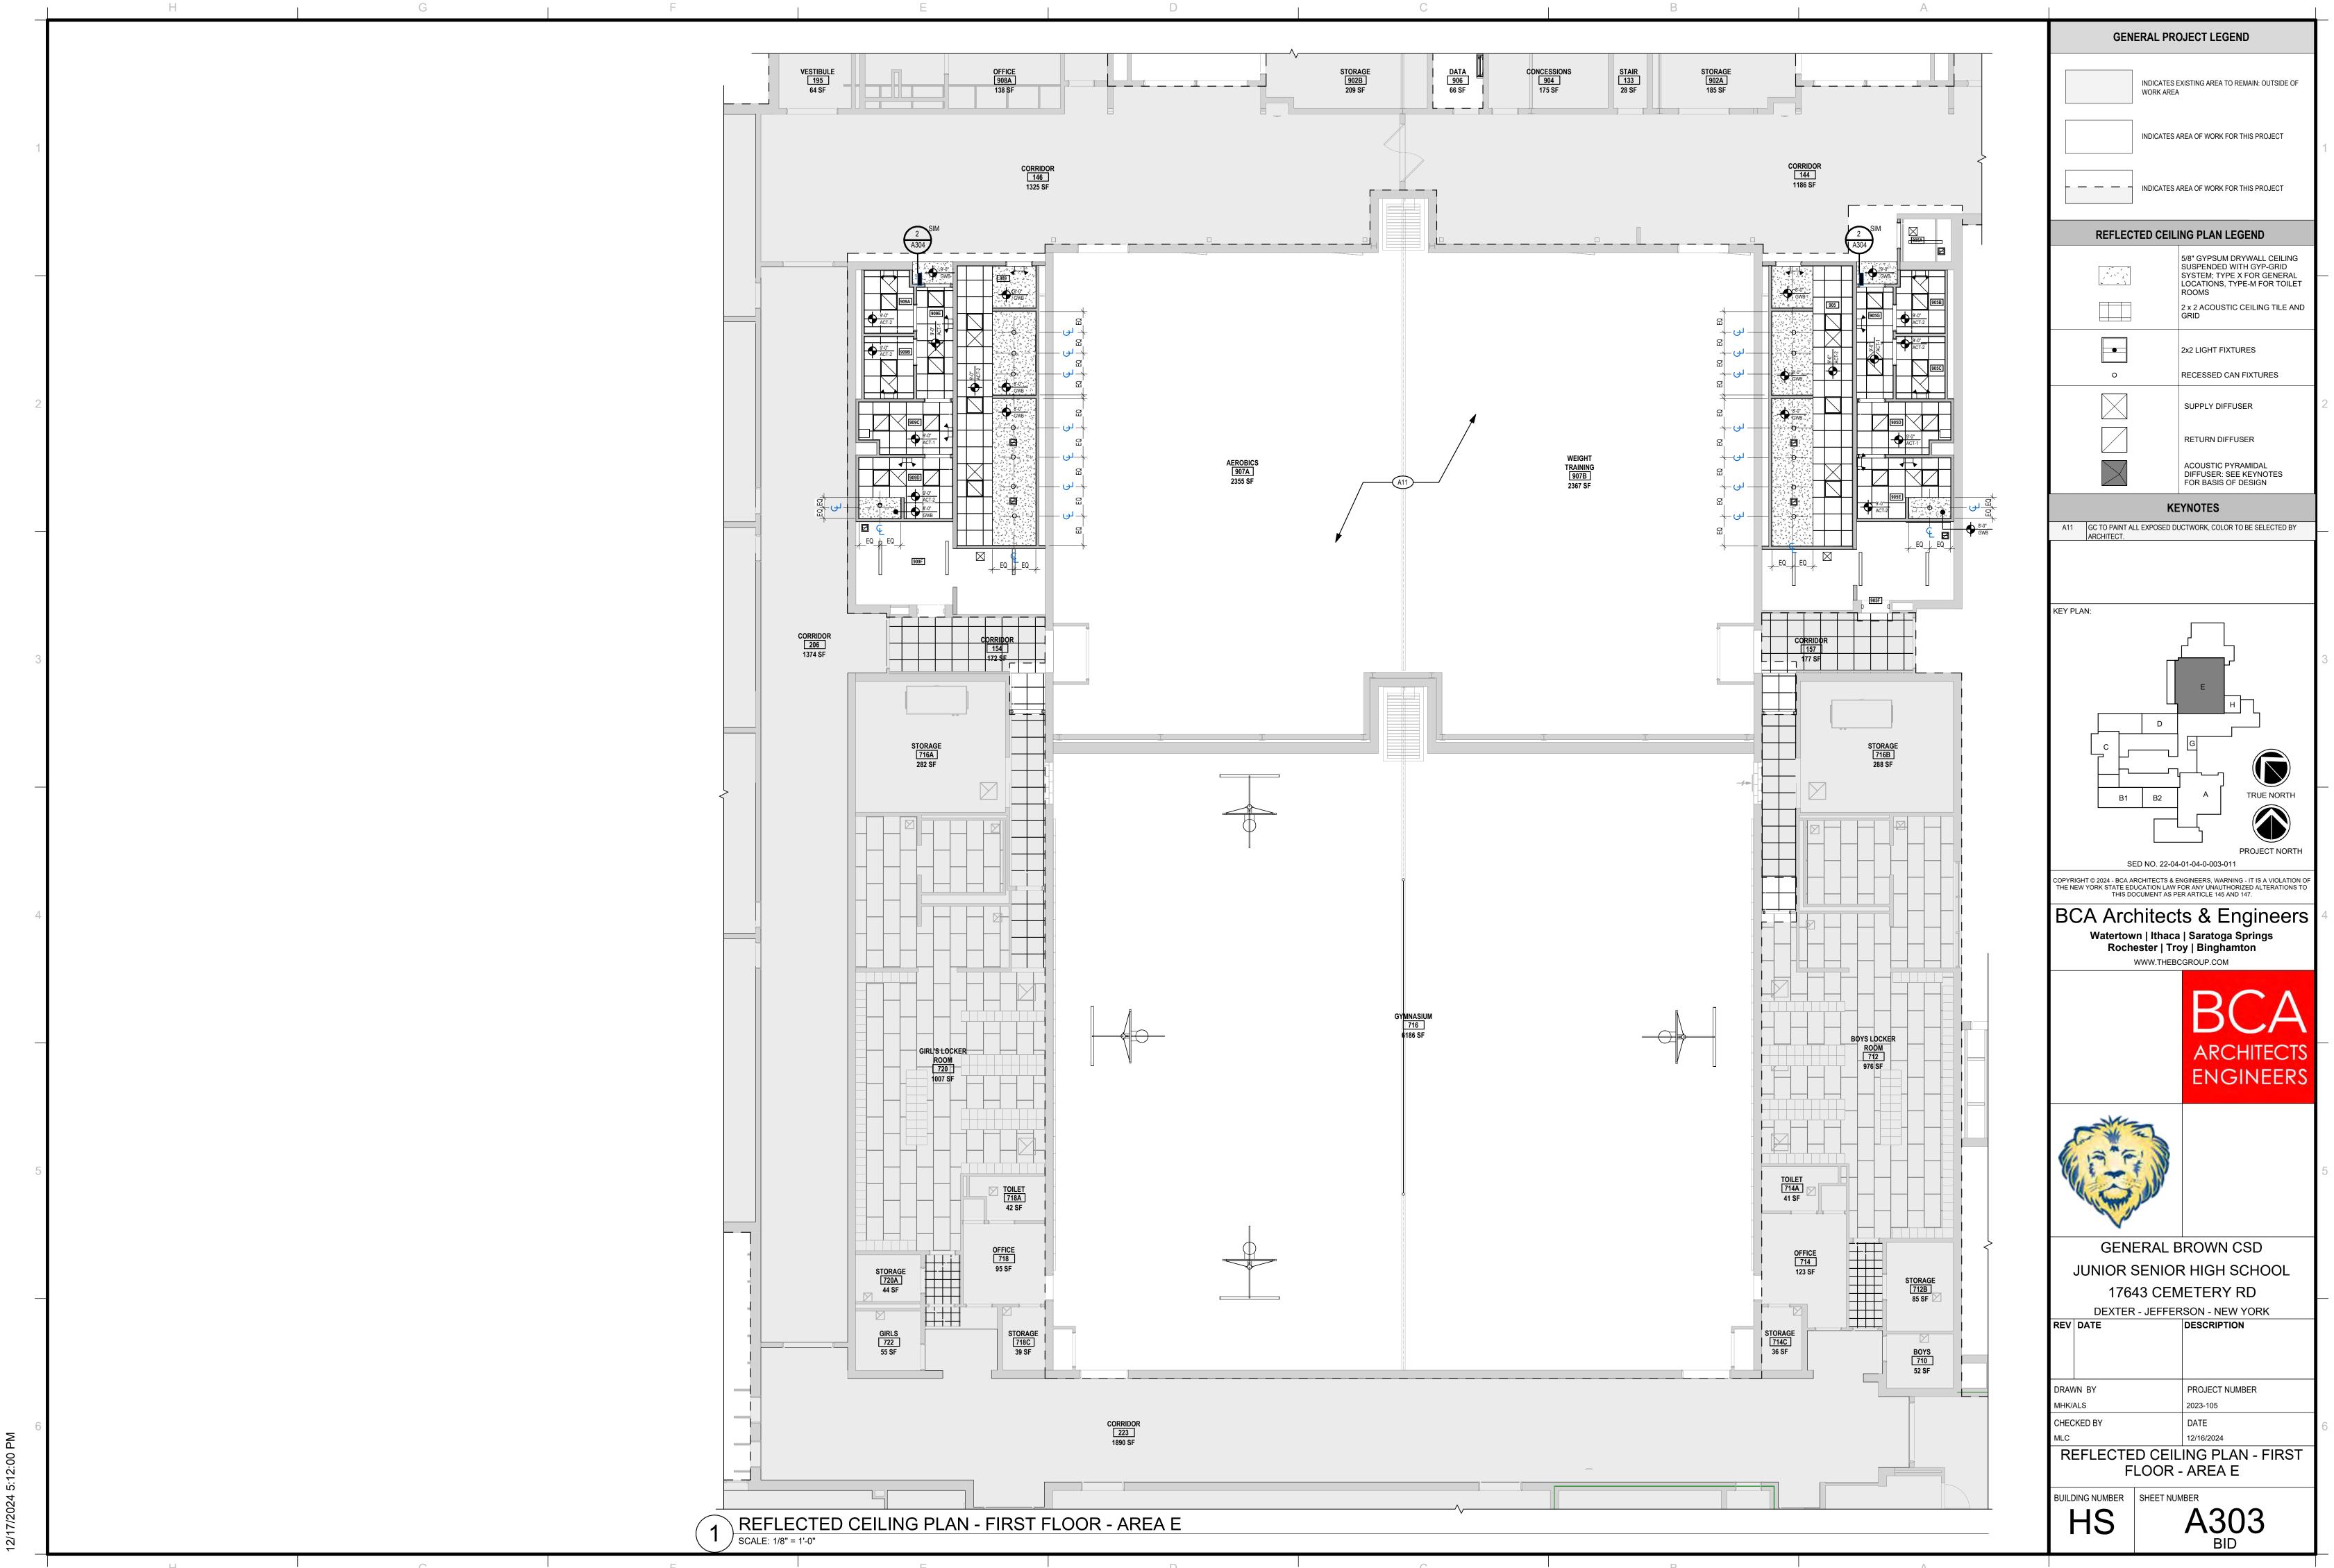


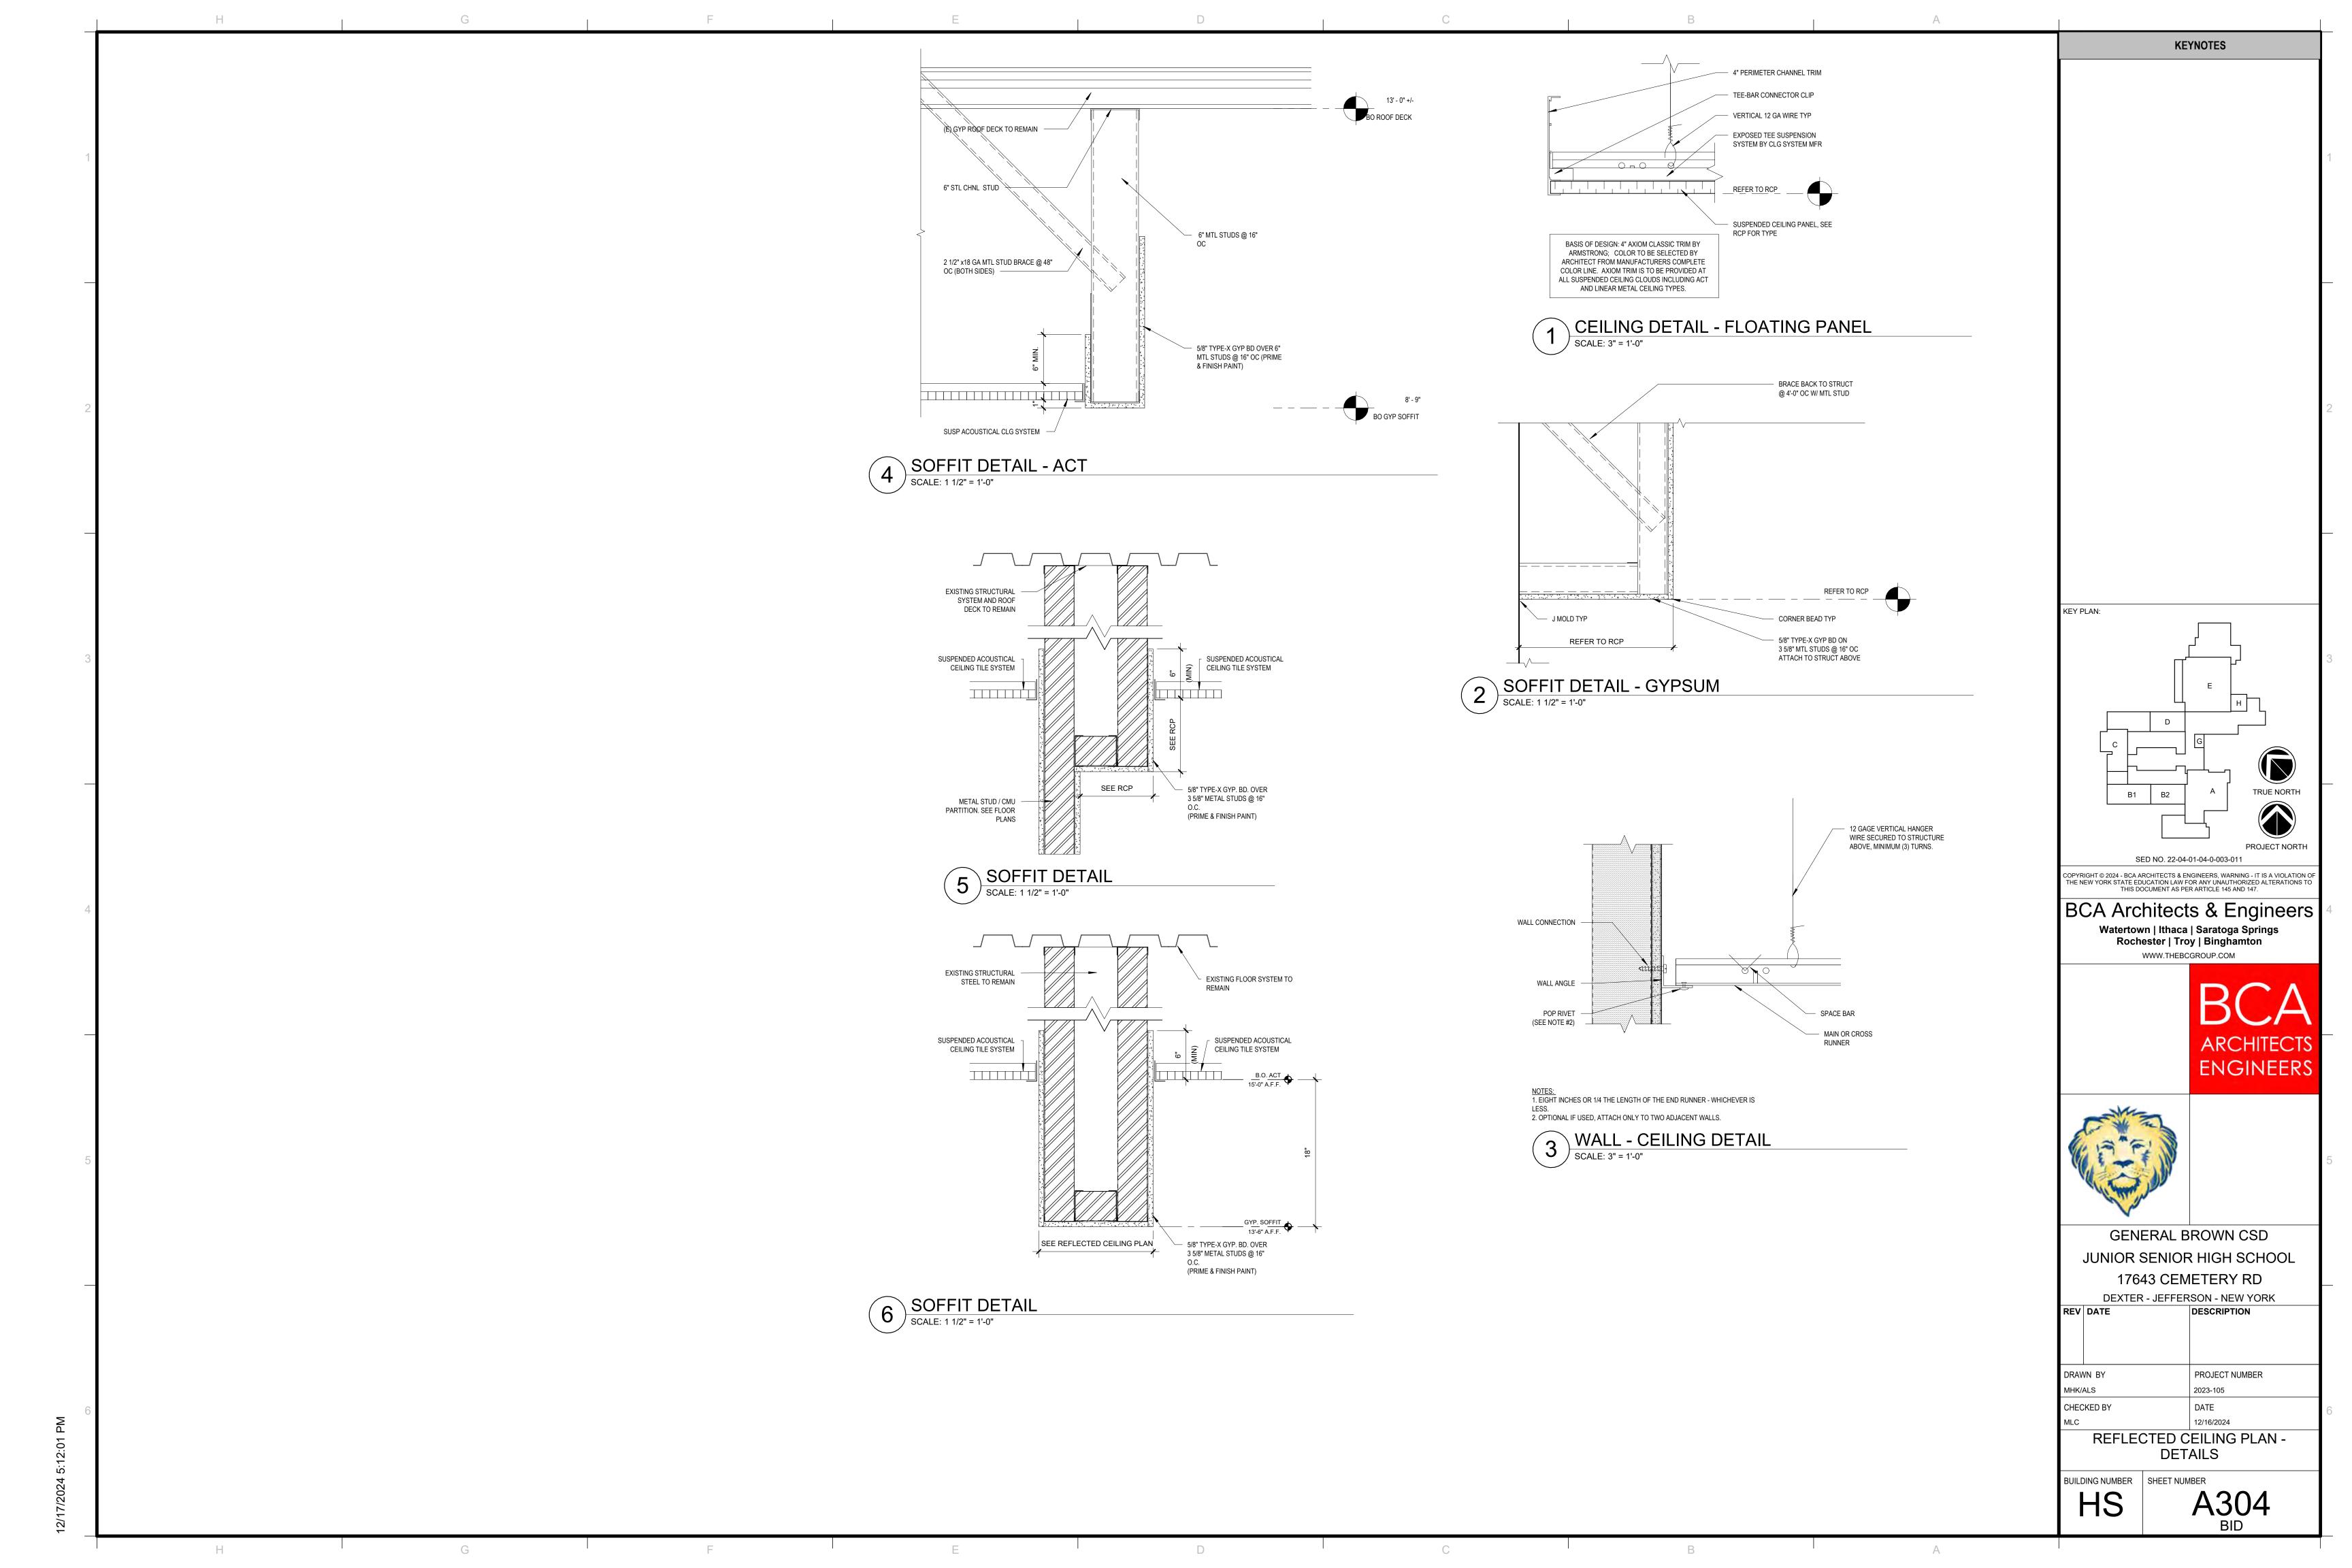


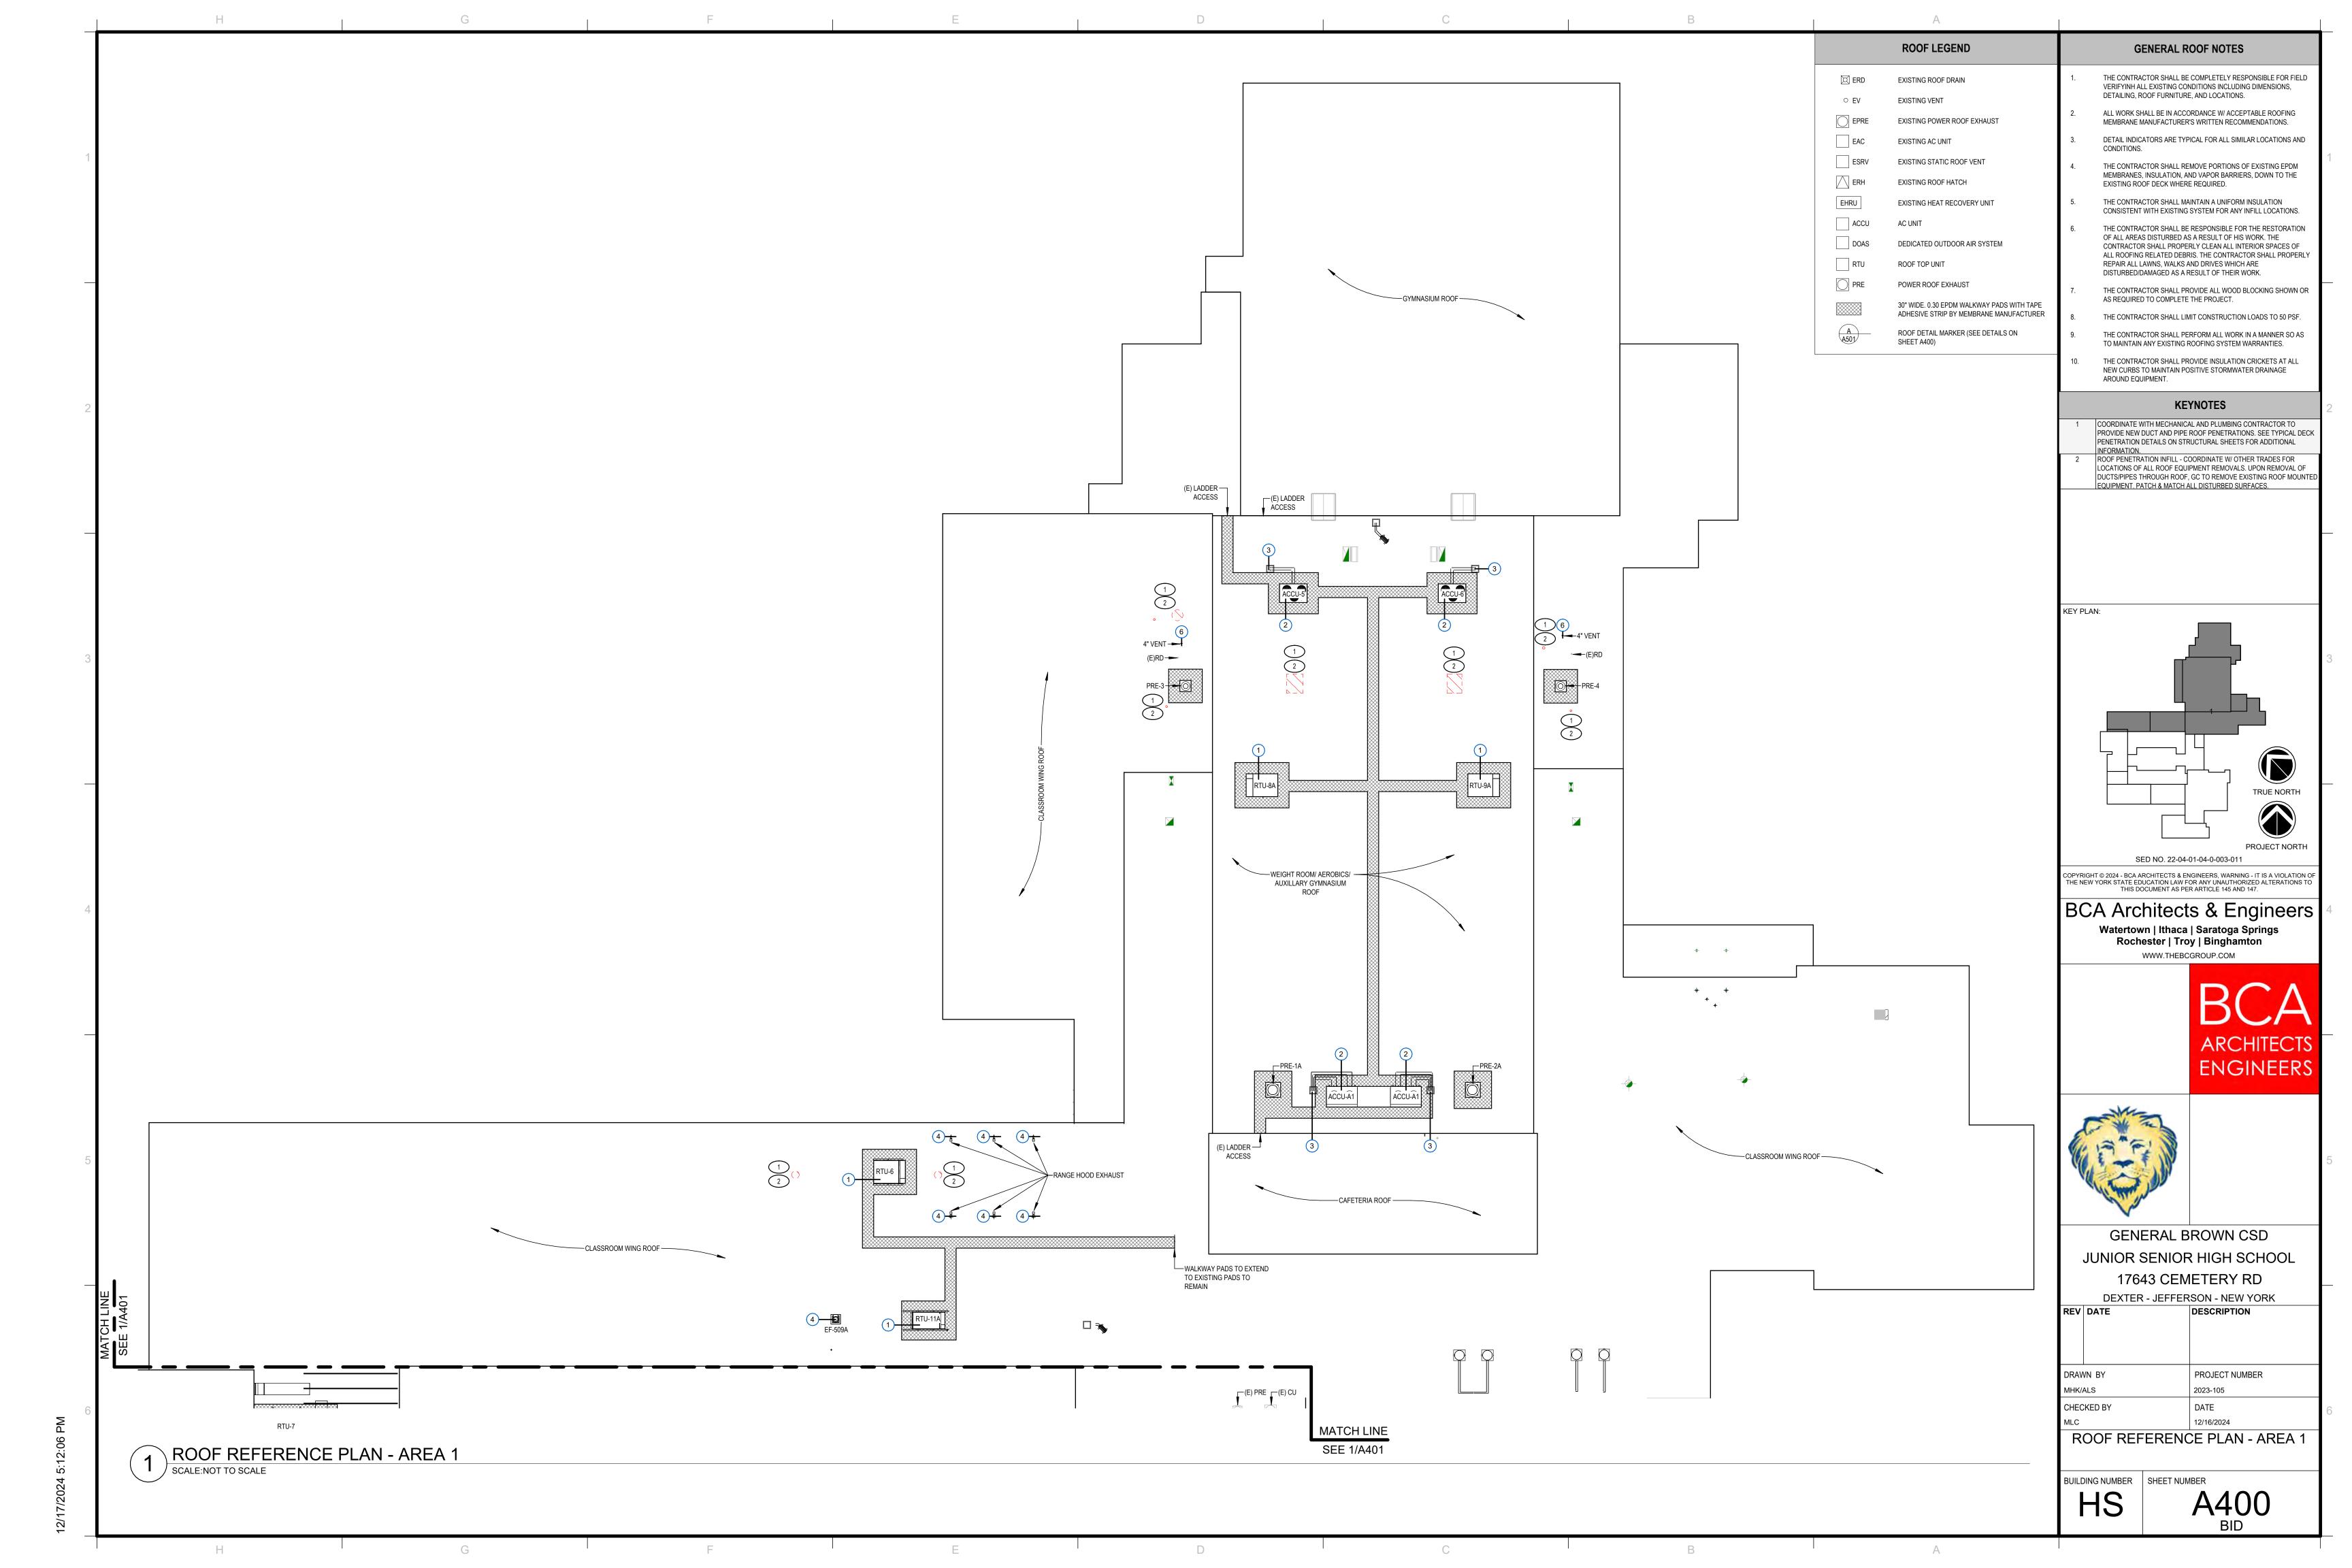

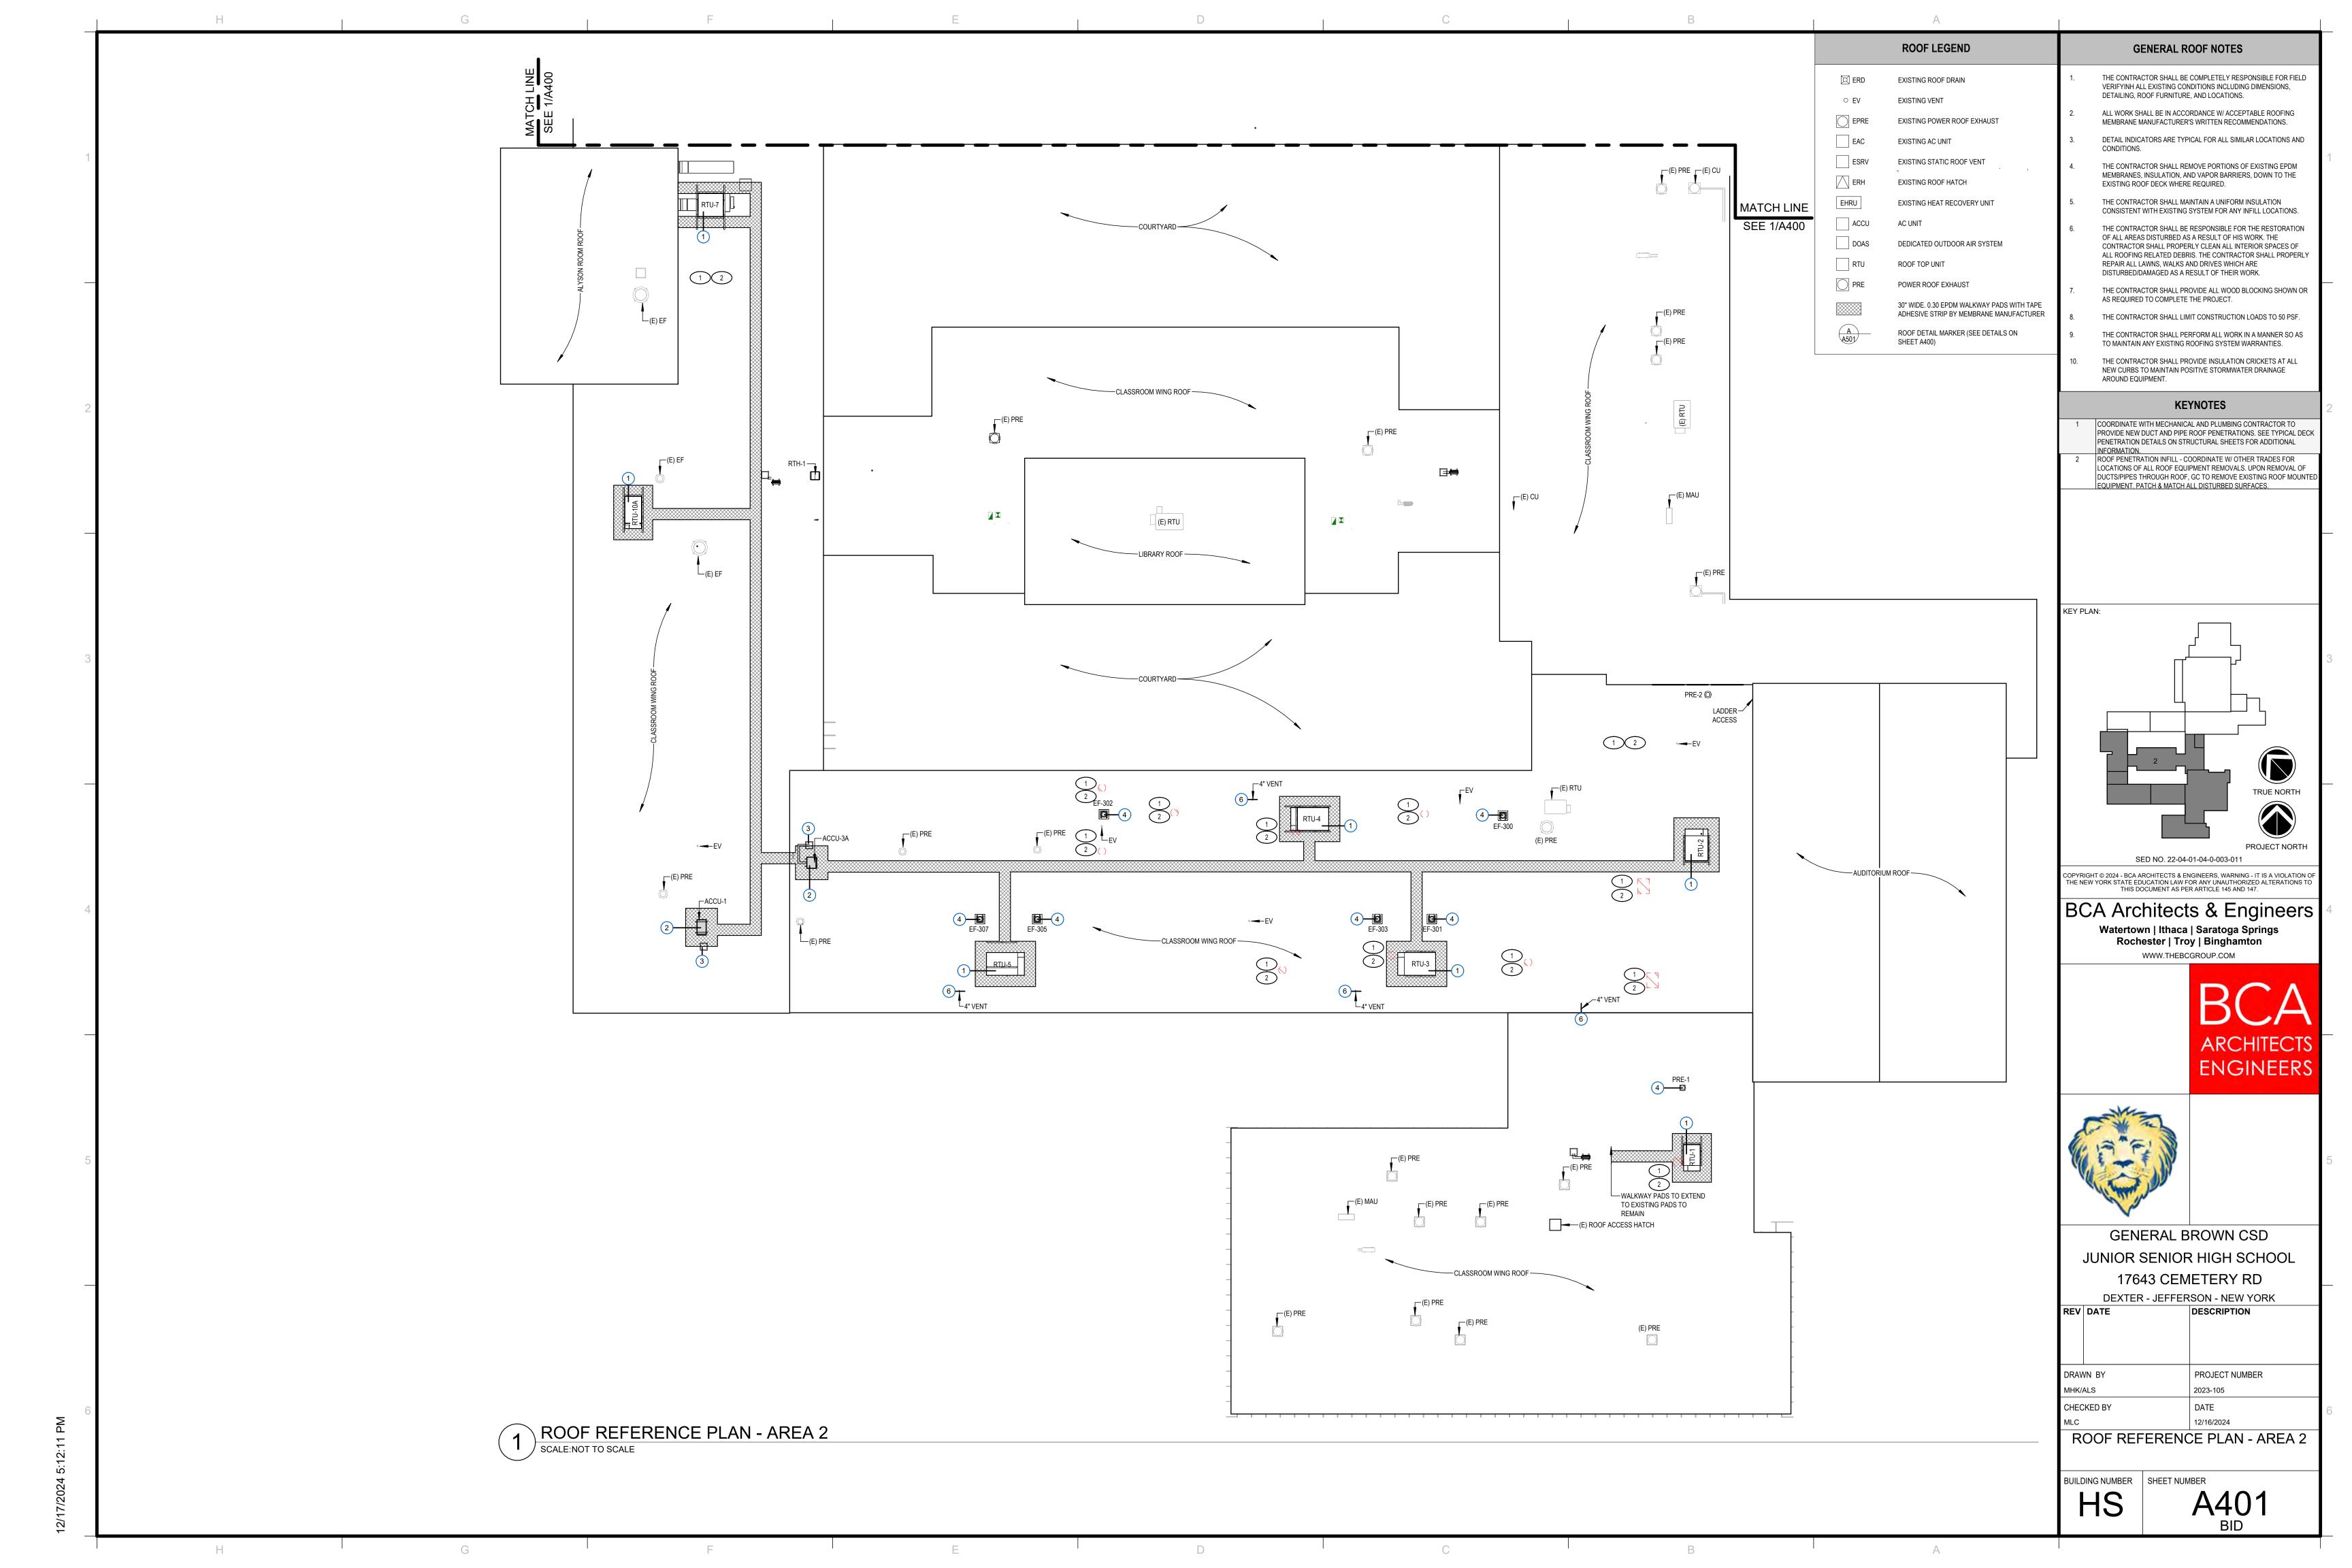


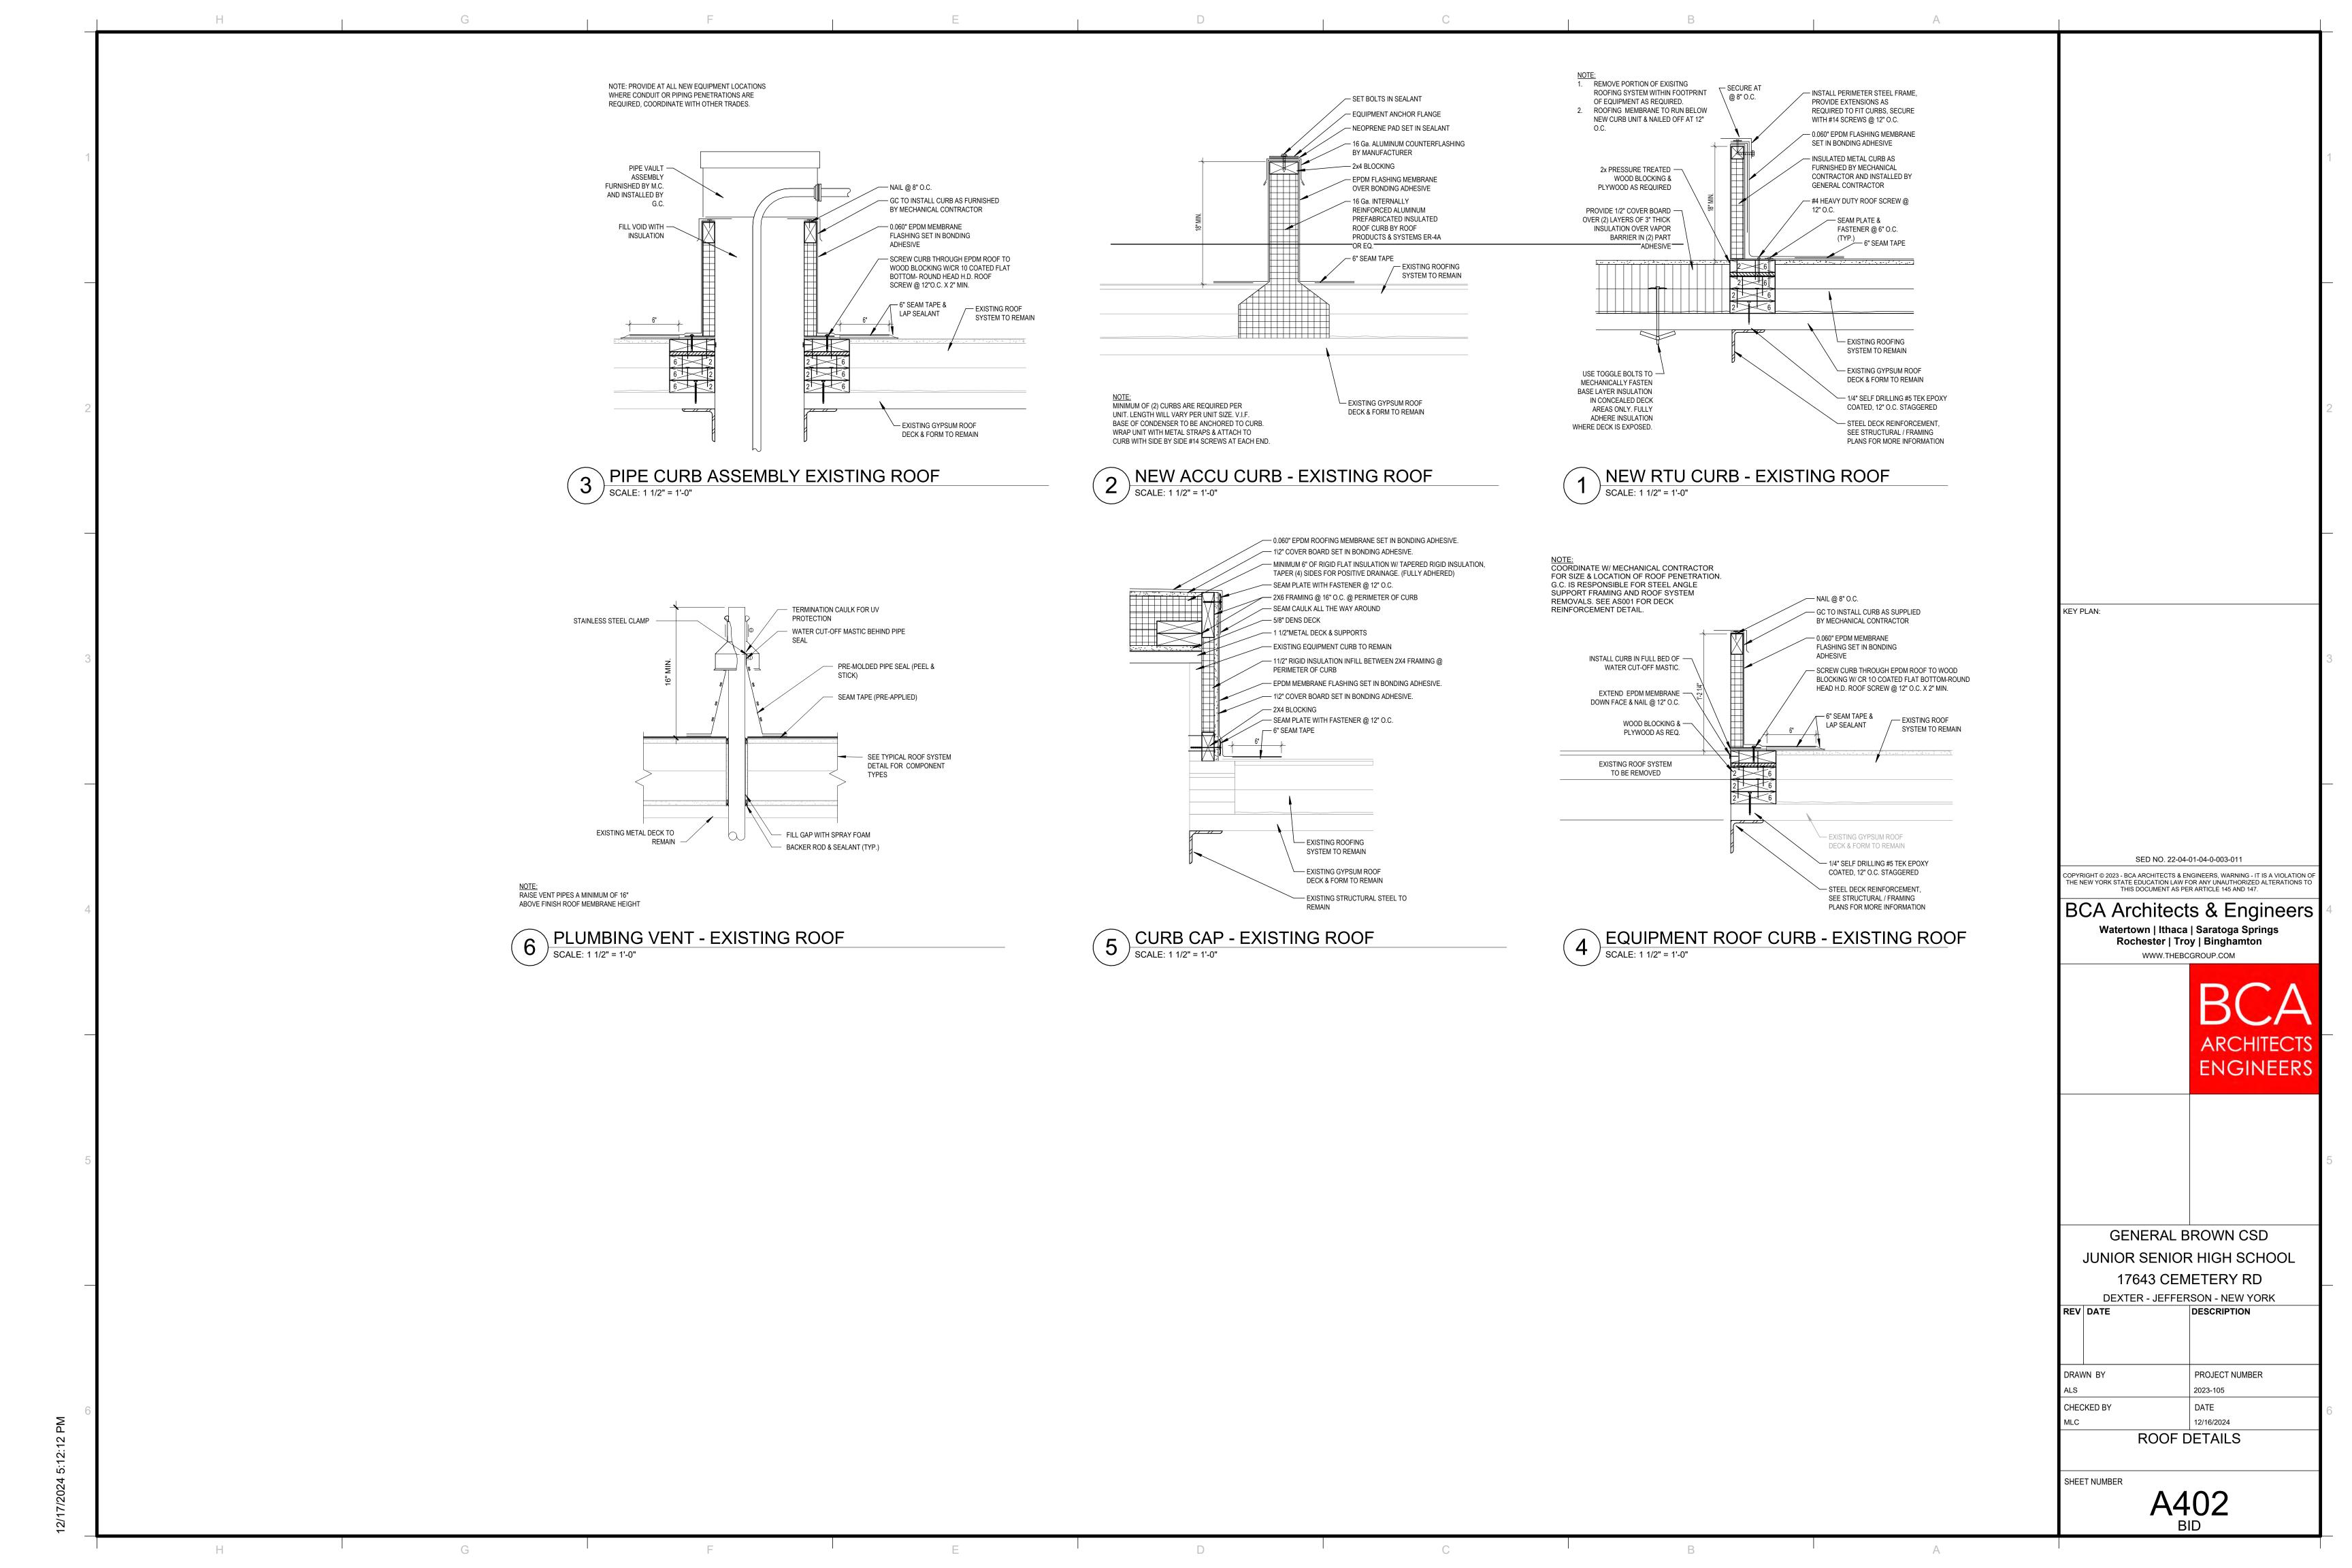


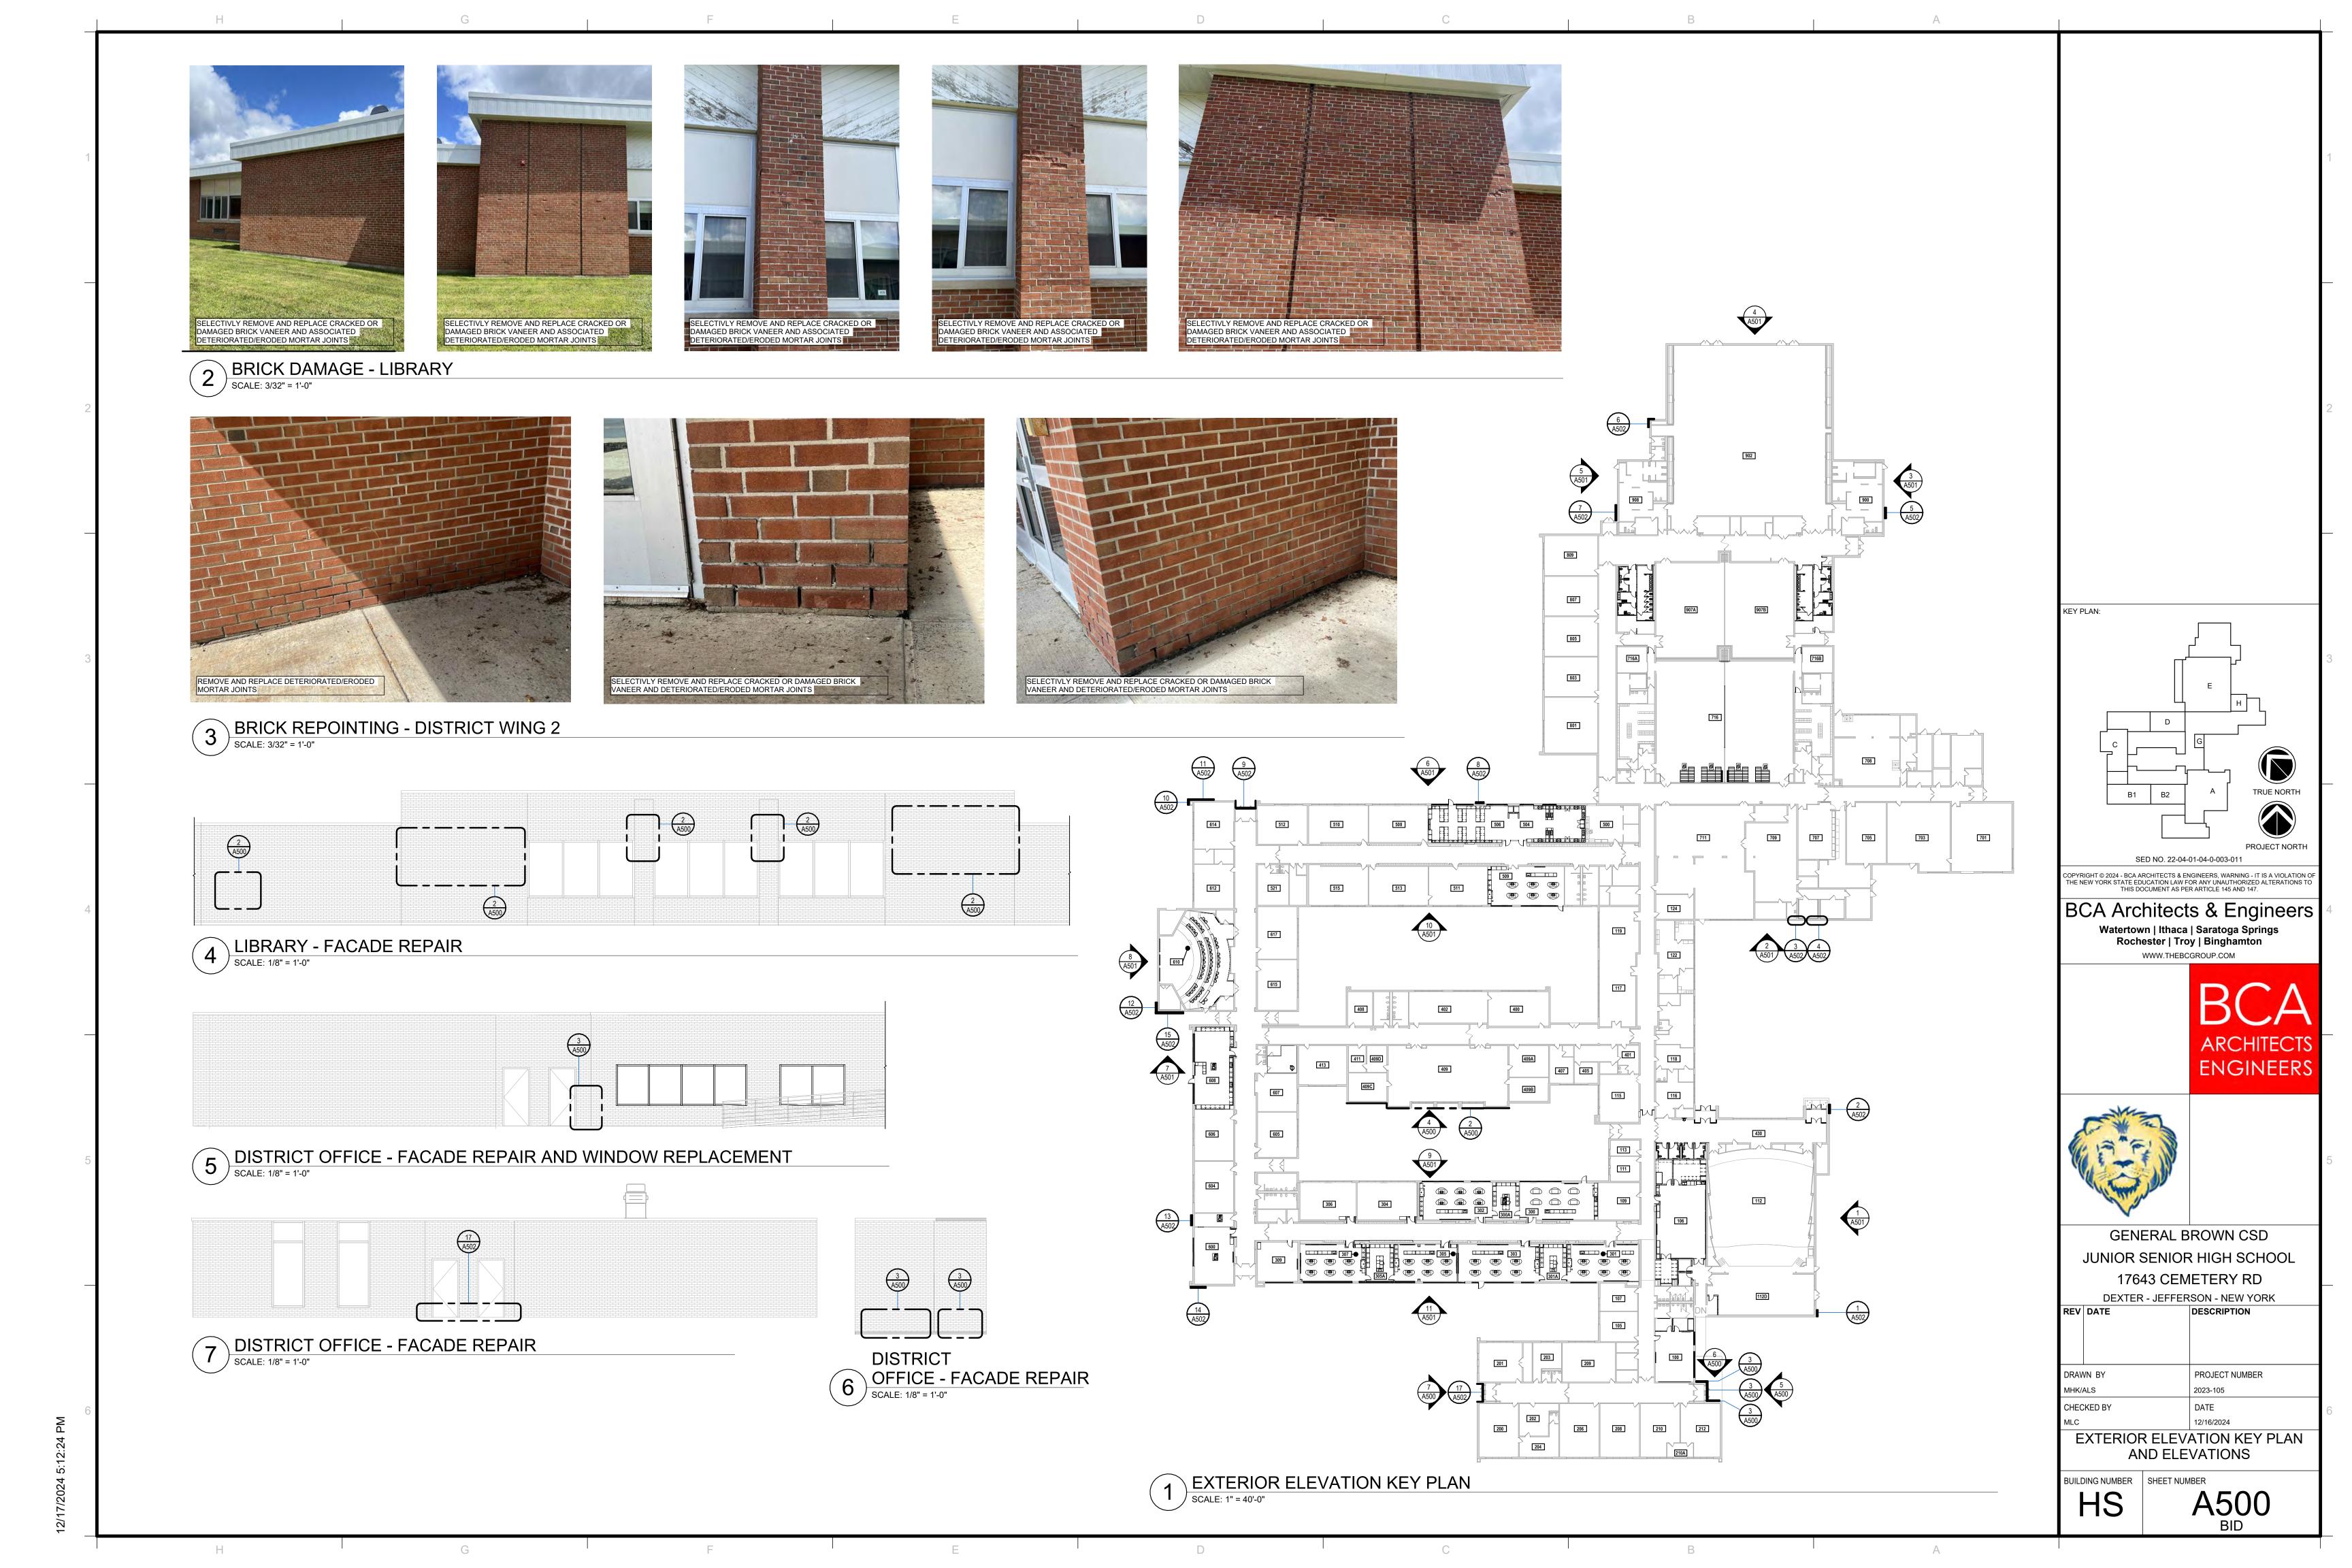


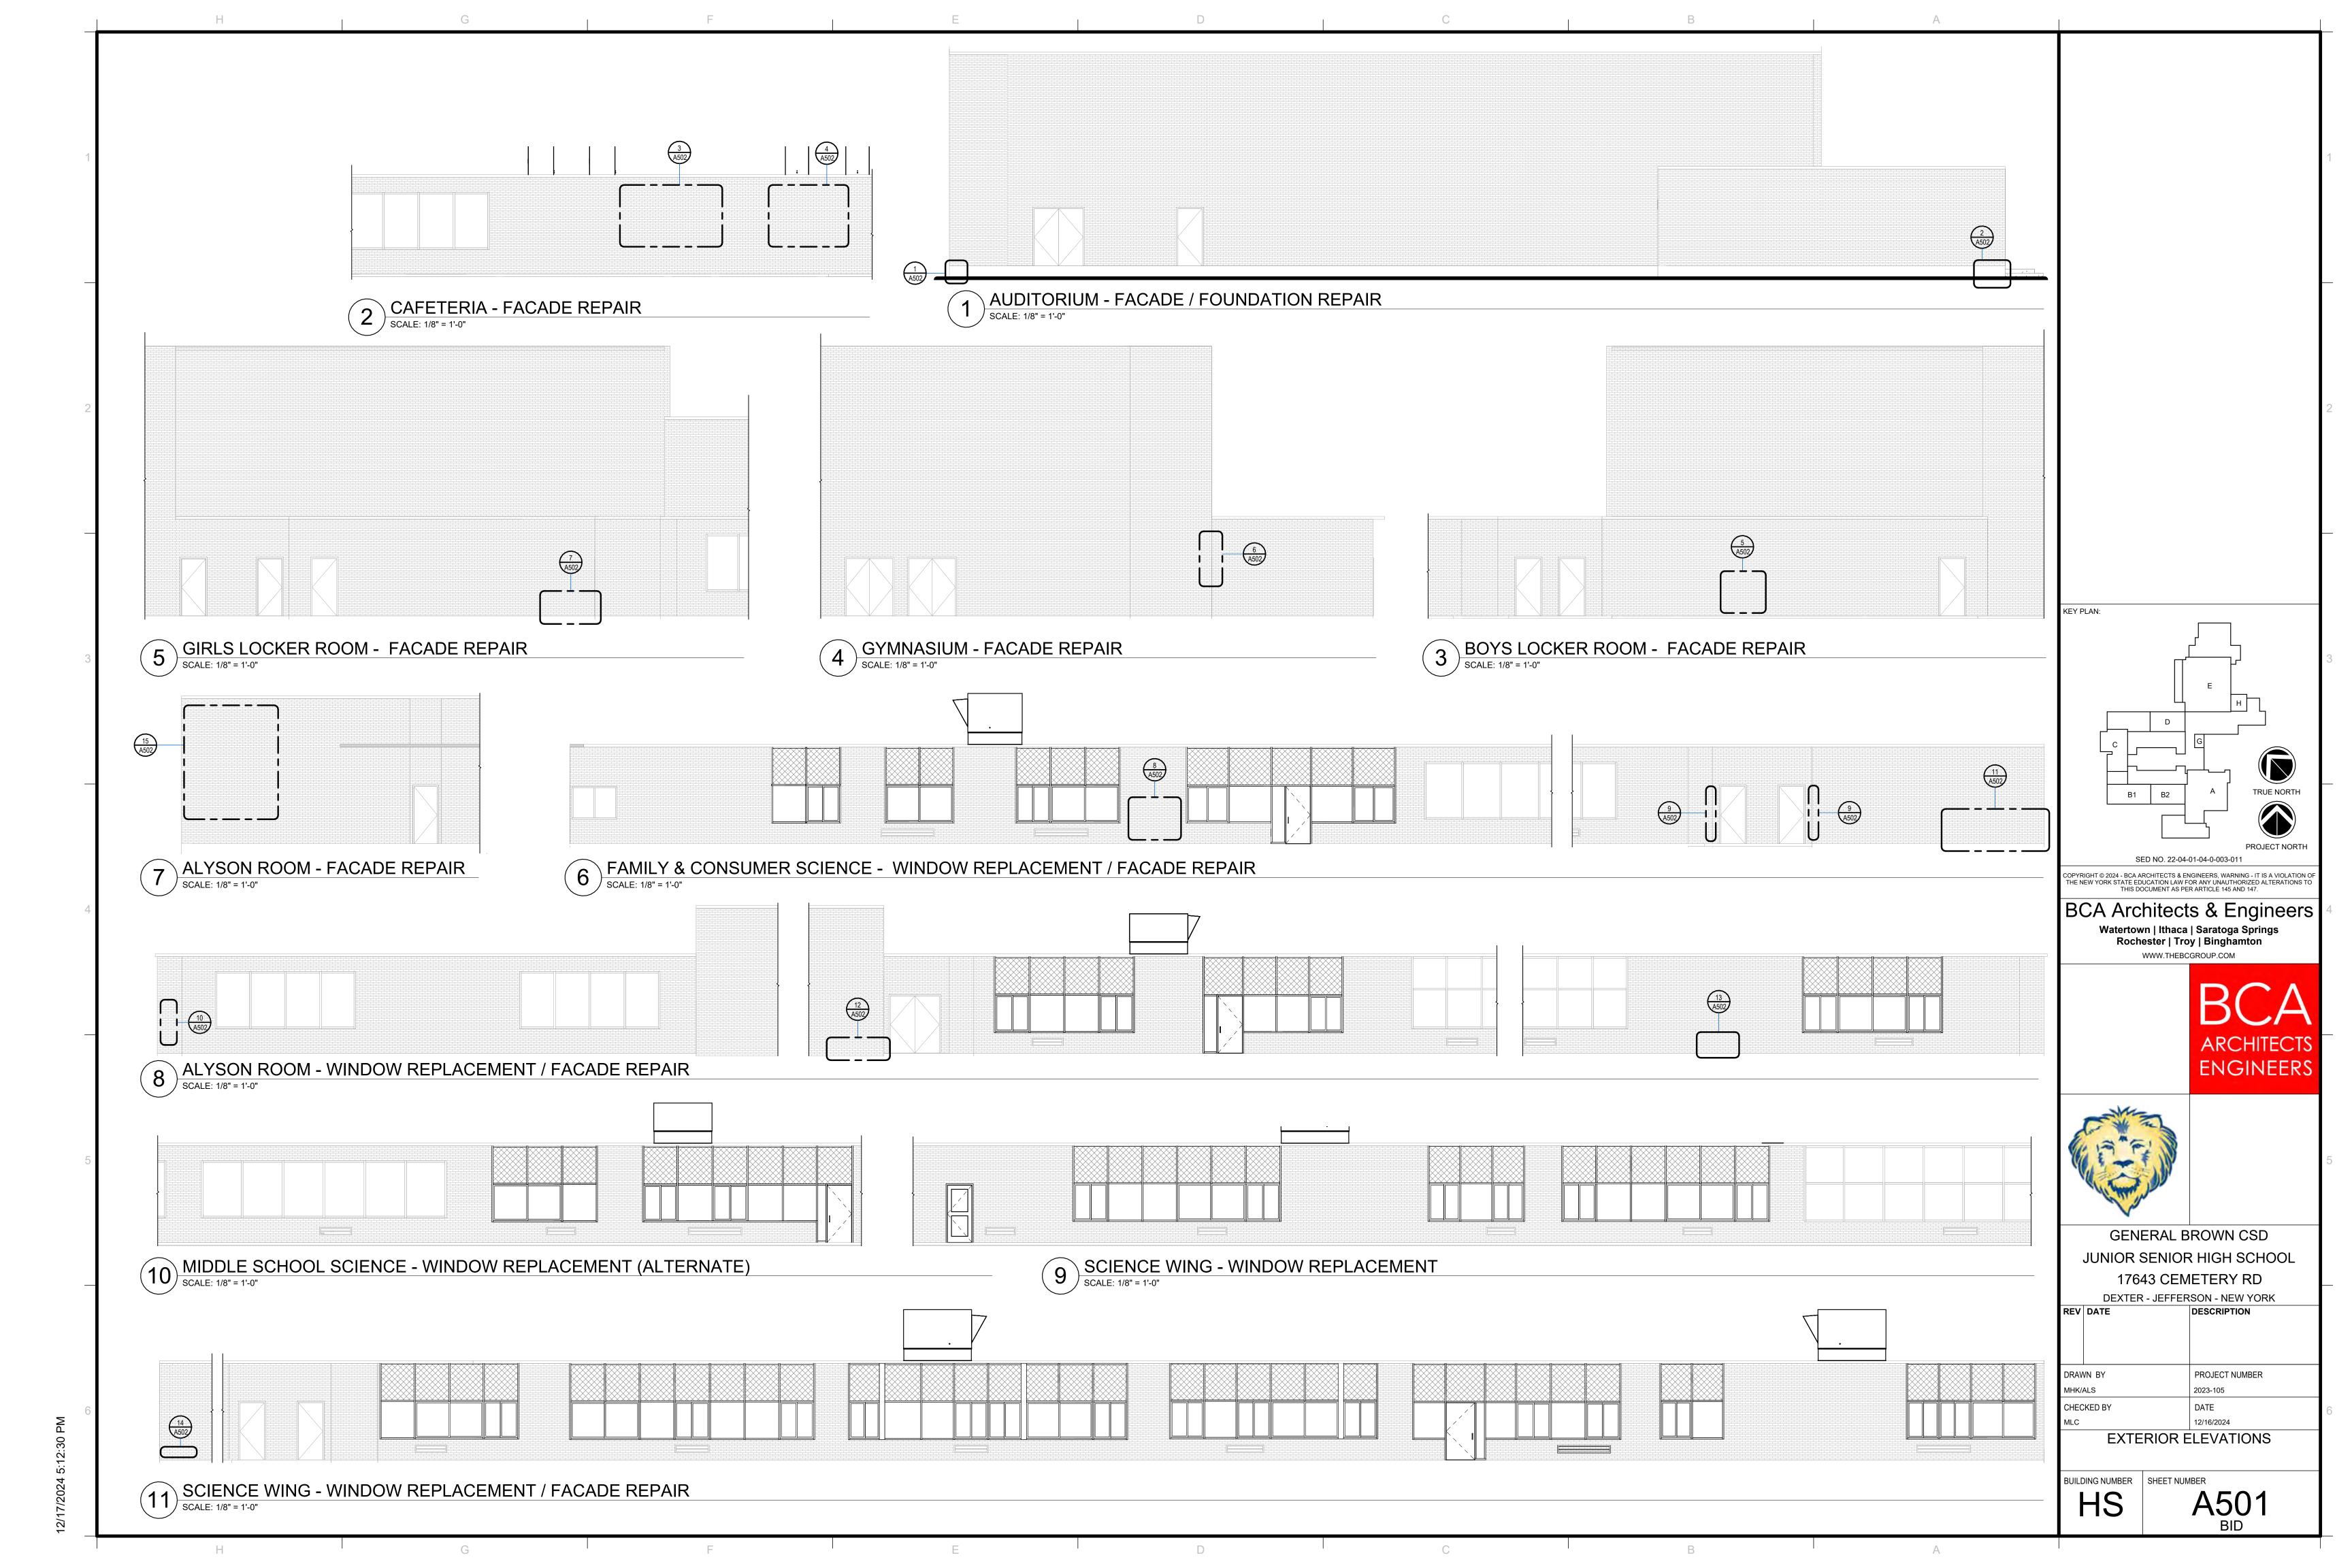




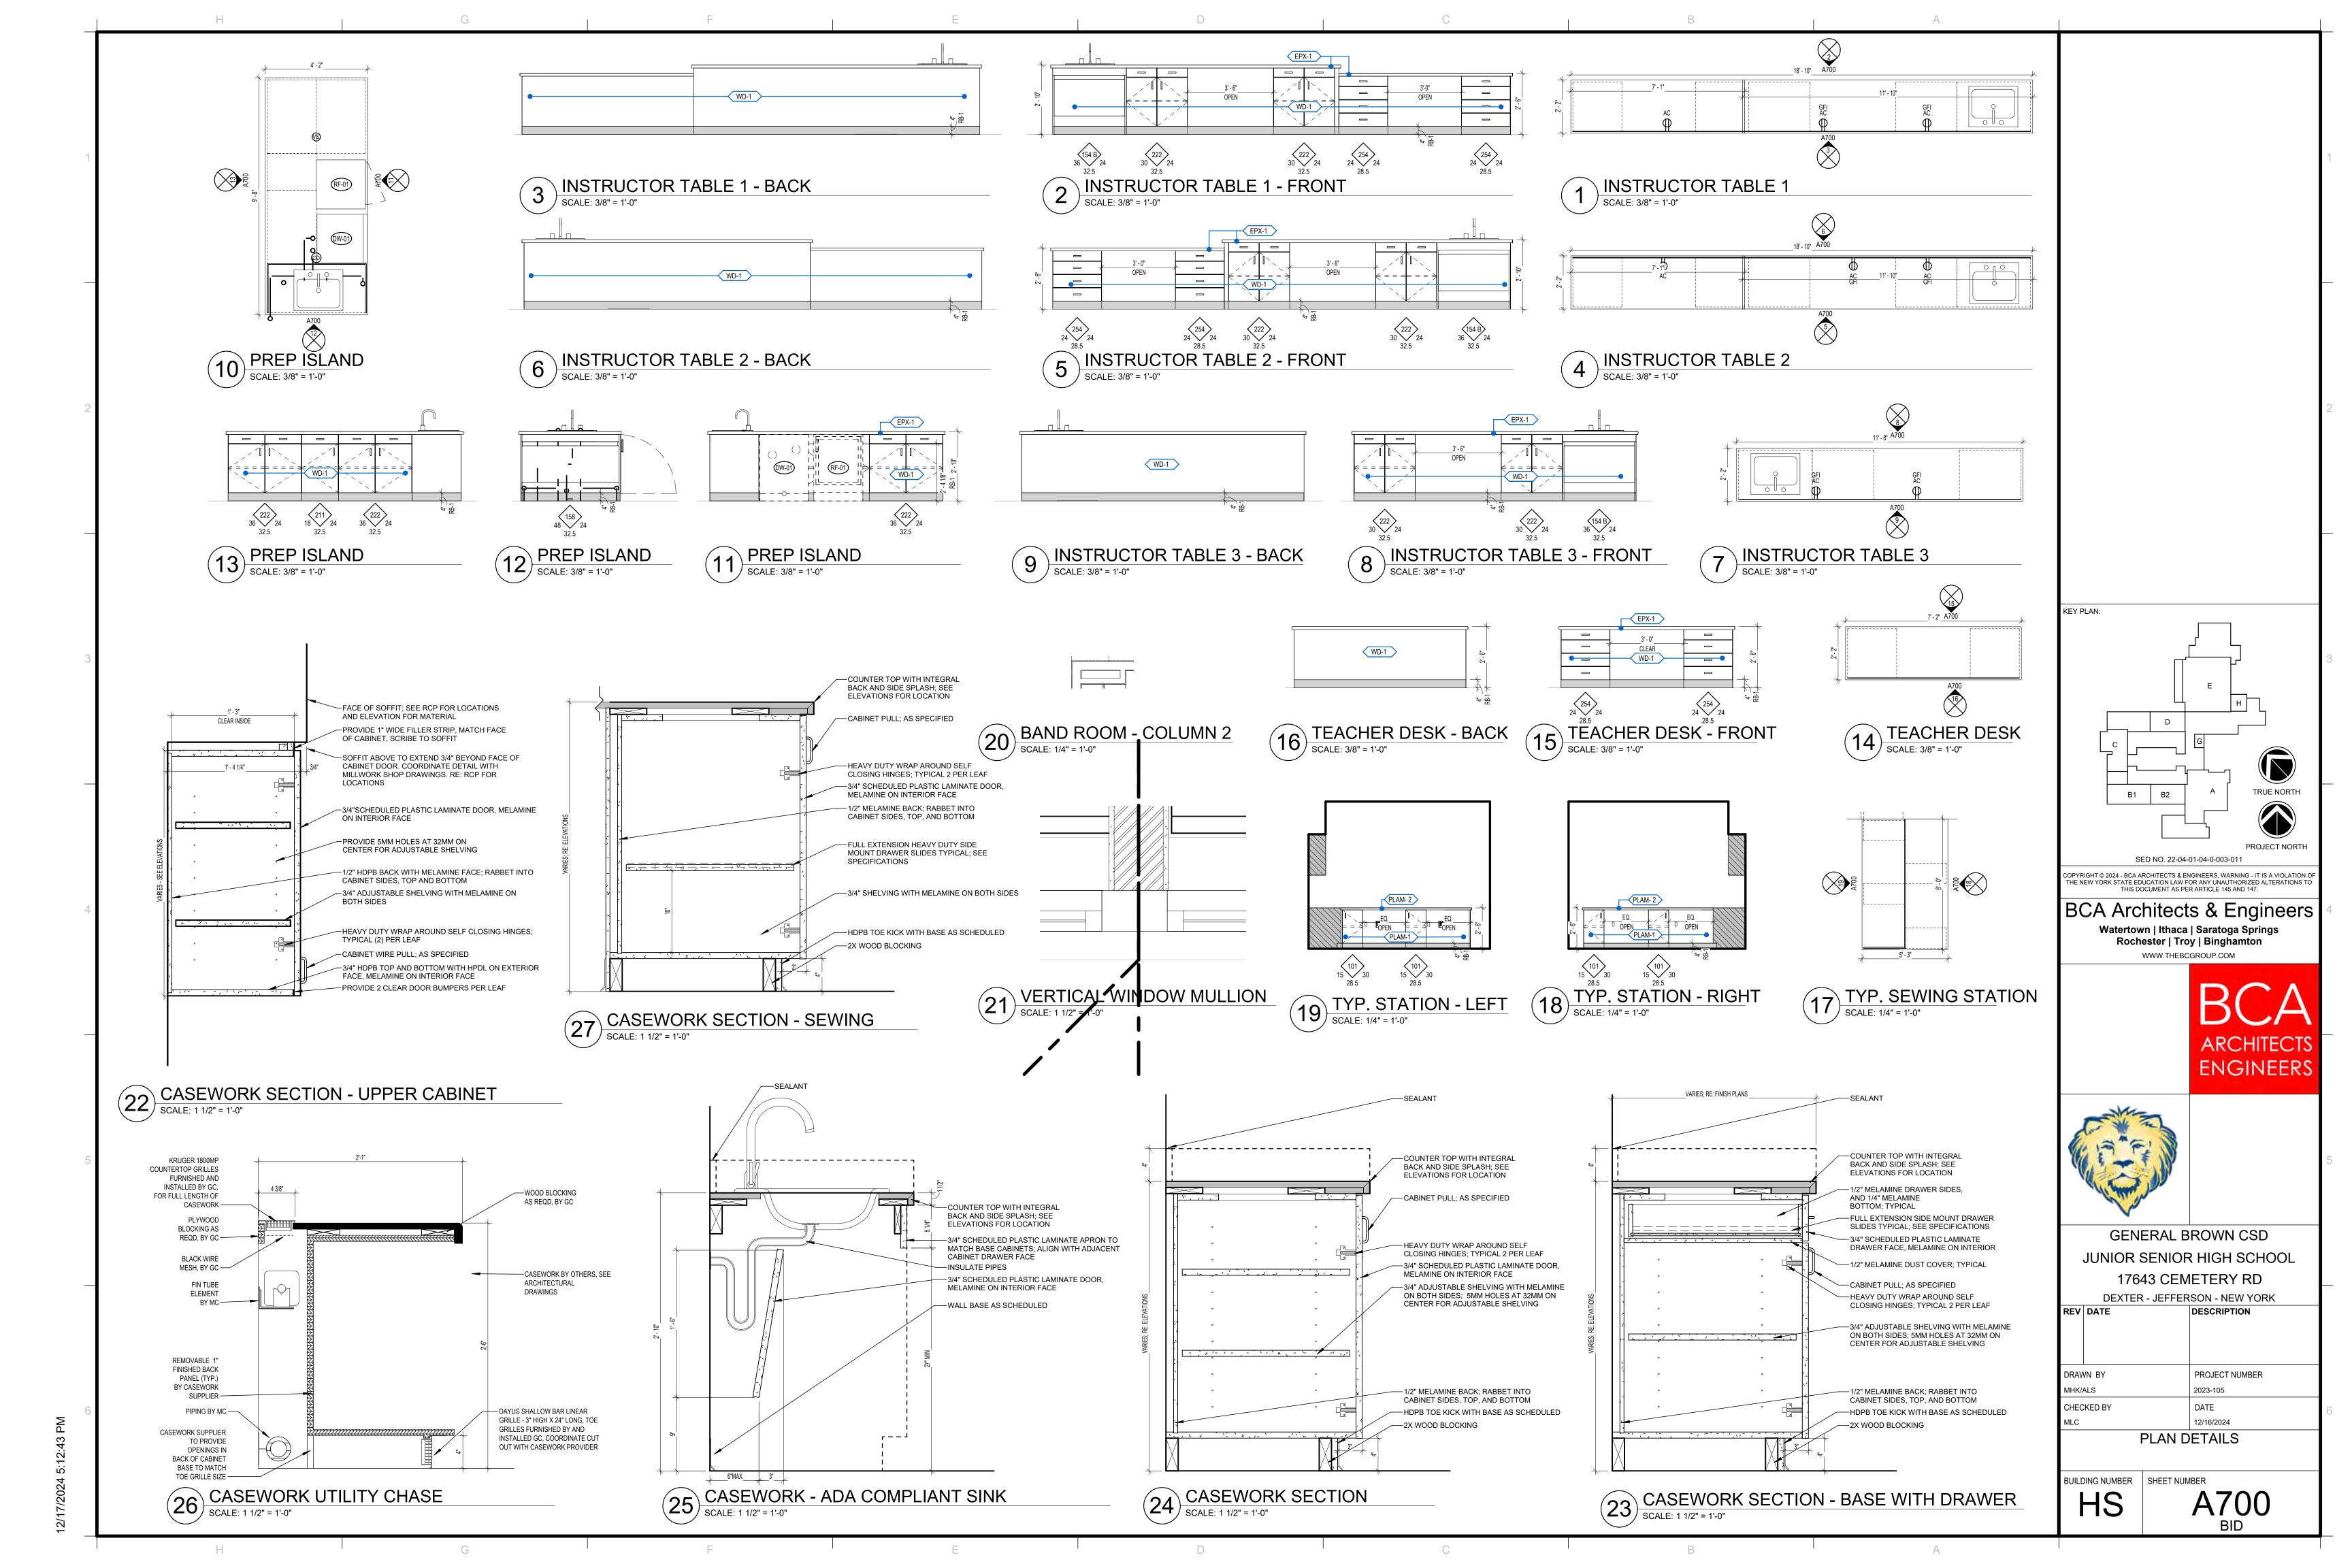

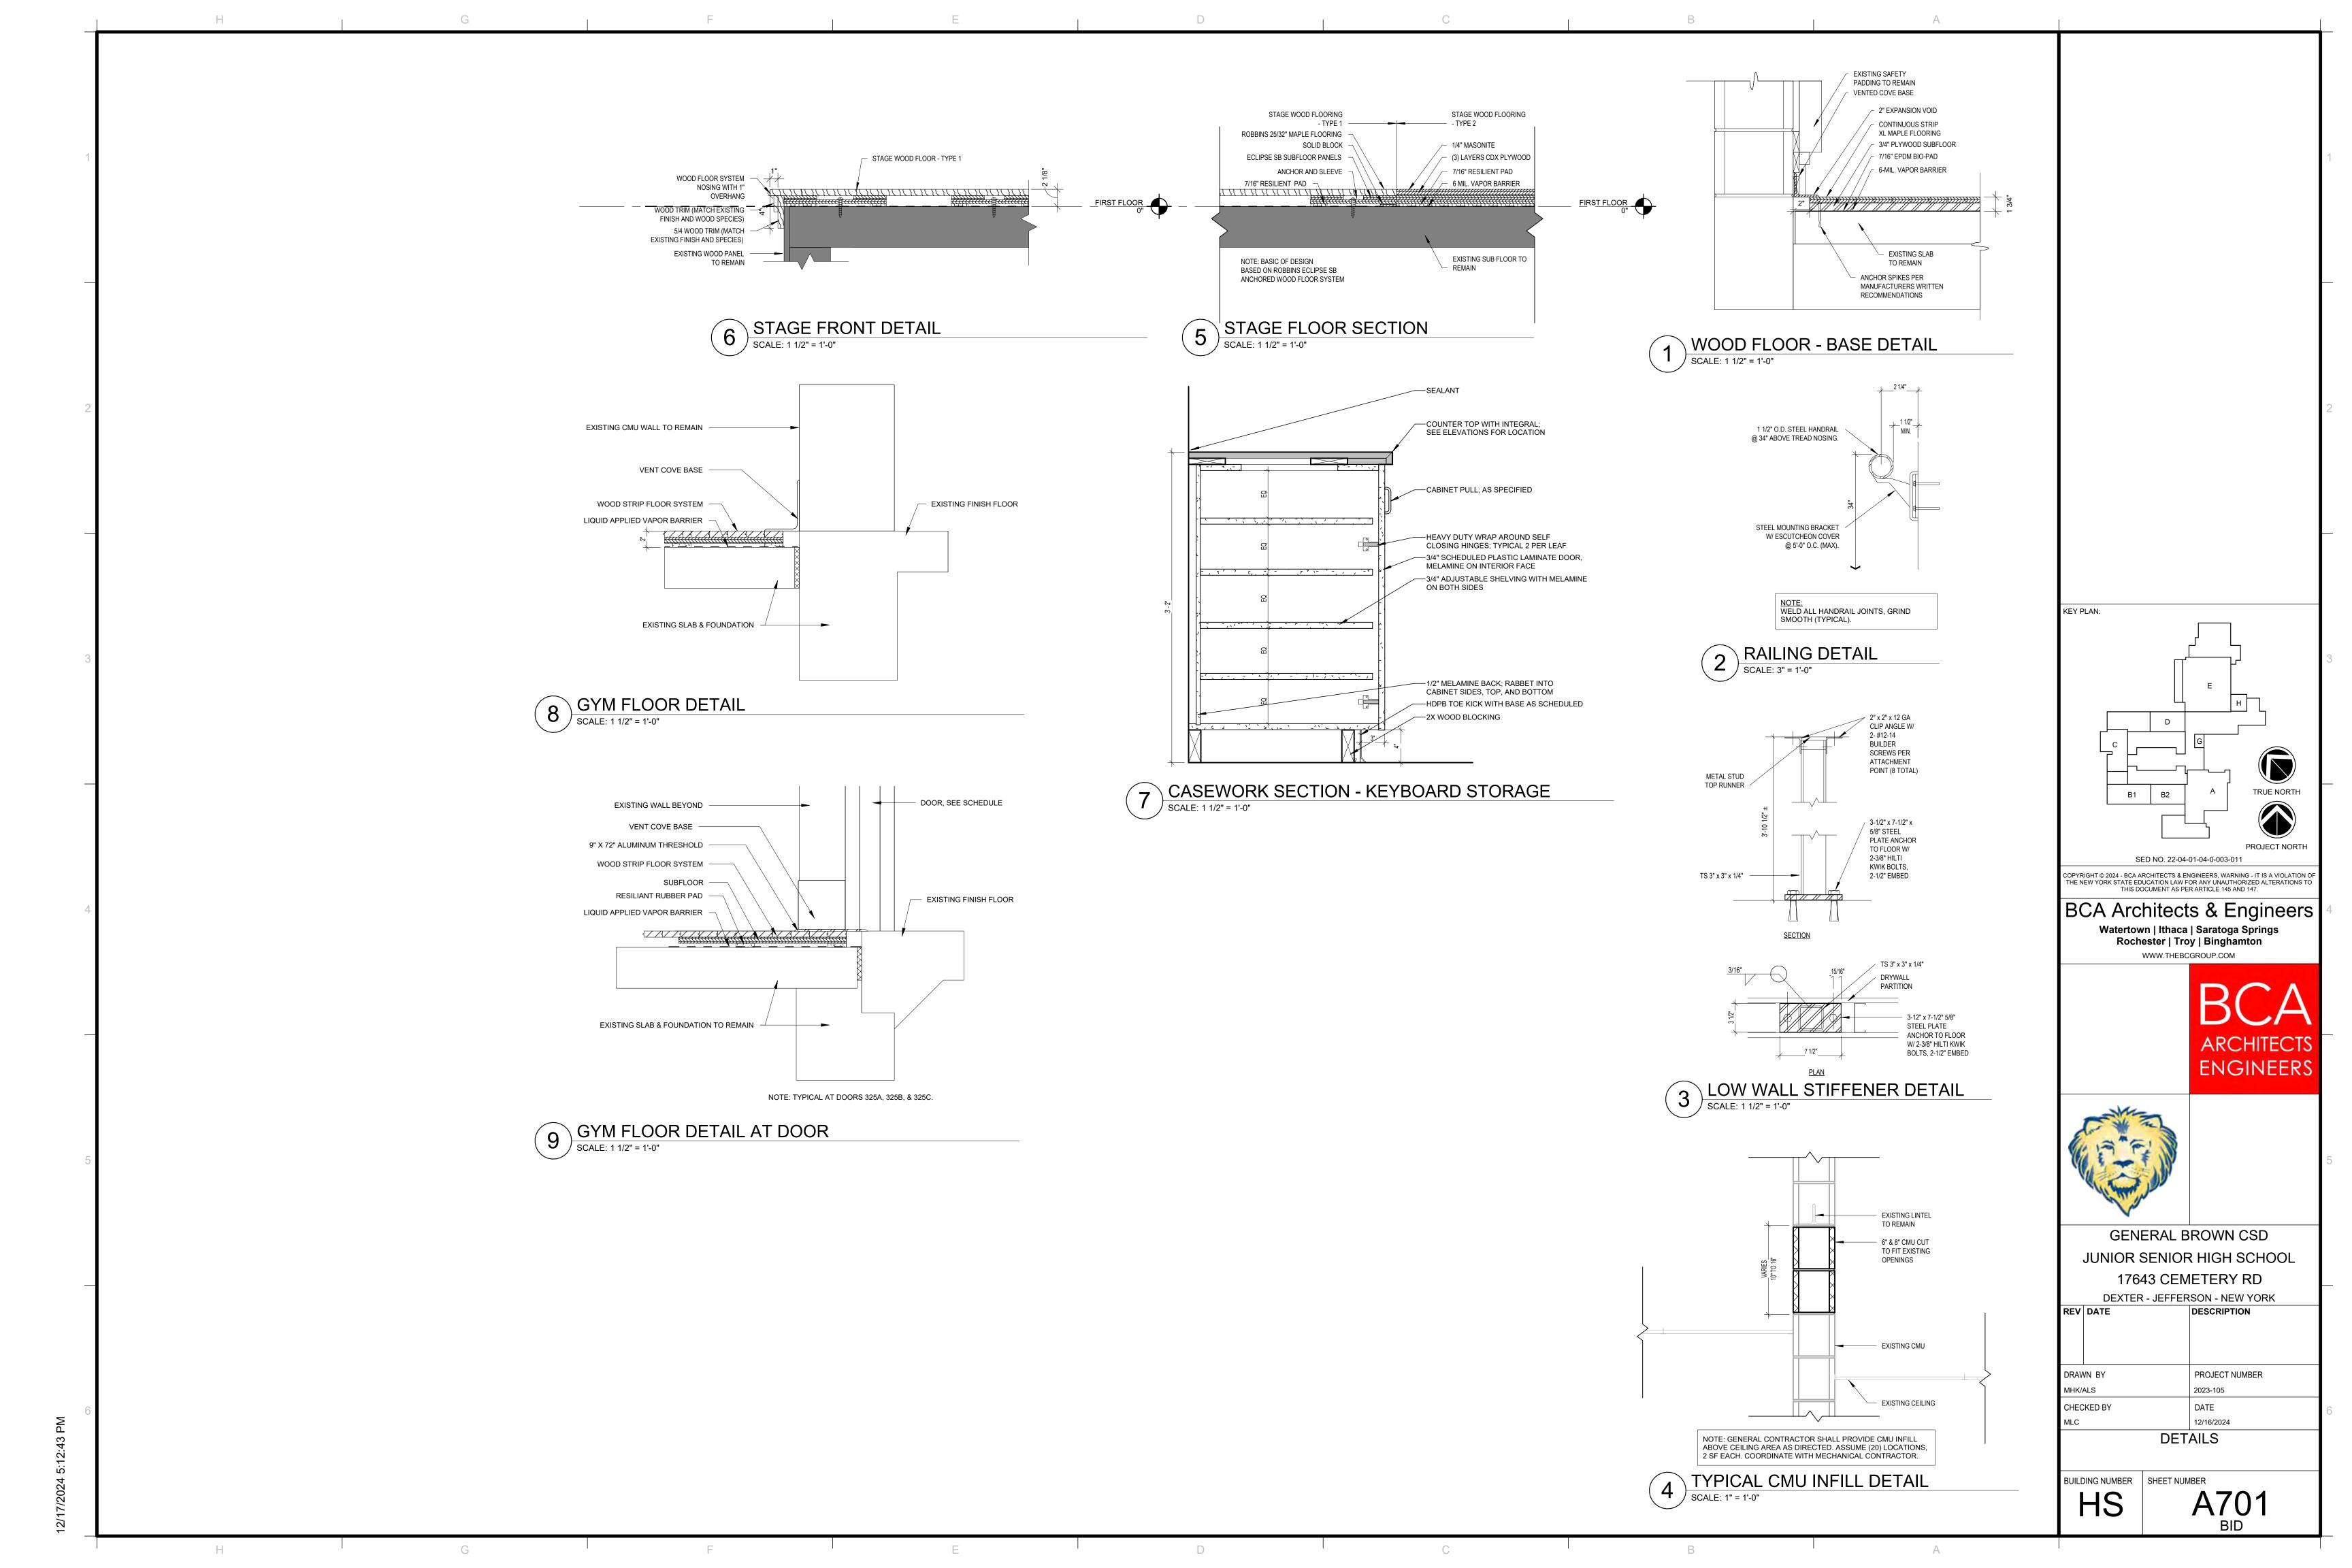

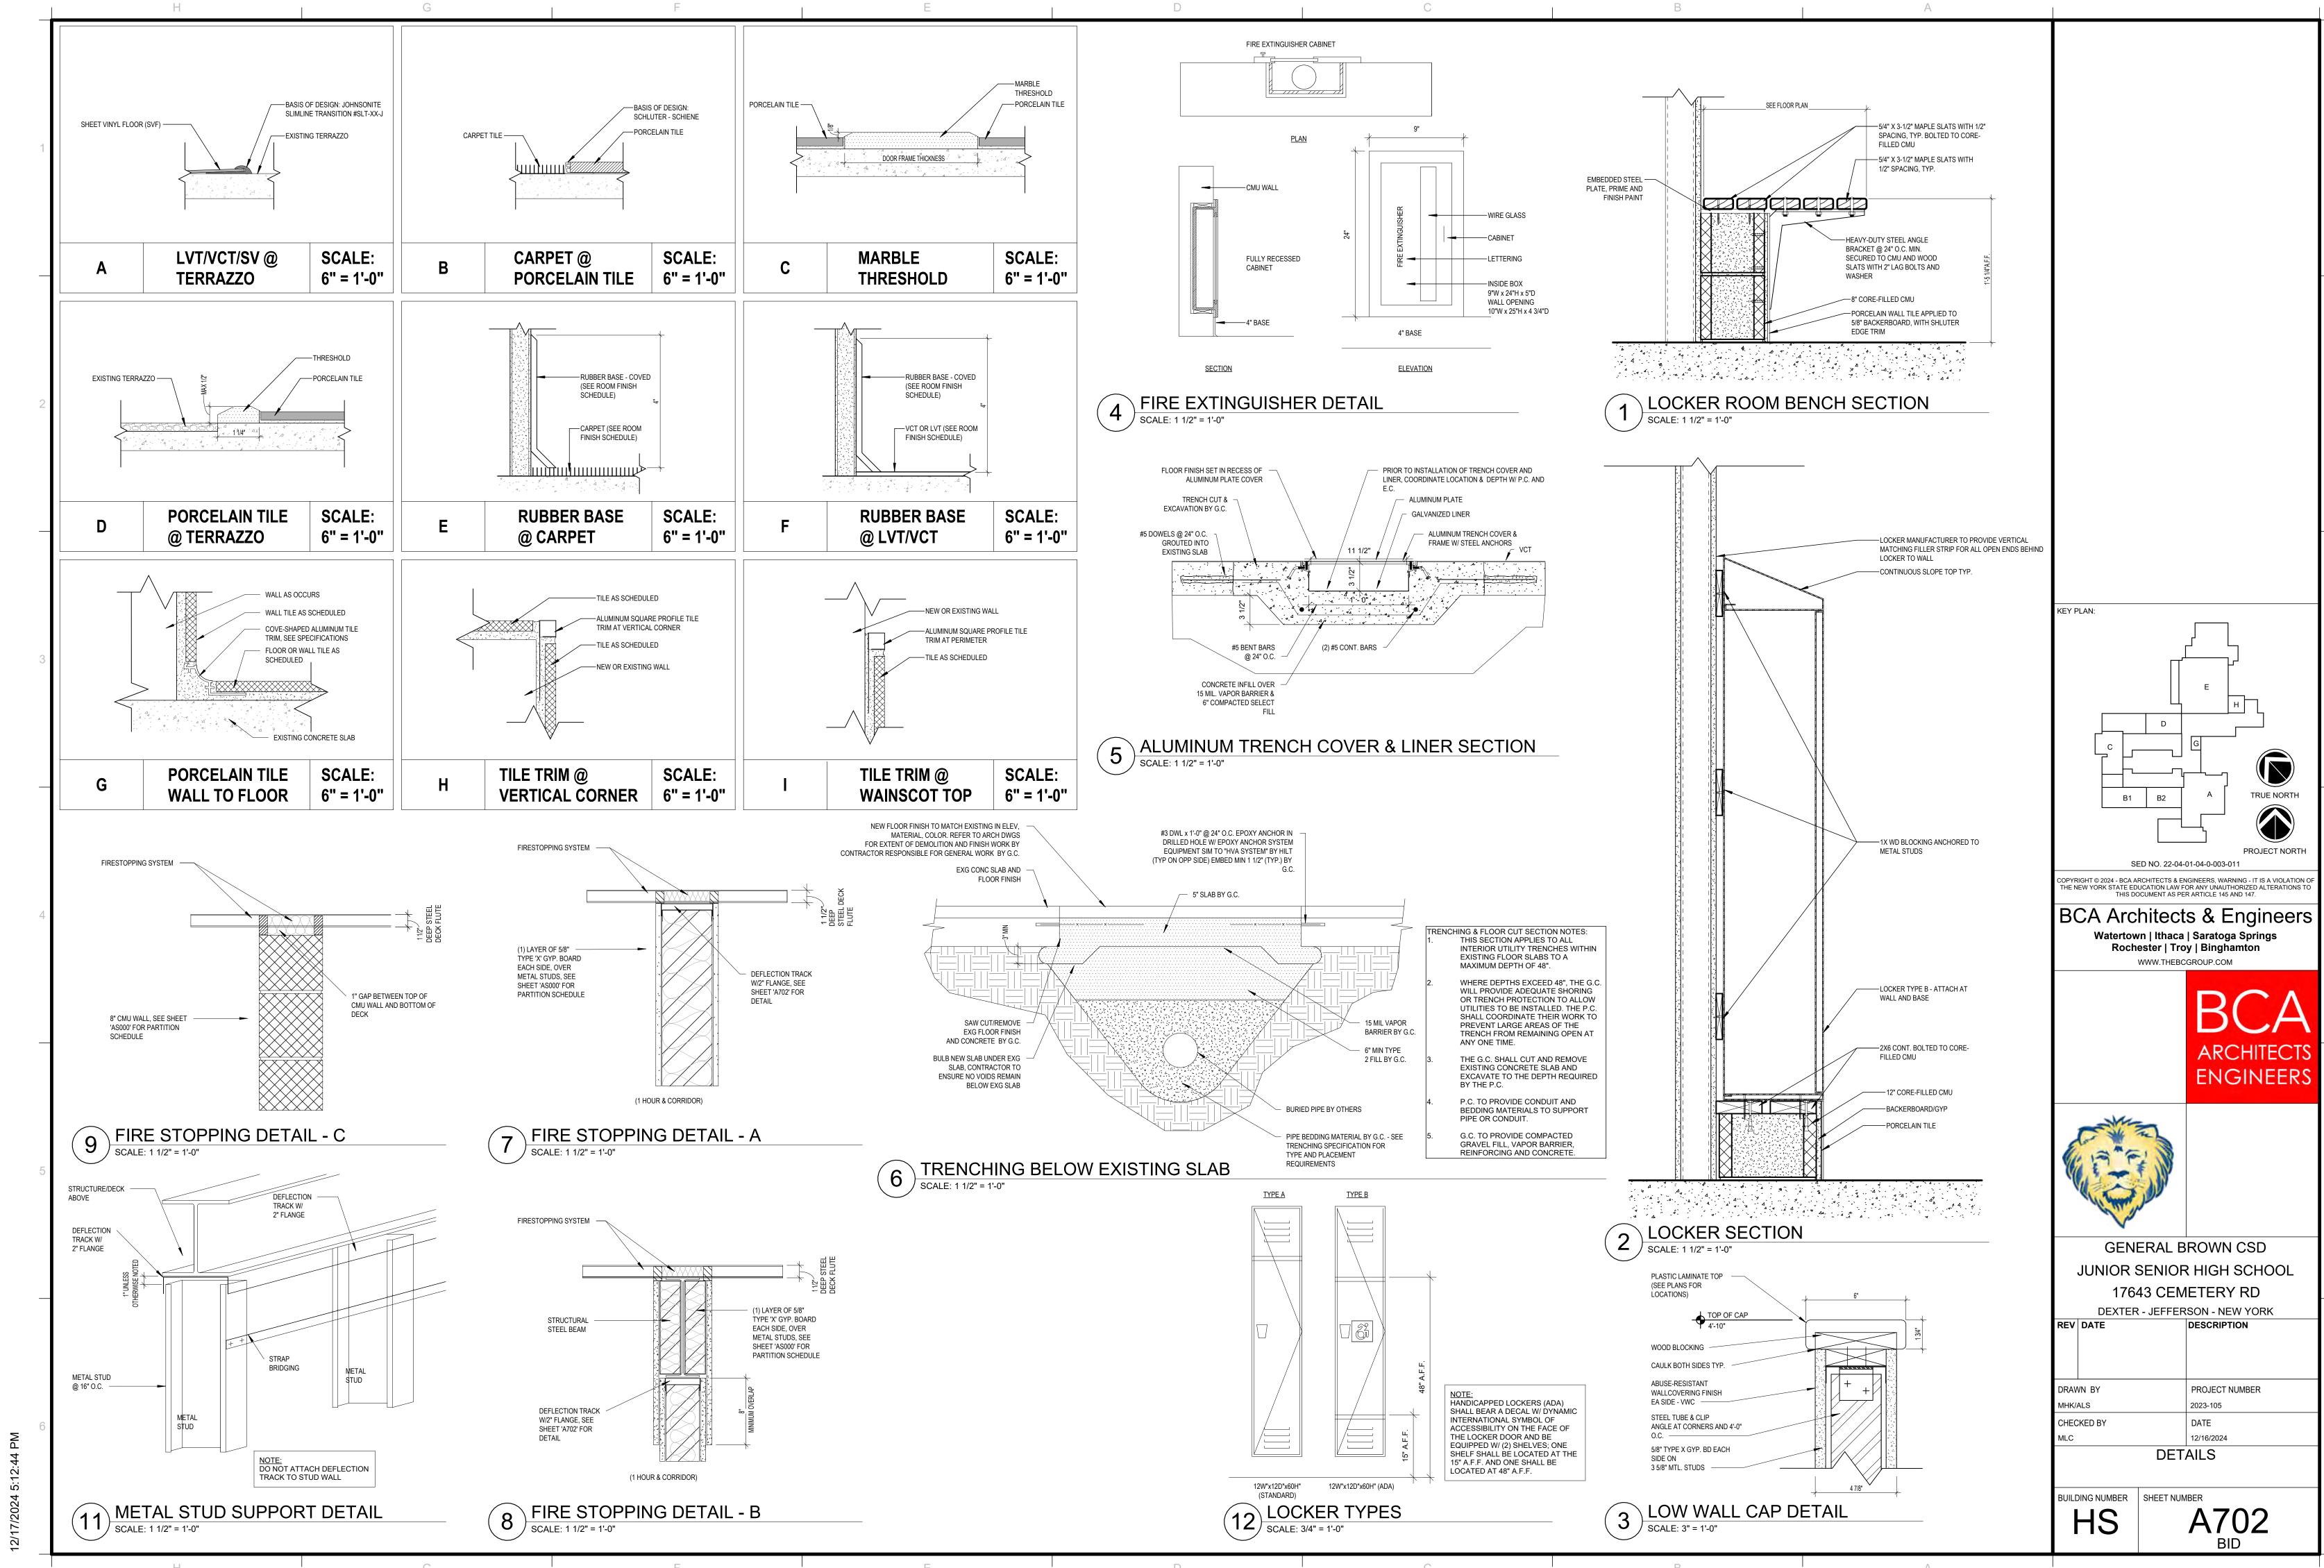

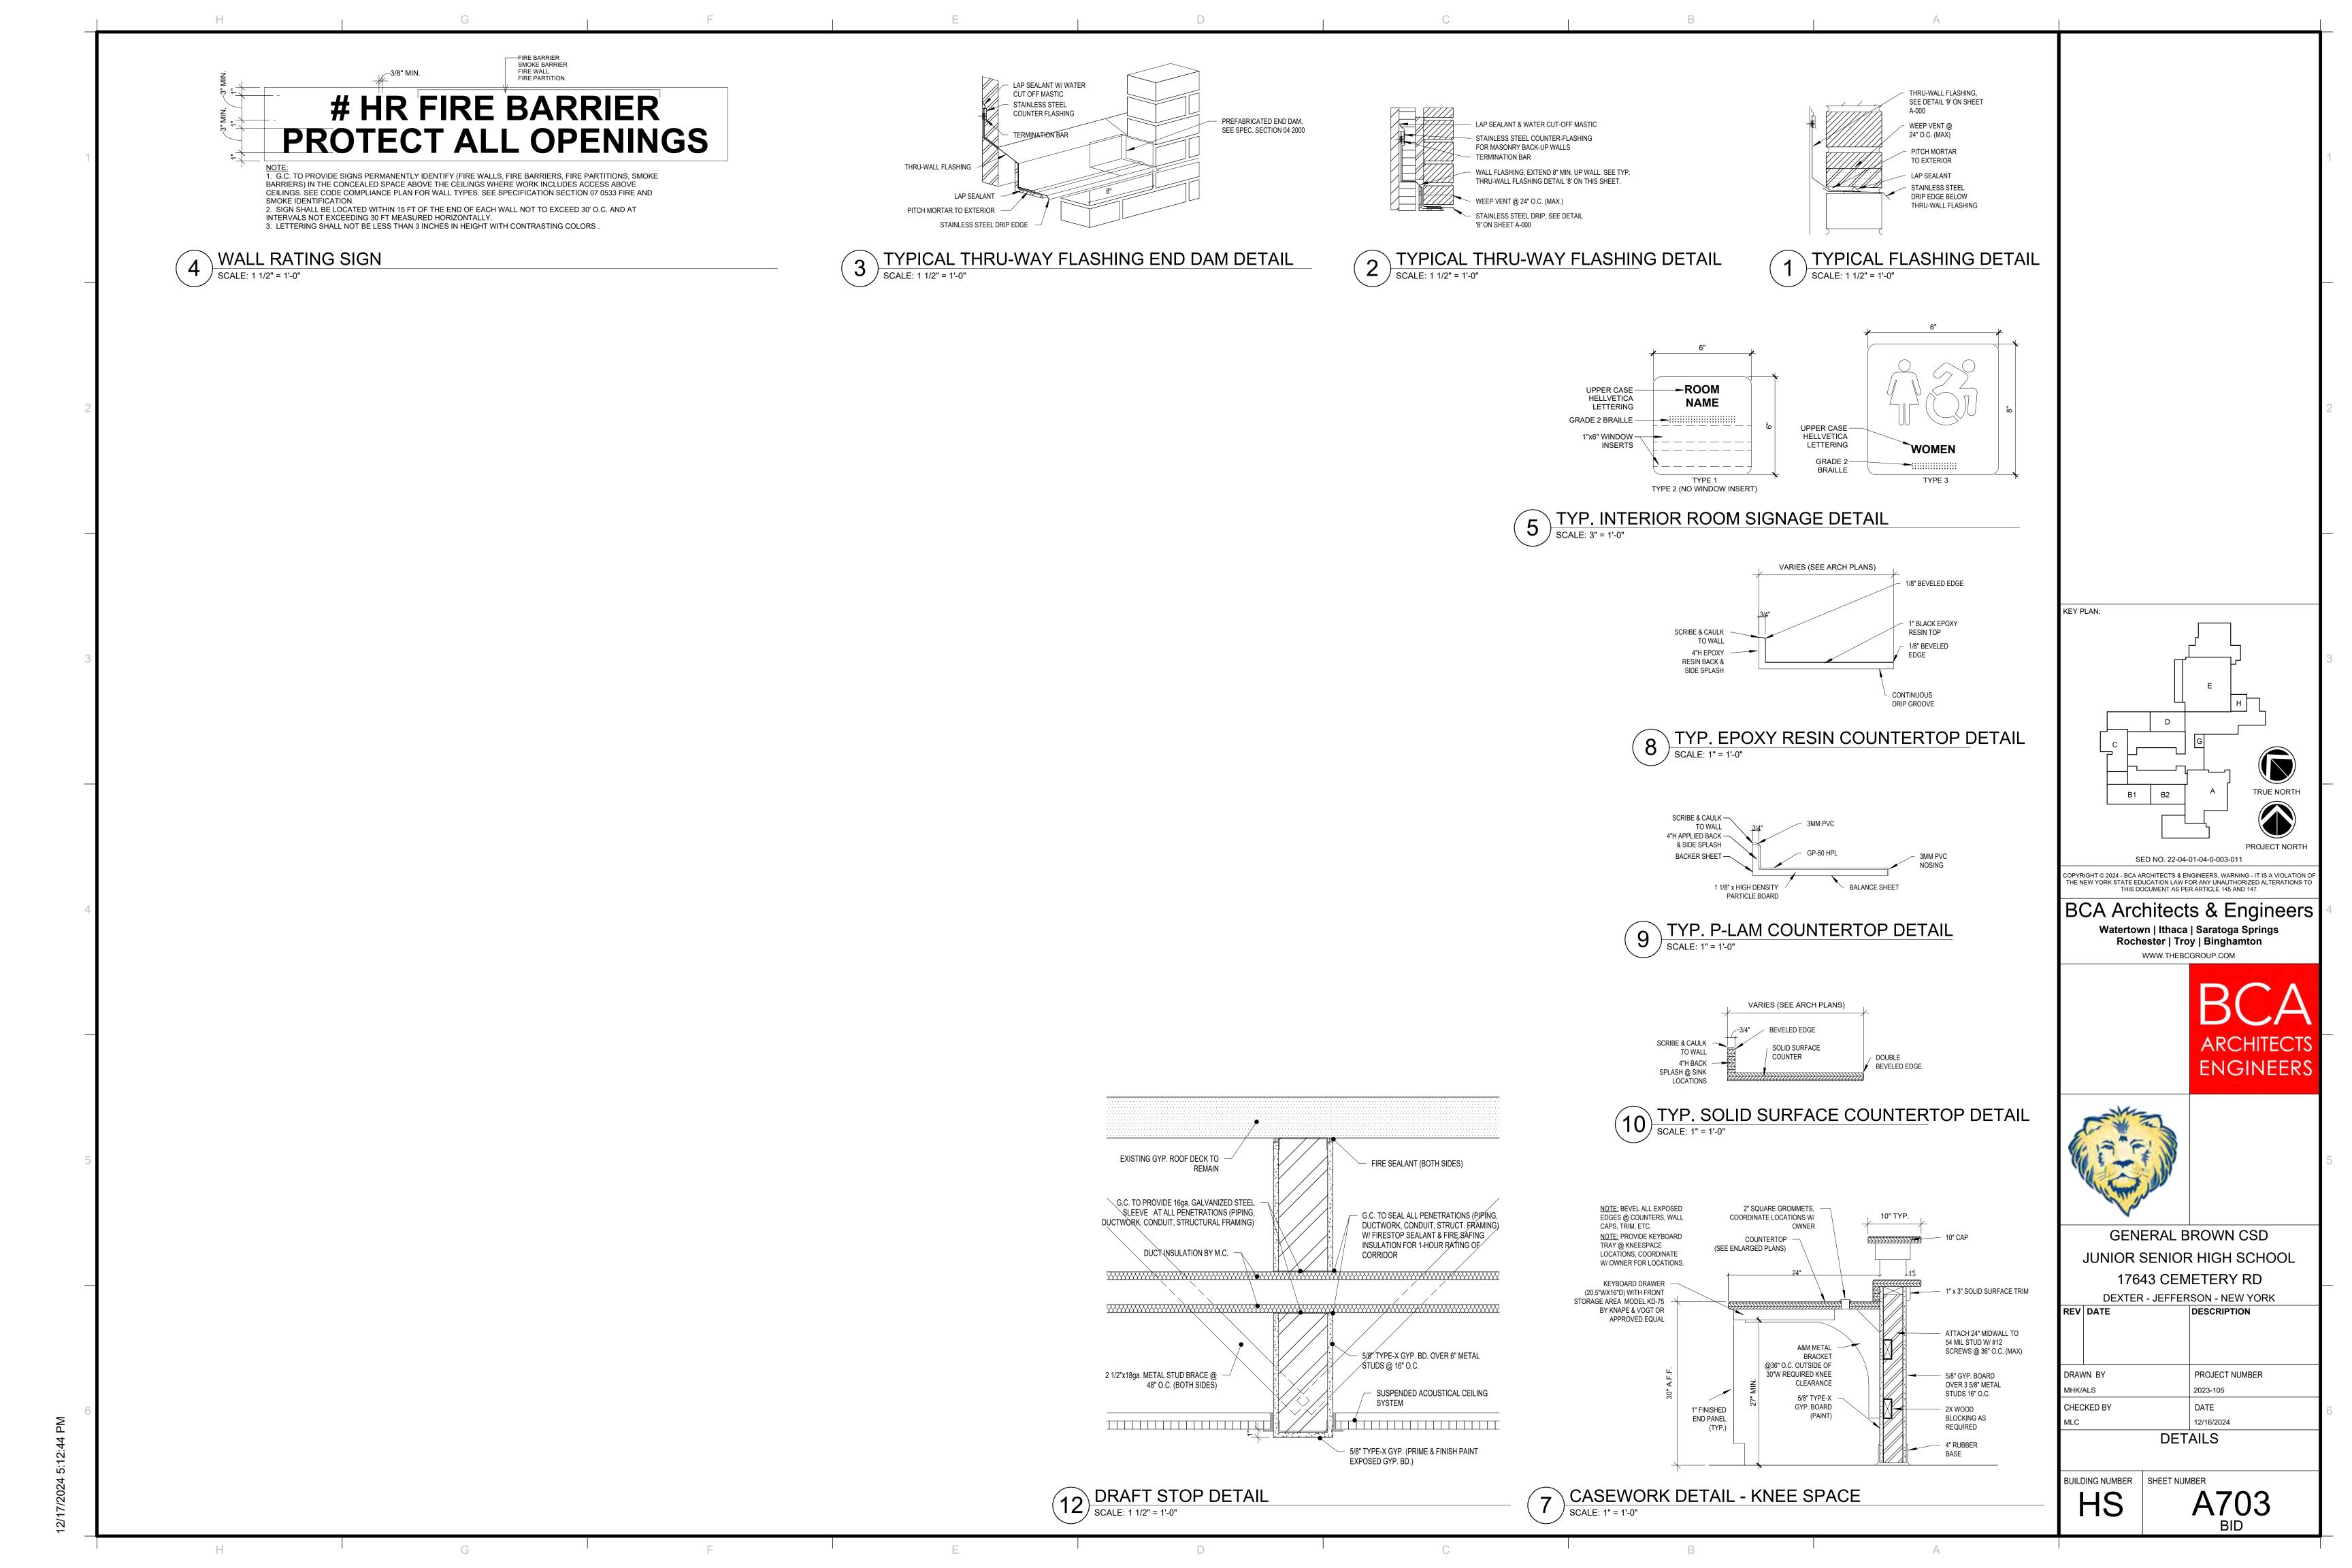

	Н									G													F												Е	
DOOR NUMBER		OFFICE CLASSROOM		ENIKANCE	PRIVACY STOREROOM	MAGNETIC LOCK CARD READER	COMBO STRIKE /STOP	ELECTRIC STRIKE (HEAD)		PANIC DEVICE (CHEXIT)	CONCEALED RODS		RS	BUTT - HEAVY DUTY BUTT - STANDARD	HINGE	=	<b>X</b>	KICK PLATES	MOP PLATES	FLOOR	ER	ASTRAGAL	COORDINATOR	ELECTRIC DOOR OPERATOR	EDGE PROTECTION	FLUSH BOLTS	GASKETING - SIGHT	GASKET-ACOUSTIC		MAGNETIC HOLD OPEN	PUSH/PULL SAFFTY SFNSOR			ELECTRIC LATCH RETRACTION	HARDWARE COMMENTS	
100/A 100A/A	VOCAL MUSIC PRACTICE ROOM		•									•		•			+	•	•	•	•							•	•			11'	• •			
100B/A	STORAGE		•											•				•	•		•											•	•			
	BAND ROOM CORRIDOR		•						9	•	•	•		•	•			•	•		•							•	•				• •			
	STORAGE	•										•		•			t	•	•		•							_	• •				•			
	STORAGE		•									•		•				•	•		•								• •				•			
	STORAGE PRACTICE ROOM	•			•							•		•			ł	•	•		•							•	•				•			
106E/A	PRACTICE ROOM				•							•		•			1	•	•		•							•	•				•			
108/A 108/B	TOILET TOILET				•							•		•			+	•	•		•								•			_	• •			
108/C	TOILET				•							•		•				•	•		•								•			•	• •			
108/D 154/A	TOILET CORRIDOR			•	•				-			•		•			+	•	•		•								•				• •			
157/A	CORRIDOR			•					-	•	•	•		•			t		•		•								•				•			
	BOY'S LOCKER ROOM PHYSICS	•	•									•		•				•	•		•								•				•			
	PHYSICS			•							•			-	•																		• •			
	PREP		•									•		•					•													$\perp$	•			
	PREP LIVING ENVIRONMNET		•									•		•			+	•											•				•			
	PREP		•									•		•				•	•		•											•	•			
	PREP CHEMISTRY		•									•		•			+		•		•								•				•			
	BIOLOGY		•									•		•			t	•	•		•								•				• •			
	BIOLOGY			•					•	•	•				•																		• •			
	CLASSROOM EARTH SCIENCE		•									•		•			+	•	•		•								•				• •		ALTERNATE	
	PREP		•									•					1	•	•	•													•			
	PREP CLASSROOM		•									•		•			+		•	•	+								•				•		ALTERNATE	
	EARTH SCIENCE		•									•		•				•	-		•								•				• •		ALIERNATE	
	CLASSROOM		•									•		•			1		•	•									•				• •			
	CORRIDOR VESTIBULE			•					- 1	•	•	•			•		+	•	•	•							,		•	•	•		•	•		
	LOBBY			•						•	•	•			•		•			•	,										•		•	•		
	VESTIBULE			•					-	•	٠	•			•		•			•						-		_			•	+	•	•		
	LOBBY CULINARY		•	•						•	•	•		•	•		+	•	•	•	•						•		•		•		•	•		
	SEWING		•									•		•				•	•		•								•				• •			
	SEWING 8TH GRADE SCIENCE		•	•					•	•	•	•		•	•		-	•	•							,	•		•		•		• •		ALTERNATE	
	CLASSROOM		•									•		•			t	•	•		•								•				• •		ALILINVAIL	
	ART ROOM		•									•		•					•		•								•				• •			
	MENS RESTROOM STORAGE		•		•							•		•	•			•	•		•								•				• •			
905B/A	TOILET				•							•		•					1		•								•				• •			
	TOILET LOCKER/ CHANGING				•							•		•					•		•								•				• •			
	GENDER NEUTRAL TOILET/ SHOWER				•									•				•			•												•			
	STORAGE				•							•		•					•		•								•				•			
	PASSAGE WOMENS RESTROOM	•	•						•		•	•		•	•		+		+		•								•				•	•		
909A/A	TOILET				•							•		•					·		•								•				• •			
	TOILET LOCKER/ CHANGING				•							•		•					•		•								•			+	• •	_		
	GENDER NEUTRAL TOILET/ SHOWER				•									•				•	-		•												•			
909E/A	PASSAGE	•							(		•	•		•				•	٠		•								•	•			•	•		
1																																				

									OR SCHE				
DO044445	DOOR	7.05	\4#B#!!	DOOR SIZE		DOOR	01.470.0	T) (D.E.	FRAME	DET		5105 0 4 7 11 10	NOTE:
ROOM NAME	NUMBER	TYPE	WIDTH	HEIGHT	THICKNESS	MATERIAL	GLAZING	TYPE	MATERIAL	HEAD	JAMB	FIRE RATING	NOTES
CORRIDOR	100/A	N	3'-0"	7'-0"	1 3/4"	WOOD	В	НМ	PT	H2	J2	45 MIN	
PRACTICE ROOM	100A/A	N	3'-0"	7'-0"	1 3/4"	WOOD	B	HM	PT	H1	 J1	-	
STORAGE	100B/A	F	3'-0"	7'-0"	1 3/4"	WOOD	-	НМ	PT	H1	J1	-	
BAND ROOM	106/A	N	3'-0"	7'-0"	1 3/4"	WOOD	В	НМ	PT	H2	J2	45 MIN	
CORRIDOR	106/B	N	6'-0"	7'-0"	1 3/4"	WOOD	В	НМ	PT	H3	J3	45 MIN	
STORAGE	106A/A	F	3'-0"	7'-0"	1 3/4"	WOOD	-	НМ	PT	H1	J1	45 MIN	
STORAGE	106B/A	F	3'-0"	7'-0"	1 3/4"	WOOD	-	НМ	PT	H1	J1	45 MIN	
STORAGE	106C/A	F	6'-0"	7'-0"	1 3/4"	WOOD	-	НМ	PT	Н3	J3	45MIN	
PRACTICE ROOM	106D/A	N	3'-0"	7'-0"	1 3/4"	WOOD	В	НМ	PT	H1	J1	45 MIN	
PRACTICE ROOM	106E/A	N	3'-0"	7'-0"	1 3/4"	WOOD	В	НМ	PT	H1	J1	45 MIN	
TOILET	108/A	F	3'-0"	7'-0"	1 3/4"	WOOD	-	НМ	PT	H4	J4	45 MIN	
TOILET	108/B	F	3'-0"	7'-0"	1 3/4"	WOOD	-	HM	PT	H4	J4	45 MIN	
TOILET	108/C	F	3'-0"	7'-0"	1 3/4"	WOOD	-	HM	PT	H4	J4	45 MIN	
TOILET	108/D	F	3'-0"	7'-0"	1 3/4"	WOOD	-	HM	PT	H4	J4	45 MIN	
CORRIDOR	154/A	N	3'-6"	7'-0"	1 3/4"	HM	В	HM	PT	H3	J3	45 MIN	
PASSAGE	157/A	N N	3'-6"	7'-0"	1 3/4"	HM	В	HM	PT	H3	J3	45 MIN	
BOYS LOCKER ROOM	157A/A	F	3'-0"	7'-0"	1 3/4"	WOOD	-	HM	PT	H2	J2	45 MIN	
PHYSICS	300/A	 N	3'-0"	7'-0"	1 3/4"	WOOD	В	HM	PT	H2	J2	45 MIN	
PHYSICS	300/A	FG	3'-0"	7'-0"	1 3/4"	GLASS	D	ALUM	MFR	H5	J5	45 WIIV	
PREP	300A/A	F	3'-0"	7'-0"	1 3/4"	WOOD	-	HM	PT	H6		45 MIN	
PREP	300A/B		3'-0"	7'-0"	1 3/4"	WOOD	-	HM	PT	H6		45 MIN	
LIVING ENVIRONMENT	301/A	N I	3'-0"	7'-0"	1 3/4"	WOOD	В	HM	PT	H2	J2	45 MIN	
PREP	301/A 301A/A	F	3'-0"	7'-0"	1 3/4"	WOOD		HM	PT	H1	J1	45 MIN	
PREP	301A/B	F F	3'-0"	7'-0"	1 3/4"	WOOD	-	HM	PT	1		45 MIN	
CHEMISTRY	301A/B	•	3'-0"	7'-0"	1 3/4"	WOOD	<u>-</u> В	HM	PT	H1	J1	45 MIN	
		N N		-				+		H2	J2	1	
BIOLOGY	303/A	N FC	3'-0"	7'-0"	1 3/4"	WOOD	B	HM	PT	H2	J2	45 MIN	
BIOLOGY	303/B	FG	3'-6"	7'-0"	4.0/48	GLASS	D	ALUM	MFR	H5	J5	45.1411	ALTERNATE
CLASSROOM	304/A	N	3'-0"	7'-0"	1 3/4"	WOOD	B	HM	PT	H1	J1	45 MIN	ALTERNATE
EARTH SCIENCE	305/A	<u>N</u>	3'-0"	7'-0"	1 3/4"	WOOD	В	HM	PT	H1	J1	45 MIN	
PREP	305A/A	F	3'-0"	7'-0"	1 3/4"	WOOD	-	HM	PT	H1	J1	45 MIN	
PREP	305A/B	F	3'-0"	7'-0"	1 3/4"	WOOD	<u> </u>	HM	PT	H1	J1	45 MIN	
CLASSROOM	306/A	N	3'-0"	7'-0"	1 3/4"	WOOD	В	HM	PT	H1	J1	45 MIN	ALTERNATE
EARTH SCIENCE	307/A	N	3'-0"	7'-0"	1 3/4"	WOOD	В	HM	PT	H1	J1	45 MIN	
CLASSROOM	309/A	N	3'-0"	7'-0"	1 3/4"	WOOD	В	HM	PT	H2	J2	45 MIN	
CORRIDOR	328/A	G	6'-0"	7'-0"	1 3/4"	WOOD	В	HM	PT	H1	J1	-	
VESTIBULE	431/A	FG	6'-0"	7'-0"		GLASS	D	ALUM	MFR			-	
LOBBY	431/B	FG	6'-0"	7'-0"		GLASS	D	ALUM	MFR			-	PROVIDE FULL HEIGHT CUSTOM GRAPHIC ON DOOR GLAZING
VESTIBULE	432/A	FG	6'-0"	7'-0"		GLASS	D	ALUM	MFR			-	
LOBBY	432/B	FG	6'-0"	7'-0"		GLASS	D	ALUM	MFR			-	PROVIDE FULL HEIGHT CUSTOM GRAPHIC ON DOOR GLAZING
CULINARY	504/A	N	3'-0"	7'-0"	1 3/4"	WOOD	В	HM	PT	H2	J2	45 MIN	
SEWING	506/A	N	3'-0"	7'-0"	1 3/4"	WOOD	В	HM	PT	H2	J2	45 MIN	
SEWING	506/B	FG	3'-0"	7'-0"		GLASS	D	ALUM	MFR	H5	J5	-	
8TH GRADE SCIENCE	509/A	FG	3'-0"	7'-0"		GLASS	D	ALUM	MFR			-	
CLASSROOM	600/A	N	3'-0"	7'-0"	1 3/4"	WOOD	В	HM	PT	H2	J2	45 MIN	
ART ROOM	608/A	N	3'-0"	7'-0"	1 3/4"	WOOD	В	HM	PT	H2	J2	45 MIN	
ART ROOM	608/B	FG	3'-0"	7'-0"		GLASS	D	ALUM	MFR			-	
MENS RESTROOM	905/A	F	3'-0"	7'-0"	1 3/4"	WOOD	-	HM	PT	H4	J4	45 MIN	
STORAGE	905A/A	F	3'-0"	7'-0"	1 3/4"	WOOD	-	НМ	PT	H1	J1	45 MIN	
TOILET	905B/A	F	3'-0"	7'-0"	1 3/4"	WOOD	-	НМ	PT	H1	J1	-	
TOILET	905C/A	F	3'-0"	7'-0"	1 3/4"	WOOD		HM	PT	H1	J1	-	
LOCKER/ CHANGING	905D/A	F	3'-0"	7'-0"	1 3/4"	WOOD	-	HM	PT	H1	J1	-	
GENDER NEUTRAL TOILET/ SHOWER	905E/A	 F	3'-0"	7'-0"	1 3/4"	WOOD		HM	PT	H1	J1	-	
STORAGE	905F/A	F	3'-0"	7'-0"	1 3/4"	HM	-	HM	PT	H2	J2	45 MIN	
PASSAGE	905G/A	 N	3'-0"	7'-0"	1 3/4"	WOOD	В	HM	PT	H3	J3	45 MIN	
WOMENS RESTROOM	909/A	F	3'-0"	7'-0"	1 3/4"	WOOD	-	HM	PT	H4	J4	45 MIN	
TOILET	909/A 909A/A	F	3'-0"	7'-0"	1 3/4"	WOOD	-	HM	PT	H1	J1	45 WIIIN	
TOILET	909B/A		3'-0"	7'-0"	1 3/4"	WOOD	-	HM	PT	H1	J1	-	
LOCKER/ CHANGING	909B/A 909C/A	'	3'-0"	7'-0"	1 3/4"	WOOD	-	HM	PT	H1	J1	-	
LOOKLIN OHANOHNO			3'-0"	7'-0"	1 3/4"	WOOD	-	HM	PT	H1	J1	-	
GENDER NEUTRAL TOILET/ SHOWER	909D/A	F											

			DOOR HARDWARE SCI	HEDULE	
CATEGORY	HARDWARE	MANUFACTURER	MODEL	NOTES	
	OFFICE	BEST ACCESS SYSTEM	93K FUNCTION EA	15D TRIM, 626 FINISH, 7 PIN	
	CLASSROOM	BEST ACCESS SYSTEM	93K FUNCTION R	15D TRIM, 626 FINISH, 7 PIN	
	ENTRANCE	BEST ACCESS SYSTEM	93K FUNCTION AB	15D TRIM, 626 FINISH, 7 PIN	
_	PASSAGE	BEST ACCESS SYSTEM	93K FUNCTION N	15D TRIM, 626 FINISH, 7 PIN	
_	PRIVACY	BEST ACCESS SYSTEM	93K FUNCTION L	15D TRIM, 626 FINISH, 7 PIN	
LOCKSET	STORAGE	BEST ACCESS SYSTEM	93K FUNCTION D	15D TRIM, 626 FINISH, 7 PIN	COPYRIG
	MAGNETIC LOCK	ASSA ABLOY	SAM2-24	2 AMP POWER SUPPLY, BATTERY BACKUP, MORTISED	THE NEV
-	CARD READER	-	-	PROVIDED BY OWNERS VENDER	
_	COMBINATION STRIKE /STOP	ASSA ABLOY	CSS-9	626 FINISH; CENTER HUNG	———BC
_	ELECTRIC STRIKE (JAMB)	HES	1006	MORTISE TYPE UNLESS OTHERWISE NOTED	
_	ELECTRIC STRIKE (HEAD)	VON DUPRIN	6213   24   FS   32D	ONE PER DOOR LEAF	
	KEYPAD	BEST ACCESS SYSTEM	93KZ	15 LEVER, 626 FINISH, 7 PIN, DV FUNCTION	
	PANIC DEVICE (STANDARD)	VON DUPRIN	XP99 OR XP99F	XP98/99L LEVER, STANDARD DOGGING	
EGRESS	PANIC DEVICE (CHEXIT)	VON DUPRIN	CX9947   L(06)   LBR   ES TOP LATCH   3-0 7-0   626   INFINITE RELEAS		
-	CONCEALED RODS	TO MATCH PANIC HARDWARE	-	4RL CONTROL BOARD (AO AUTO OPERATOR FUNCTION) FINISH TO MATCH PANIC HARDWARE	
	CONCLALLD NODS	TO MATCHT ANICHAEDWARE	-	THISTITO WATCHT AND HANDWARE	
	CONCEALED CLOSER	RIXON	608 SERIES	-	
CLOSERS	CLOSER - STANDARD	LCN	4040XP SERIES	METAL COVER, 689 FINISH, PARALLEL ARM UNLESS OTHERWISE NOTED	
	CLOSER - WITH STOP	LCN	4040XP SERIES	METAL COVER, 689 FINISH, PARALLEL ARM UNLESS OTHERWISE NOTED	
	BUTT - HEAVY DUTY	STANLEY HARDWARE	FB199 (32D)	4 1/2"x4 1/2", 5 KNUCKLE, STAINLESS	
	BUTT - STANDARD	STANLEY HARDWARE	FBB191 (32D)	4 1/2"x4 1/2", 5 KNUCKLE, STAINLESS	
HINGES	CONTINUOUS	STANLEY	662HD	CLEAR SATIN ALUMINUM	
	PIVOT	MCKINNEY	EP5-J	-	
1					4
	ARMOR PLATES	IVES	8400 SERIES	FINISH TO MATCH LEVER, SEE TYPICAL ELEVATIONS FOR MOUNTING AND SIZE	Ci.
	KICK PLATES	IVES	8400 SERIES	FINISH TO MATCH LEVER, SEE TYPICAL ELEVATIONS FOR MOUNTING AND SIZE	Y
PLATES	MOP PLATES	IVES	8400 SERIES	FINISH TO MATCH LEVER, SEE TYPICAL ELEVATIONS FOR MOUNTING AND SIZE	V(P)
	STRETCHER PLATES	IVES	8400 SERIES	FINISH TO MATCH LEVER, SEE TYPICAL ELEVATIONS FOR MOUNTING AND SIZE	```
	FLOOR	IVES	FS436	ALUMINUMCOORDINATE WITH DOOR STOP LOCATION DETAIL	
STOPS	OVERHEAD	GLYNN-JOHNSON	100S SERIES	FINISH: US32D, OPTIONS: ADJ	
	WALL BUMPER	IVES	WS407CCV & WS407CVX	STAINLESS (US32D)	
	ASTRAGAL	METAL: ASSA ABLOY - ROCKWOOD	306-AST	WOOD: FINISH TO MATCH DOOR METAL: FINISH SS (US32D/630 SEE DOOR HARDWARE MATIX FOR TYPE DEFINITION	J
	COAT HOOK	AMERICAN SPECIALTIES	7340-S	#4 SATIN STAINLESS	
	COORDINATOR	ASSA ABLOY - ROCKWOOD	576 - GRAVITY DOOR COORDINATOR	FINISH: US26D/626	
	ELECTRIC DOOR OPERATOR	SEE SPECIFICATION			
	EDGE PROTECTION	ASSA ABLOY - ROCKWOOD	307 / 306B	FULL HEIGHT OF DOOR, STAINLESS STEEL (US32D/630) STRIKE SIDE ONLY UNLESS OTHERWISE NOTED	REV [
	FLUSH BOLTS	IVES	FB358 SERIES	STAINLESS	
	GASKETING - WEATHER	NATIONAL GUARD PRODUCTS	HEAD AND JAMB: 2525C BOTTOM: 95WHDB	ALL METALS FINISHED IN MILL ALUMINUM	
	GASKETING - SIGHT	NATIONAL GUARD PRODUCTS	136P	MORTISED ASTRAGAL - MILLED ALUMINUM	
	GASKETING - ACOUSTIC	NATIONAL GUARD PRODUCTS	HEAD AND JAMB: 107SA BOTTOM: 780SA		
ACCESSORIES	GASKETING - SMOKE (ASTRIGAL)	NATIONAL GUARD PRODUCTS	ASTRIGAL: 5070CL	INSTALLED AT ASTRIGAL	DRAWN
	GASKETING - SMOKE (FRAME)	NATIONAL GUARD PRODUCTS	FRAME: 5050CL	INSTALLED AT FRAME	MHK/AL
	HOSPITAL STOP	-	-	HOLLOW METAL DOOR FRAME OPTION	CHECK
	MAGNETIC HOLD OPEN	LCN	SEM 7840/7850	SATIN ALUMINUM / STAINLESS STEEL	MLC
	PUSH/PULL	IVES	400A / 401A	US26d / US32D	IVILO
	PROXIMITY SENSOR	PER DOOR OPERATOR MANUFACTURE	-	SEE OPERATOR SPECIFICATIONS	
	SWEEP	NATIONAL GUARD PRODUCTS	9600A	PLACE ON WEATHER / LOWER TEMP. SIDE OF DOOR	
	SILENCER	IVES	SR64	GREY UNLESS OTHERWISE NOTED	
	THRESHOLD	NATIONAL GUARD PRODUCTS	895	MILL ALUMINUM	BUILDIN
	ELECTRIC LATCH RETRACTION	VON DUPRIN	99/98 QEL	PROVIDE ASSOCIATED POWER TRANSFER AND SUPPYVON DUPRIN EPT10 ELECTRIC POWER TRANSFER	

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GENERAL BROWN CSD JUNIOR SENIOR HIGH SCHOOL 17643 CEMETERY RD

PROJECT NUMBER 2023-105 CKED BY DATE 12/16/2024 DOOR SCHEDULES

A800

DEXTER - JEFFERSON - NEW YORK

DATE

DESCRIPTION

DING NUMBER SHEET NUMBER

HS

