

DRAWING LIST

GENERAL NOTES, SYMBOLS, AND ABBREVIATIONS OVERALL SITE PLAN AND DETAILS

TERRACE DEMOLITION - BALUSTRADE REMOVAL TERRACE FOUNDATION DEMOLITION PLAN

TERRACE FOUNDATION PLAN


TERRACE PLAN

BALUSTRADE INSTALLATION



It is a violation of the law for any person, unless acting under the direction of a licensed architect, to alter an item in any way. If an item bearing the seal of an architect is altered, the altering architect shall affix to his item the seal and the notation "ALTERED BY" followed by his signature and the date of such alteration, and a specific description of the alteration.

BDA Project Number

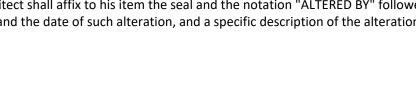

25033



SUNY CORTLAND ALUMNI HOUSE TERRACE REPLACEMENT

OPRHP CRIS PROJECT NUMBER: 23PR10147

PROJECT NUMBER: EPF-237970

08.04.2025 FINAL BID SET

Consultant Owner SUNY CORTLAND ALUMNI ASOCIATION 29 TOMPKINS ST

29 TOMPKINS ST.

CORTAND NY 13045

CORTLAND NY 13045

BEARDSLEY ARCHITECTS + ENGINEERS 64 SOUTH STREET

AUBURN, NY 13021 315.253.7301

Architect + Engineer

APPLICABLE 2. WORK SHALL CONFORM TO THE STANDARD OF THE BUILDING AND BE APPROVED BY THE OWNER BEFORE COMMENCING WORK. INSTALL WORK TO AS TO BE READILY ACCESSIBLE FOR OPERATING, MAINTENANCE AND REPAIR. MINOR DEVIATIONS FROM DRAWINGS MAY BE MADE TO ACCOMPLISH THIS. BUT CHANGES OF MAGNITUDE WHICH INVOLVE EXTRA COST SHALL NOT BE MADE WITHOUT APPROVAL.

APPLICABLE GOVERNMENTAL REGULATIONS AND

SHALL BEAR APPROVAL CERTIFICATES AS

- 4. REMOVAL AND RELOCATION OF CERTAIN EXISTING WORK MAY BE NECESSARY FOR THE PERFORMANCE OF GENERAL WORK. ALL EXISTING CONDITIONS ARE NOT COMPLETELY DETAILED ON THE DRAWINGS. THE CONTRACTOR SHALL SURVEY THE SITE AND MAKE ALL NECESSARY CHANGES REQUIRED BASED ON EXISTING CONDITIONS FOR PROPER INSTALLATION OF NEW WORK, AND INCLUDE ALL MATERIALS AND LABOR IN HIS BID
- 5. THE DRAWINGS ARE DIAGRAMMATIC AND SHOW THE GENERAL ARRANGEMENT OF THE ELECTRICAL SYSTEM. DETAILS OF CONSTRUCTION AND OF WORKMANSHIP WHERE NOT SPECIFICALLY DESCRIBED HEREIN OR INDICATED ON THE DRAWINGS SHALL BE SUBJECT TO THE ENGINEER'S APPROVAL. IT IS THE INTENT OF THESE SPECIFICATIONS TO PROVIDE COMPLETE SYSTEMS, LEFT IN GOOD WORKING ORDER, READY FOR OPERATION, INCLUDING NECESSARY LABOR AND MATERIALS, WHETHER OR NOT SPECIFICALLY SHOWN ON THE DRAWINGS OR MENTIONED HEREIN. IT IS NOT THE INTENTION OF THESE DRAWINGS TO SHOW ALL NECESSARY OFFSETS,

OBSTRUCTIONS, OR STRUCTURAL CONDITIONS. IT SHALL BE THE RESPONSIBILITY OF THE CONTRACTOR TO INSTALL HIS WORK IN SUCH A MANNER TO AVOID OBSTRUCTIONS, PRESERVE HEADROOM, AND KEEP OPENINGS AND INSTRUCTIONS.

CAREFULLY EXAMINE FIELD CONDITIONS AND CONTRACT DRAWINGS OF ALL TRADES. SUBMISSION OF PROPOSAL WILL BE CONSTRUED AS EVIDENCE THAT REQUIRED EXAMINATION HAS BEEN MADE. LATER CLAIMS FOR EXTRA LABOR. EQUIPMENT AND MATERIALS REQUIRED DUE TO DIFFICULTIES WHICH COULD HAVE BEEN FORESEEN, WILL NOT BE RECOGNIZED. VERIFICATION SHALL BE MADE AS TO THE ACTUAL LOCATIONS WHERE DEVICES AND EQUIPMENT WILL BE INSTALLED. SHOULD THE CONTRACTOR FIND ANY EQUIPMENT OR CONDITION THAT IS NOT IN AGREEMENT WITH THE PLANS, HE SHALL REFER THE MATTER TO THE ENGINEER'S ATTENTION BEFORE PROCEEDING WITH THE DEMOLITION OR CONSTRUCTION.

- 7. BRING THE IMMEDIATE ATTENTION OF THE OWNER ANY CHANGES IN THE SIZE OR LOCATION OF THE MATERIAL OR EQUIPMENT WHICH MAY BE OR IN ORDER TO AVOID CONFLICT WITH THE EQUIPMENT OF OTHER SECTIONS. OBTAIN THE OWNER'S APPROVAL BEFORE SUCH DEVIATIONS ARE MADE.
- 8. SUPPORT ALL LIGHTING FIXTURES FROM THE APPROVED MANNER.
- 9. BEFORE COMPLETION OF THE PROJECT, THE CONTRACTOR SHALL TEST ALL EQUIPMENT. ALL EQUIPMENT SHALL BE OPERATED TO VERIFY TO THE OWNER THAT EACH UNIT PERFORMS SATISFACTORILY AND MEETS THE REQUIREMENTS SPECIFIED.
- 10. THE CONTRACTOR SHALL REPAIR AND RESTORE TO ORIGINAL CONDITION ANY EXISTING EQUIPMENT OR MATERIALS DAMAGED IN THE PROCESS OF INSTALLATION, TO THE SATISFACTION OF THE OWNER'S REPRESENTATIVES.

CONDUCTORS

- PART 2 PRODUCTS 1. COPPER CONDUCTORS, LISTED AND LABELED AS DEFINED IN NFPA 70 AND MARKED FOR INTENDED LOCATION AND USE, RATED 600V OR
- 2. AC, MC, OR NM CALEB IS NOT ALLOWED.
- a. FACTORY FABRICATED CONNECTORS, SPLICES
- 1. PROVIDE STRANDED FOR #8 AND LARGER, SOLID
- 2. PROVIDE 2#12 AND #12 GND IN 3/4" CONDUIT FOR ALL RECEPTACLE AND LIGHTING BRANCH CIRCUITS UNDER 100' IN LENGTH. PROVIDE #12
- AND CEILINGS.

- 1. INSULATED COPPER CONDUCTORS FOR 600V UNLESS OTHERWISE REQUIRED BY APPLICABLE CODE. BARE CONDUCTORS PER ASTM.
- PART 3 EXECUTION
- #8 AWG AND SMALLER, AND STRANDED FOR #6 AWG AND LARGER.
- WITH ALL FEEDERS AND BRANCH CIRCUITS. RACEWAYS AND BOXES FOR ELECTRICAL SYSTEMS PART 2 - PRODUCTS

LABELED AS DEFINED IN NFPA 70.

- 1. METAL, CONDUITS, TUBING, AND FITTINGS a. LISTING AND LABELING: METAL CONDUITS,
- TUBING AND FITTINGS SHALL BE LISTED AND
- 2. NONMETALLIC CONDUITS, TUBING AND FITTINGS a. RNC: TYPE TPC-40-PVC, COMPLYING WITH NEMA TC 2 AND UL 651 UNLESS OTHERWISE INDICATED.
- PART 3.1 EXECUTION
- 1. OUTDOORS: APPLY RACEWAY PRODUCTS AS SPECIFIED BELOW UNLESS OTHERWISE INDICATED.
- b. CONCEALED CONDUIT, ABOVEGROUND: GRC.

a. EXPOSED CONDUIT: GRC.

- c. UNDERGROUND CONDUIT: RNC, TYPE EPC-40-PVC.
- d. CONNECTION TO VIBRATING EQUIPMENT (INCLUDING TRANSFORMERS AND MOTOR-DRIVEN EQUIPMENT): LFMC. BOXES AND ENCLOSURES, ABOVEGROUND:
- NEMA 250, TYPE 3R. 2. INDOORS: APPLY RACEWAY PRODUCTS AS SPECIFIED BELOW UNLESS OTHERWISE INDICATED.
- a. EXPOSED CONDUIT: EMT.
- b. CONCEALED CONDUIT: EMT.
- c. SURFACE RACEWAY: TWO PIECE METAL, PAINT TO MATCH WALL.
- d. CONNECTION TO EQUIPMENT: MAX 6'-0"
- FLEXIBLE METAL CONDUIT. e. BOXES AND ENCLOSURES: NEMA 250, TYPE I, EXCEPT DAMP OR WET LOCATIONS.

- PASSAGEWAYS CLEAR WITHOUT FURTHER COST OR
- 6. BEFORE SUBMITTING PROPOSAL, BIDDERS SHALL
- NECESSARY IN ORDER TO MEET FIELD CONDITIONS,
- BUILDING STRUCTURE AND/OR FRAMING IN AN

PART 3.2 - INSTALLATION

1. PROVIDE A MINIMUM 1/2" SIZE.

3. (300 MM) OF CHANGES IN DIRECTION.

WALLS, CEILINGS, AND FLOORS UNLESS

OF ENCLOSURES TO WHICH ATTACH ED.

7. RACEWAY TERMINATIONS AT LOCATIONS

CONDUCTORS INCLUDING CONDUCTORS

INSULATING BUSHINGS TO PROTECT

SUBJECT TO MOISTURE OR VIBRATION: USE

8. CUT CONDUIT PERPENDICULAR TO THE LENGTH.

CUT STRAIGHT AND PERPENDICULAR TO THE

FOR CONDUITS 2-INCH (53 MM) TRADE SIZE AND

LARGER, USE ROLL CUTTER OR A GUIDE TO MAKE

WRITTEN INSTRUCTIONS.

SMALLER THAN #4 AWG.

LENGTH.

2. INSTALL NO MORE THAN THE EQUIVALENT OF

THREE 90-DEGREE BENDS IN ANY CONDUIT RUN

EXCEPT FOR CONTROL WIRING CONDUITS, FOR

4. CONCEAL CONDUIT AND EMT WITHIN FINISHED

OTHERWISE INDICATED. INSTALL CONDUITS

PARALLEL OR PERPENDICULAR TO BUILDING

5. SUPPORT CONDUIT WITHIN 12 INCHES (300 MM)

6. THREADED CONDUIT JOINTS, EXPOSED TO WET,

APPLY LISTED COMPOUND TO THREADS OF

RACEWAY AND FITTINGS BEFORE MAKING UP

JOINTS. FOLLOW COMPOUND MANUFACTURER'S

DAMP, CORROSIVE OR OUTDOOR CONDITIONS:

- WHICH FEWER BENDS ARE ALLOWED. SUPPORT WITHIN 12 INCHES
- 3. CONNECTORS AND SPLICES
- PART 3 EXECUTION
- FOR #10 AND SMALLER.

LISTED AND LABELED AS DEFINED IN NFPA 70.

SIZE WHEN OVER 100' IN LENGTH. 3. CONCEAL CONDUCTORS IN FINISH ED WALLS

GROUNDING

PART 2 - PRODUCTS

- 2. GROUND RODS: COPPER-CLAD 3/4" x 10'
- 1. DESCRIPTION: PROVIDE SOLID CONDUCTOR FOR
- 9. FLEXIBLE CONDUIT CONNECTIONS: COMPLY WITH NEMA RV 3. USE A MAXIMUM OF 72 2. PROVIDE INSULATED GROUNDING CONDUCTORS INCHES (1830 MM) OF FLEXIBLE CONDUIT FOR EQUIPMENT SUBJECT TO VIBRATION, NOISE TRANSMISSION, OR MOVEMENT: AND FOR
 - PART 3.3 INSTALLATION OF UNDERGROUND

TRANSFORMERS AND MOTORS.

- 1. DIRECT-BURIED CONDUIT:
- a. EXCAVATE TRENCH BOTTOM TO PROVIDE FIRM AND UNIFORM SUPPORT FOR CONDUIT.
- b. AFTER INSTALLING CONDUIT, BACKFILL AND COMPACT. START AT TIE-IN POINT, AND WORK TOWARD END OF CONDUIT RUN, LEAVING CONDUIT AT END OF RUN FREE TO MOVE WITH EXPANSION AND CONTRACTION AS TEMPERATURE CHANGES DURING THIS PROCESS. FIRMLY HAND TAMP BACKFILL AROUND CONDUIT TO PROVIDE MAXIMUM SUPPORTING STRENGTH. AFTER PLACING CONTROLLED BACKFILL TO WITHIN 12 INCHES

(300 MM) OF COMPLETE BACKFILLING WITH

c. INSTALL MANUFACTURED DUCT ELBOWS FOR STUB-UPS AT EQUIPMENT AND AT BUILDING **ENTRANCES THROUGH FLOOR UNLESS** OTHERWISE INDICATED. ENCASE ELBOWS FOR STUB-UP DUCTS THROUGHOUT LENGTH OF

NORMAL COMPACTION.

d. UNDERGROUND WARNING TAPE: PROVIDE YELLOW PLASTIC WARNING TAPE ABOVE CONDUIT.

GENERAL NOTES

THE SUNY CORTLAND ALUMNI HOUSE IS LISTED IN THE NATIONAL REGISTER OF HISTORIC PLACES. THE CONTRACTOR SHALL NOT MAKE JUDGEMENTS AS TO THE RELATIVE SIGNIFICANCE OF ANY FEATURE NOR THE IMPACT OF ANY OR ALL WORK. THIS JUDGEMENT RESPONSIBILITY SHALL REST SOLELY WITH THE ARCHITECT. CONSEQUENTLY, NO DEVIATIONS FROM THE CONTRACT DOCUMENTS SHALL OCCUR WITHOUT WRITTEN APPROVAL FROM THE ARCHITECT. IT IS THE RESPONSIBILITY OF THE CONTRACTOR TO TAKE APPROPRIATE CARE IN REPAIRING AND REPLACING HISTORIC MATERIAL.

SCOPE OF THE CONTRACTOR'S WORK

THE WORK OF THE PROJECT, AS DESCRIBED BY THE CONTRACT DOCUMENTS, GENERALLY INCLUDES RECONSTRUCTION OF HISTORICALLY SIGNIFICANT RESOURCES IN THE FOLLOWING AREAS OF SUNY CORTLAND ALUMNI HOUSE:

- 1. MANSION TERRACE A. TEMPORARILY RELOCATE THE GENERATOR B. PRESSURE WASH ALL COMPONENTS OF THE
- STORE FOR REINSTALLATION.
- D. REPAIR OR REPLACE ANY DAMAGED COMPONENTS OF THE BALUSTRADE.
- E. REMOVE TERRACE SLAB F. REMOVE THE PERIMETER WALL, FOUNDATION,

BALUSTRADE, INCLUDING FOUNDATION CAPS,

BALUSTERS, WALL SEGMENTS, AND RAIL CAPS.

C. REMOVE THE BALUSTRADE IN ITS ENTIRETY AND

- AND FOOTINGS OF THE TERRACE CRAWL SPACE G. REMOVE CLAY DRAIN TILE.
- H. INSTALL NEW DRAIN TILE, MAKE CONNECTIONS TO RAIN DOWNSPOUTS, STUB UP DECK FLOOR DRAINS.
- I. RECONSTRUCT FOUNDATION WALL OF TERRACE.
- J. INSTALL TERRACE SLAB K. REINSTALL BALUSTRADE.
- 2. TERRACE STEPS A. REMOVE TWO SETS OF STEPS, THE CONCRETE WALK BETWEEN, AND THE CURBING. STORE THE
 - CURBING FOR REINSTALLATION. B. RECONSTRUCT STEPS, WALK, AND REINSTALL CURBING
 - FRONT PATH
 - A. REMOVE THE CONCRETE PATH FROM THE STEPS TO THE STREET CURB, EXCEPT THE PUBLIC
 - SIDEWALK. B. PRESSURE WASH AND REPOINT THE GATE
 - FOOTINGS IN PLACE.
 - C. RECONSTRUCT THE CONCRETE PATH.
 - D. INSTALL THE FRONT GATE.
 - 4. ACCESSIBLE RAMP, EAST SIDE OF BUILDING A. PRESSURE WASH RAMP AND RAMP FOUNDATION

NOTIFICATIONS BY THE CONTRACTOR

FOLLOWS: . SELECTIVE REMOVALS - PROVIDE 48 HOURS ADVANCE NOTICE PRIOR TO THE START OF SELECTIVE

PROVIDE NOTIFICATIONS TO OWNER AND ARCHITECT AS

- REMOVALS DEMOLITION - PROVIDE 48 ADVANCE NOTICE PRIOR TO THE START OF DEMOLITION
- 3. BACKFILL AND COMPACTION PROVIDE 24 HOURS ADVANCE NOTICE PRIOR TO START OF ANY BACKFILLING OR COMPACTION. COORDINATE ALL SOIL COMPACTION TESTING WITH TESTING AGENCY. NO BACKFILLING FOR STRUCTURES OR PAVEMENTS SHALL BE COMPLETED WITHOUT SPECIFIED TESTING

4. OPEN FLAME, WELDING, ETC. - PROVIDE 48 HOURS

- ADVANCE NOTICE BEFORE USING ANY HEAT PRODUCING TOOLS IN THE WORK AREA 5. GARDEN DISTURBANCE - PROVIDE TWO WEEKS
- NOTICE IN ADVANCE OF ANY DISTURBANCE OF PLANTED AREA/GARDEN
- 6. UTILITY DISTURBANCE PROVIDE 48 HOURS ADVANCE NOTICE

WORK BY OWNER

FOR THE PROJECT.

https://udigny.org/

- 1. SPECIAL INSPECTION AND TESTING REQUIRED BY CHAPTER 17 OF NEW YORK
- 2. RELOCATION OF ANY GARDEN/PLANTINGS THAT WILL BE DISTURBED BY WORK

ADVISORY - LEAD-BASED PAINT ABATEMENT

CONTRACTOR IS ADVISED THAT LEAD MAY BE **ENCOUNTERED IN EXISTING DRAIN TILE ASSEMBLY** REMOVE DRAIN TILE UNDER ABATEMENT CONDITIONS.

GEOTECHNICAL NO SUBSURFACE INVESTIGATION HAS BEEN PERFORMED

SITE PREPARATION

AND STOCKPILE TOPSOIL FOR REUSE IN WORK.

STRIP GARDENS AND LAWN AREA OF VEGETATION,

2. PROVIDE 25 CUBIC YARDS OF TOPSOIL FROM APPROVED OFF-SITE SOURCE FOR FUTURE PLANTING BEDS. PLACE TOPSOIL IN LOCATIONS AS DIRECTED BY OWNER.

UNDERGROUND UTILITIES THE EXTENT OF UNDERGROUND UTILITIES IS UNKNOWN. CONTRACTOR IS SOLELY RESPONSIBLE TO DETERMINE LOCATION OF UNDERGROUND UTILITIES PRIOR TO EXCAVATION FOR FOUNDATION OR FOOTING CONSTRUCTION.

CONTACT UDIG NY FOR ALL UTILITY CLEARANCES.

CONTRACTOR IS SOLELY RESPONSIBLE FOR ALL TEMPORARY SHORING REQUIRED TO ALLOW SAFE REMOVAL OF ANY SUPPORTING ELEMENT OF THE STRUCTURES OR TO PROTECT PERSONS AND PROPERTY.

- PREVENT COLLAPSE OF INDIVIDUAL ELEMENTS.
- 2. STABILIZE DETERIORATED ELEMENTS AS REQUIRED TO COMPLETE WORK AND MAINTAIN STRUCTURE.

SELECTIVE REMOVALS

- 1. SELECTIVE REMOVAL OF ELEMENTS IS INDICATED IN THE DRAWINGS, BUT GENERALLY INCLUDES:
- A. TERRACE BALUSTERS B. FOUNDATION CAPS
- C. RAIL CAPS
- D. WALL SEGMENTS. E. PINEAPPLE PEDESTAL MONUMENTS
- 8. PRIOR TO DISMANTLING, REMOVAL, OR DEMOLITION, PERFORM FIELD MEASUREMENT OF THE EXISTING STRUCTURES TO ASSURE CORRECT FIT OF EXISTING COMPONENTS INTO NEW CONSTRUCTION. DO NOT ALTER EXISTING ELEMENTS WITHOUT WRITTEN AUTHORIZATION.
- 9. ACCURATELY DOCUMENT ALL COMPONENTS SCHEDULED FOR DISMANTLING OR REMOVAL AND REINSTALLATION. USE DOCUMENTATION TO RESET ELEMENTS IN SAME LOCATION AND ORIENTATION.
- 10. APPLY NON-PERMANENT IDENTIFICATION MARKS TO ELEMENTS PRIOR TO REMOVAL
- 11. PHOTOGRAPH ALL ELEMENTS IN PLACE WITH VISIBLE
- 12. SUBMIT CD OF PHOTOGRAPHS TO ARCHITECT FOR
- APPROVAL PRIOR TO START OF ANY REMOVALS 13. DURING DISMANTLING OR REMOVAL OF ELEMENTS, PLACE ID MARK ON CONCEALED SURFACE TO ENSURE
- THAT ID MARK IS NOT LOST OR ERASED. 14. STORE ELEMENTS IN STABLE AND SECURE MANNER AT ON-SITE LOCATION.
- 15. MAINTAIN AND SECURE STORAGE AREA TO PREVENT DAMAGE OR THEFT.

DEMOLITION

- 1. DEMOLITION IS INDICATED IN THE DRAWINGS, BUT
- GENERALLY INCLUDES: A. TERRACE FOUNDATION WALL AND FOOTINGS B. VENEER PANELS ON FOUNDATION WALL
- C. TWO SETS OF STEPS AND THE CONCRETE WALK D. THE CONCRETE PATH FROM THE STEPS TO THE
- E. THE CONCRETE PATH FROM THE SIDEWALK TO 2. ALL DEMOLITION SHALL BE COMPLETED IN A

VIBRATIONS, IMPACT, OR OTHER

FOUNDATION DESIGN

SPECIFIED FOUNDATION DESIGN IS SUBJECT TO CHANGE BASED ON EXPOSURE OF CONCEALED CONDITIONS.

CONTROLLED MANNER TO PREVENT ANY DAMAGE

TO THE PROPERTY OR ADJOINING STRUCTURES BY

OWNERS USE OF THE SITE

THE SUNY CORTLAND ALUMNI SITE WILL BE OCCUPIED BY THE OWNER AND PUBLIC DURING THE WORK.

THE PUBLIC (REFER TO SPECIFICATIONS AND DRAWINGS). 2. PROVIDE APPROPRIATE SIGNAGE IN MANSION TO ADVISE THE PUBLIC OF BUILDING EXITS AND

RESTRICTED WORK AREAS. COORDINATE SIGNAGE

WITH THE OWNER AND MAINTAIN ACCORDING TO

1. PROVIDE PANELIZED HARD BARRIERS TO PROTECT

THE PHASING OF THE WORK. PROTECTION OF PROPERTY

1. PROTECT LAWN, GARDENS, AND ADJACENT STRUCTURE FROM DAMAGE BY THE WORK.

1. ACCESS TO/FROM SITE SHALL BE FROM TOMPKINS STREET AND ONLY DURING NORMAL BUSINESS HOURS.

CONTRACTOR PARKING


1. LIMITED 2-HR. PARKING FOR CONTRACTOR'S USE IS AVAILABLE ON TOMPKINS STREET AND ADJACENT


SIDE STREETS. CONSTRUCTION LIMITS

1. LIMIT WORK TO AREAS INDICATED ON DRAWINGS.

1. MATERIAL STORAGE AREA IS AVAILABLE ON SITE.

SITE RESTORATION 1. RESTORE ALL SURFACES DISTURBED DURING THE WORK, INCLUDING BUT NOT LIMITED TO ASPHALT

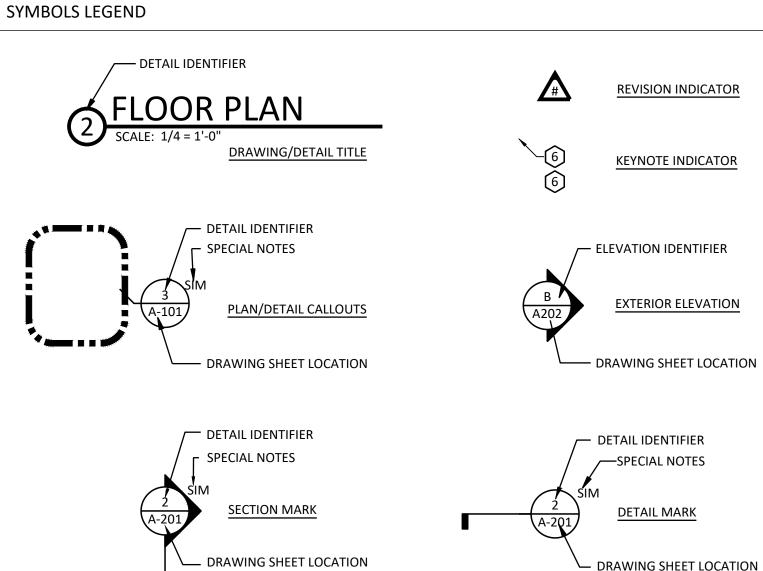

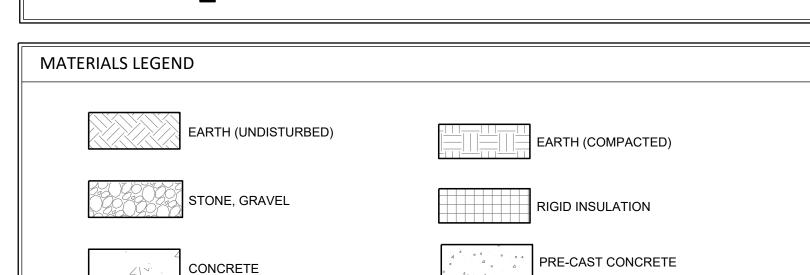

ABBREVIATIONS

@	AT	FD	FLOOR DRAIN	ОС	ON CENTER
APPROX	APPROXIMATE,	FND	FOUNDATION	OH	OVERHEAD
	APPROXIMATELY	FT	FEET OR FOOT	.	0 1 2 1 1 1 2 1 2
ARCH	ARCHITECT(URAL)	FTG	FOOTING	P/L	PROPERTY LINE
7.11.01.1	7.11.67.11.7.267 (67.0.12)			PL	PLATE
B/	BOTTOM OF	GA	GAUGE		
BOW	BOTTOM OF WALL	GC	GENERAL CONTRACTOR	R	RISER
2011	BOTTOM OF WALL			ROW	RIGHT OF WAY
CJ	CONTROL JOINT	НВ	HOSE BIB		
CONC	CONCRETE	HT	HEIGHT	SAN	SANITARY
CRS	COURSE(S)			SF	SQUARE FEET,
CLSM	CONTROLLED LOW	INT	INTERIOR	SIM	SIMILAR
	STRENGTH MATERIAL	INV	INVERT		
				T	TREAD(S)
D	DEPTH	L	LONG, LENGTH	T/	TOP OF
DBL	DOUBLE			T/FND	TOP OF FOUNDATION
DEMO	DEMOLISH/DEMOLITION	MAX	MAXIMUM	TOC	TOP OF CURB
DIA OR Ø	DIAMETER	MIN	MINIMUM	TYP	TYPICAL
DIM	DIMENSION	MISC	MISCELLANEOUS		
DS	DOWNSPOUT	MO	MASONRY OPENING	VERT	VERTICAL
DWG	DRAWING				
		N/A	NOT APPLICABLE	W/	WITH
EJ	EXPANSION JOINT	NIC	NOT IN CONTRACT	W/O	WITHOUT
ETC	ET CETERA	NO OR #	NUMBER	WWM	WELDED WIRE MESH
ETR	EXISTING TO REMAIN	NOM	NOMINAL		

NOT TO SCALE

PLUMBING SPECIFICATIONS

ACTION SUBMITTALS

A. PRODUCT DATA FOR EACH TYPE OF PRODUCT INDICATED.

- CUTTING AND PATCHING A. PROVIDE ALL CUTTING AND PATCHING' (UNLESS
- OTHERWISE NOTED ON PLANS) REQUIRED TO PERFORM THE PLUMBING WORK.
- B. EXISTING CONDITIONS SIZE AND LOCATION OF ALL EXISTING CONCEALED PIPING IS BASED ON INFORMATION OBTAINED FROM PREVIOUS PLANS AND DRAWINGS. IT SHALL BE THE CONTRACTOR'S RESPONSIBILITY TO

VERIFY ALL EXISTING SIZES AND LOCATIONS IN THE

FIFI D. CORE DRILLING

A. CORE DRILLING REQUIRED FOR PLUMBING WORK SHALL BE THE RESPONSIBILITY OF THE CONTRACTOR. B. THE GENERAL CONTRACTOR IS RESPONSIBLE FOR

OBTAINING APPROVAL FROM THE OWNER FOR ALL

CORE DRILLING LOCATIONS. C. REHABILITATION PROJECTS AND EXISTING BUILDINGS: SLEEVES ARE NOT REQUIRED FOR PIPING PASSING THROUGH EXISTING WALLS THAT HAVE BEEN NEATLY CORE DRILLED.

REMOVALS

- A. REMOVE ALL EXISTING MATERIALS AND EQUIPMENT USUALLY INCLUDED IN THE WORK OF THIS DIVISION, (WHETHER SPECIFICALLY INCLUDED HEREIN OR NOT) FROM CONSTRUCTION WHICH IS SCHEDULED TO BE DEMOLISHED. THE PLUMBING TRADE SHALL PATCH EXISTING CONSTRUCTION AND FINISHES DAMAGED OR LEFT INCOMPLETE DUE TO REMOVALS.
- B. REFER TO ARCHITECTURAL PLANS AND SCHEDULES TO DETERMINE EXTENT OF CONSTRUCTION BEING REMOVED, AND VISIT JOB SITE TO EXAMINE EXISTING CONDITIONS.

PRODUCTS

- **PVC PIPE AND FITTINGS**
- A. SOLID WALL PVC PIPE: ASTM D 2665, DRAIN, WASTE, AND VENT
- B. PVC SOCKET FITTINGS: ASTM D 2665, MADE TO ASTM D 3311, DRAIN, WASTE, AND VENT PATTERNS AND TO FIT SCHEDULE 40 PIPE. C. ADHESIVE PRIMER: ASTMF656.

1. ADHESIVE PRIMER SHALL HAVE VOC CONTENT OF

550g/L OR LESS WHEN CALCULATED ACCORDING

VOLATILE ORGANIC EMISSIONS FROM VARIOUS

SOURCES USING SMALL-SCALE ENVIRONMENTAL

- TO 40 CFR 59, SUBPART D (EPA METHOD 24). 2. ADHESIVE PRIMER SHALL COMPLY WITH THE TESTING AND PRODUCT REQUIREMENTS OF THE CALIFORNIA DEPARTMENT OF HEALTH SERVICES' "STANDARD PRACTICE FOR THE TESTING OF
- CHAMBERS."
- D. SOLVENT CEMENT: ASTM D 2564 1. PVC SOLVENT CEMENT SHALL HAVE A VOC CONTENT OF 510 g/L OR LESS WHEN CALCULATED ACCORDING TO 40 CFR 59, SUBPART D (EPA
- METHOD 24). 2. SOLVENT CEMENT SHALL COMPLY WITH THE TESTING AND PRODUCT REQUIREMENTS OF THE CALIFORNIA DEPARTMENT OF HEALTH SERVICES' "STANDARD PRACTICE FOR THE TESTING OF VOLATILE ORGANIC EMISSIONS FROM VARIOUS SOURCES USING SMALL-SCALE ENVIRONMENTAL

CHAMBERS." CLEANOUTS

- A. MATERIALS: SAME AS PIPING IN WHICH THEY ARE
- INSTALLED B. INSTALL CLEANOUTS IN SUCH A MANNER THAT ALL PIPING MAY BE READILLY REACHED FOR PURPOSES OF CLEANING.
- C. CLEANOUTS SHALL BE OF THE SAME NOMINAL SIZE AS THE PIPE, BUT NEED NOT BE LARGER THAN 4" (INCHES).

GENERAL CONCRETE NOTES

- 1. ALL CONCRETE SHALL BE BATCHED, TRANSPORTED, CONVEYED, PLACED CURED. AND TESTED IN ACCORDANCE WITH ACI 301 AND CHAPTER 19 OF THE BUILDING CODE. AND AS SPECIFIED HEREIN.
- REFER TO PROJECT SPECIFICATIONS FOR CONCRETE COMPRESSIVE
- STRENGTH AND AIR ENTRAINMENT. ALL REINFORCING STEEL BARS SHALL BE ASTM A615, GRADE 60 DEFORMED BARS. TYPICAL REINFORCING BAR SPLICED LAP LENGTHS SHALL BE AS

SHOWN IN THE "REINFORCING BAR SPLICE LAPS" TABLE ON THIS SHEET.

- PROVIDE #4 AT 12" OC BARS EACH WAY IN ALL WALLS; (1) #5 CONTINUOUS AT TOP OF WALLS; #4 AT 12" OC x 4'-0" BENT DOWELS AT ALL CORNERS AND INTERSECTIONS; (3) #5 CONTINUOUS FOOTING BARS; #4 AT 12" OC DOWELS TO ALL FOOTINGS AND STRUCTURAL
- SLABS; WHERE NO OTHER REINFORCING SHOWN. PROVIDE TWO #4 BARS AT ALL EDGES AND TWO #4 DIAGONAL AT CORNERS OF OPENINGS IN CONCRETE WALLS AND TWO #4 DIAGONAL AROUND OPENINGS IN STRUCTURAL SLABS UNLESS OTHERWISE
- 4. WELDED WIRE REINFORCEMENT (WWR) SHALL BE SUPPLIED IN SHEETS CONFORMING TO ASTM A1064. LAP SPLICE WWR SHEETS MINIMUM 6
- PROVIDE 6X6XW2.9XW2.9 WELDED WIRE MESH IN ALL SLABS WHERE NO OTHER REINFORCING SHOWN.
- CLEAR CONCRETE COVER OVER REINFORCING BARS SHALL CONFORM TO
- THE REQUIREMENTS OF ACI 318 AND AS FOLLOWS; • CONCRETE EXPOSED TO EARTH, WEATHER, OR WATER: 2"
- CONCRETE CAST DIRECTLY AGAINST EARTH: 3" 6. APPLY BONDING AGENT PRIOR TO CASTING CONCRETE AGAINST
- HARDENED CONCRETE, UNLESS INDICATED OTHERWISE. ALL EXPOSED EDGES OF CONCRETE MEMBERS SHALL BE FORMED WITH A 3/4" BY 3/4" CHAMFER, INCLUDING TOP EDGES AND OUTSIDE VERTICAL
- CORNERS OF WALLS, SLABS, BEAMS, COLUMNS, ETC. ALL EXTERIOR SLABS AND FLATWORK SHALL HAVE 1/4" PER FOOT (1/8" PER FOOT MINIMUM) SURFACE SLOPE IN ORDER TO PROVIDE POSITIVE
- DRAINAGE. 9. CONTRACTOR SHALL PROVIDE CONSTRUCTION JOINTS AND CONTROL JOINTS AS INDICATED ON THESE DRAWINGS. CONTRACTOR MAY PROPOSE ADDITIONAL CONSTRUCTION JOINTS NEEDED TO FACILITATE CONSTRUCTION. ALL ADDITIONAL CONSTRUCTION JOINTS SHALL BE
- 10. CONTRACTOR SHALL COORDINATE ALL WALL AND SLAB PENETRATIONS AND OPENINGS WITH OTHER TRADES. NOTE THAT NOT ALL PENETRATIONS AND OPENINGS ARE INDICATED ON THESE STRUCTURAL DRAWINGS.

11. CONTRACTOR SHALL COORDINATE THE CASTING-IN OF ALL EMBEDDED

ITEMS AND ACCESSORIES OF ALL TRADES. POST-INSTALLATION OF

APPROVED BY THE STRUCTURAL ENGINEER PRIOR TO CONSTRUCTING.

GENERAL STRUCTURAL NOTES

TO PROCEEDING ON SAID WORK.

EMBEDDED ITEMS WILL NOT BE ACCEPTED

- . STRUCTURAL DRAWINGS SHALL BE FOLLOWED WITH COORDINATION WITH OTHER DRAWINGS. ANY APPARENT DISCREPANCIES SHALL BE BROUGHT TO THE ATTENTION OF THE STRUCTURAL ENGINEER FOR CLARIFICATION PRIOR
- NO CHANGES OF THE STRUCTURAL SYSTEM AS INDICATED ON THESE DRAWINGS SHALL BE PERFORMED PRIOR TO RECEIVING WRITTEN APPROVAL FROM THE STRUCTURAL ENGINEER.
- 3. THESE DRAWINGS DO NOT IDENTIFY COMPONENTS REQUIRED FOR CONSTRUCTION SAFETY. CONTRACTOR SHALL BE RESPONSIBLE TO IDENTIFY AND PROVIDE COMPONENTS REQUIRED FOR CONSTRUCTION

4. CONTRACTOR SHALL FIELD VERIFY ALL DIMENSIONS AND ELEVATIONS

COMPONENTS (WALLS, ROOF, ETC.), AND ALL CONNECTIONS AND

PERMANENT BRACING ARE INSTALLED.

- PRIOR TO STARTING CONSTRUCTION. 5. CONTRACTOR SHALL BE RESPONSIBLE FOR TEMPORARILY BRACING AND MAINTAINING THE STABILITY OF THE ALL STRUCTURES DURING CONSTRUCTION. STRUCTURES SHALL BE ASSUMED UNSTABLE UNTIL
- SECTIONS AND DETAILS ON THESE DRAWINGS ARE TO BE CONSIDERED TYPICAL FOR SIMILAR CONSTRUCTION NOT FULLY DETAILED.
- 7. CONTRACTOR SHALL BE RESPONSIBLE TO PROTECT THE EXISTING FACILITY AND ACCESSORIES. ANY DAMAGE CAUSED BY THE CONTRACTOR SHALL BE REPAIRED OR REPLACED TO THE SATISFACTION OF THE OWNER.

REINFORCING BAR TENSION SPLICE/LAP LENGTH

	CLASS B CONCRET	CMU LAP				
BAR SIZE	TOP BARS	OTHER BARS	-			
#3	24"	18"	-			
#4	32"	25"	18"			
#5	40"	31"	22"			
#6	48"	37"	36"			
#7	56"	43"	N/A			
#8	64"	50"	N/A			

1. TOP BARS ARE HORIZONTAL BARS WITH MORE THAN 12" OF FRESH

CONCRETE PLACED BELOW THEM.

MALONE 64 South St.

320 W. Main St., Suite 2 Auburn, NY 13021 Malone, NY 12953 518.483.1585

Albany, NY 12207

518.940.4558

315.253.7301 SYRACUSE ALBANY 115 Solar St 150 State St., 4th Floor

AUBURN

Syracuse, NY 13204

315.472.6980



Any alterations to this document not

Education Law are strictly prohibited.

S

Z

Δ

conforming to section 7307. New York State

DESIGN DEVELOPMENT PROJECT NO: 25033 08/04/2025

Drawn By:

Designed By:

Reviewed Bv:

no. description by

GENERAL NOTES,

SYMBOLS, AND **ABBREVIATIONS**

EFO

EXISTING WORK


- 1. PROTECT FROM DAMAGE ALL EXISTING FEATURES NOT INDICATED OR REQUIRED TO BE REMOVED FOR THE WORK.
- 2. REPAIR ITEMS THAT ARE TO REMAIN IF DAMAGED DURING THE PERFORMANCE OF THE WORK. REPAIR OR REPLACE TO THEIR ORIGINAL CONDITION AS DETERMINED BY THE OWNER'S REPRESENTATIVE, OR REPLACE WITH NEW IN-KIND.

LAYOUT


- 1. ESTABLISH A CONSTRUCTION STAGING AREA AND EQUIPMENT STORAGE ON SITE. COORDINATE LOCATIONS WITH THE OWNER'S REPRESENTATIVE. RESTORE ANY AREAS DISTURBED BY STAGING, PARKING, OR OTHER CONSTRUCTION ACTIVITIES TO THEIR ORIGINAL CONDITION.
- 2. ALL DIMENSIONS ARE TO FACE OF BUILDING, STRUCTURE, OR EDGE OF PAVEMENT, UNLESS NOTED
- 3. ALL WORK MUST CONFORM TO 2010 ADA AND ANSI A117.1-2009 FOR ACCESSIBILITY.

DEMOLITION


- 1. CONDUCT REMOVAL OPERATIONS TO PREVENT INJURY TO PEOPLE AND DAMAGE TO ADJACENT EXISTING FEATURES TO REMAIN. ENSURE SAFE PASSAGE OF PEOPLE AND AUTHORIZED VEHICLES AROUND THE WORK AREA.
- 2. PROVIDE CONSTRUCTION FENCES, BARRICADES OR OTHER SUITABLE DEVICES AS DIRECTED BY THE OWNER'S REPRESENTATIVE TO PREVENT DAMAGE BY VEHICLES AND UNAUTHORIZED ENTRY INTO WORK, CONSTRUCTION STAGING AND EQUIPMENT STORAGE AREAS.
- PROVIDE ALL REMOVALS INCIDENTAL TO AND NECESSARY TO PROVIDE THE WORK OF THIS CONTRACT AND LEGALLY DISPOSE OF OFF-SITE. REMOVE EXISTING FEATURES AND UNUSED EARTH MATERIALS INCLUDING EXCESS TOPSOIL IN THEIR ENTIRETY UNLESS OTHERWISE INDICATED BY THE OWNER'S REPRESENTATIVE.
- 4. PROMPTLY DISPOSE OF DEMOLISHED MATERIALS AND TRASH, DO NOT ALLOW DEBRIS TO ACCUMULATE ON-SITE.
- 5. UTILIZE SAW-CUTS IN AREAS WHERE PAVEMENT IS TO BE REMOVED FOR INSTALLATION OF IMPROVEMENTS AND WHERE NEW PAVEMENT IS JOINED WITH EXISTING.
- 6. REMOVE EXISTING TREES AND VEGETATION AS REQUIRED TO INSTALL IMPROVEMENTS. TREE AND OTHER VEGETATION REMOVALS ARE EXPLICITLY IDENTIFIED. THE EXTENT OF ALL VEGETATION REMOVALS SHALL BE APPROVED BY THE OWNER'S REPRESENTATIVE PRIOR TO CONSTRUCTION.
- 7. REMOVE ALL SECTIONS OF EXISTING ABANDONED UNDERGROUND UTILITIES WHERE THEY INTERFERE WITH NEW WORK OR AS NOTED. PERMANENTLY SEAL REMAINING SECTIONS WITH MORTAR OR END CAPS.
- 8. CONTRACTOR TO COORDINATE AND NOTIFY OWNER'S REPRESENTATIVE OF ANY DISCREPANCIES.

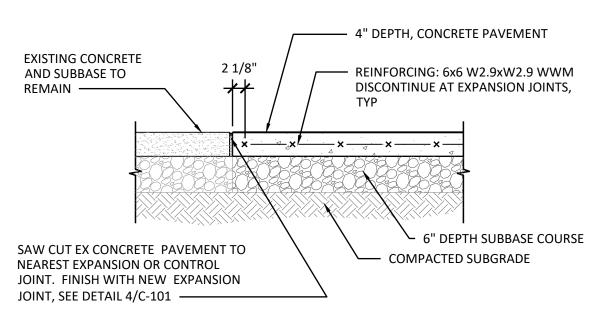

CONCRETE PAVEMENT JOINT TO EXISTING

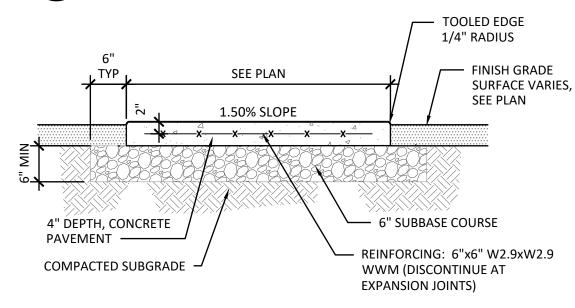

CONCRETE SIDEWALK SCALE: NONE

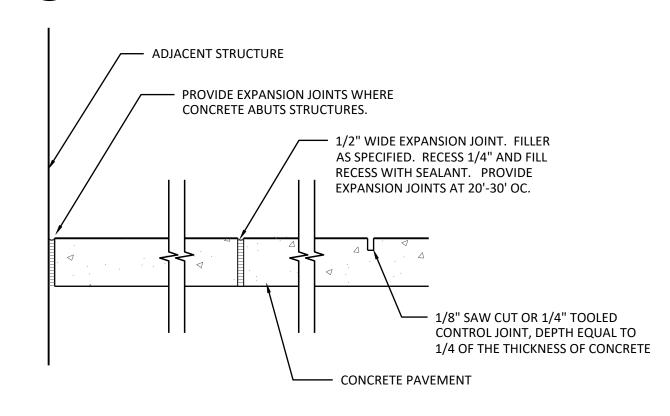

CONCRETE PAVEMENT JOINTS

SITE GRADING AND DRAINAGE NOTES


- 1. RESTRICT GRADING OPERATIONS TO AREAS SHOWN ON THE DRAWINGS. GRADING OUTSIDE THE CONTRACT LIMIT LINE, UNLESS AUTHORIZED BY THE OWNER'S REPRESENTATIVE, WILL NOT BE PERMITTED.
- 2. PERFORM ALL EXCAVATION OPERATIONS WITH EXTREME CAUTION. DETERMINE LOCATION AND ELEVATION OF EXISTING UTILITIES PRIOR TO COMMENCING GRADING.
- 3. BLEND ALL LINES AND GRADES OF NEW WORK SMOOTHLY WITH EXISTING.
- 4. GRADE ALL SURFACES TO DRAIN AWAY FROM ALL NEW AND EXISTING STRUCTURES. ALL AREAS MUST DRAIN TO AN OUTLET, WHETHER EXISTING OR NATURAL. AREAS WHICH POND IN EXCESS OF 1/4 INCH IN PAVED AREAS AND 1/2 INCH IN LAWN AREAS WILL NOT BE ACCEPTED.
- 5. MAINTAIN EXISTING STORM DRAIN FACILITIES NOT INTERRUPTED BY CONSTRUCTION RELATED ACTIVITIES.

UTILITIES

- 1. THE LOCATION OF EXISTING UTILITIES INDICATED ON THE SITE SURVEY AND DRAWINGS ARE APPROXIMATE ONLY. ACCURATELY LOCATE EXISTING SUBSURFACE UTILITIES BEFORE EXCAVATING.
- 2. PRIOR TO COMMENCING ANY CONSTRUCTION ACTIVITIES, CONTACT DIG SAFELY NEW YORK (1-800-962-7962) FOR INFORMATION ON EXISTING UNDERGROUND UTILITIES.
- 3. CONTACT COMMERCIAL UTILITY COMPANIES TO OBTAIN INFORMATION ABOUT EXISTING
- 4. PERFORM EXCAVATION IN ACCORDANCE WITH ALL APPLICABLE LOCAL, STATE AND FEDERAL REQUIREMENTS.
- 5. SLOPE OR SUPPORT THE SIDES OF ALL EXCAVATIONS AS REQUIRED BY SAFETY REGULATIONS.

RESTORATION OF SURFACES


- 1. FINE GRADE AND SEED ALL AREAS DISTURBED BY THIS CONSTRUCTION, WHICH ARE NOT OTHERWISE NOTED.
- 2. ALL LAWN AREAS SHALL BE SEEDED WITH GENERAL LAWN SEED MIX EXCEPT WHERE OTHERWISE INDICATED, SEE SPECIFICATION SECTION 329200.
- 3. RESTRICT GROUND DISTURBANCES TO THE MINIMUM EXTENT PRACTICAL. ALL DISTURBED AREAS SHALL BE RESTORED TO EXISTING FINISH GRADE UNLESS INDICATED OTHERWISE.

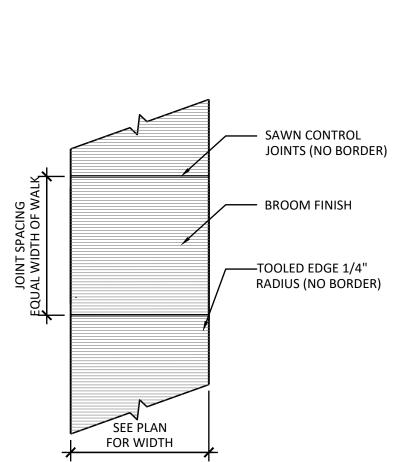

NOTES:

- 1. PROVIDE BROOM FINISH IN ONE DIRECTION PERPENDICULAR TO DIRECTION OF TRAFFIC.
- 2. WINDOW PANE BORDERS AT EDGE OF PAVEMENT AND AT JOINTS IS NOT PERMITTED.


CONCRETE PAVEMENT FINISH

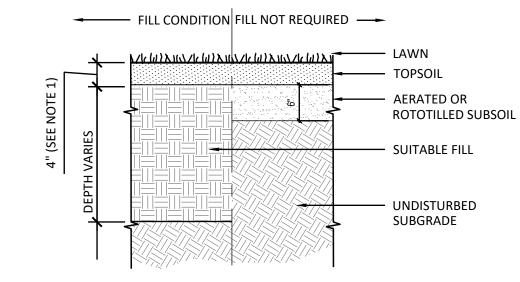

1. PROVIDE 4" MINIMUM TOPSOIL (AFTER SETTLEMENT) ON ALL AREAS DISTURBED BY CLEARING, GRADING AND OTHER CONSTRUCTION RELATED ACTIVITIES. SEED, FERTILIZE AND MULCH ALL RESTORED AREAS.

LAWN RESTORATION



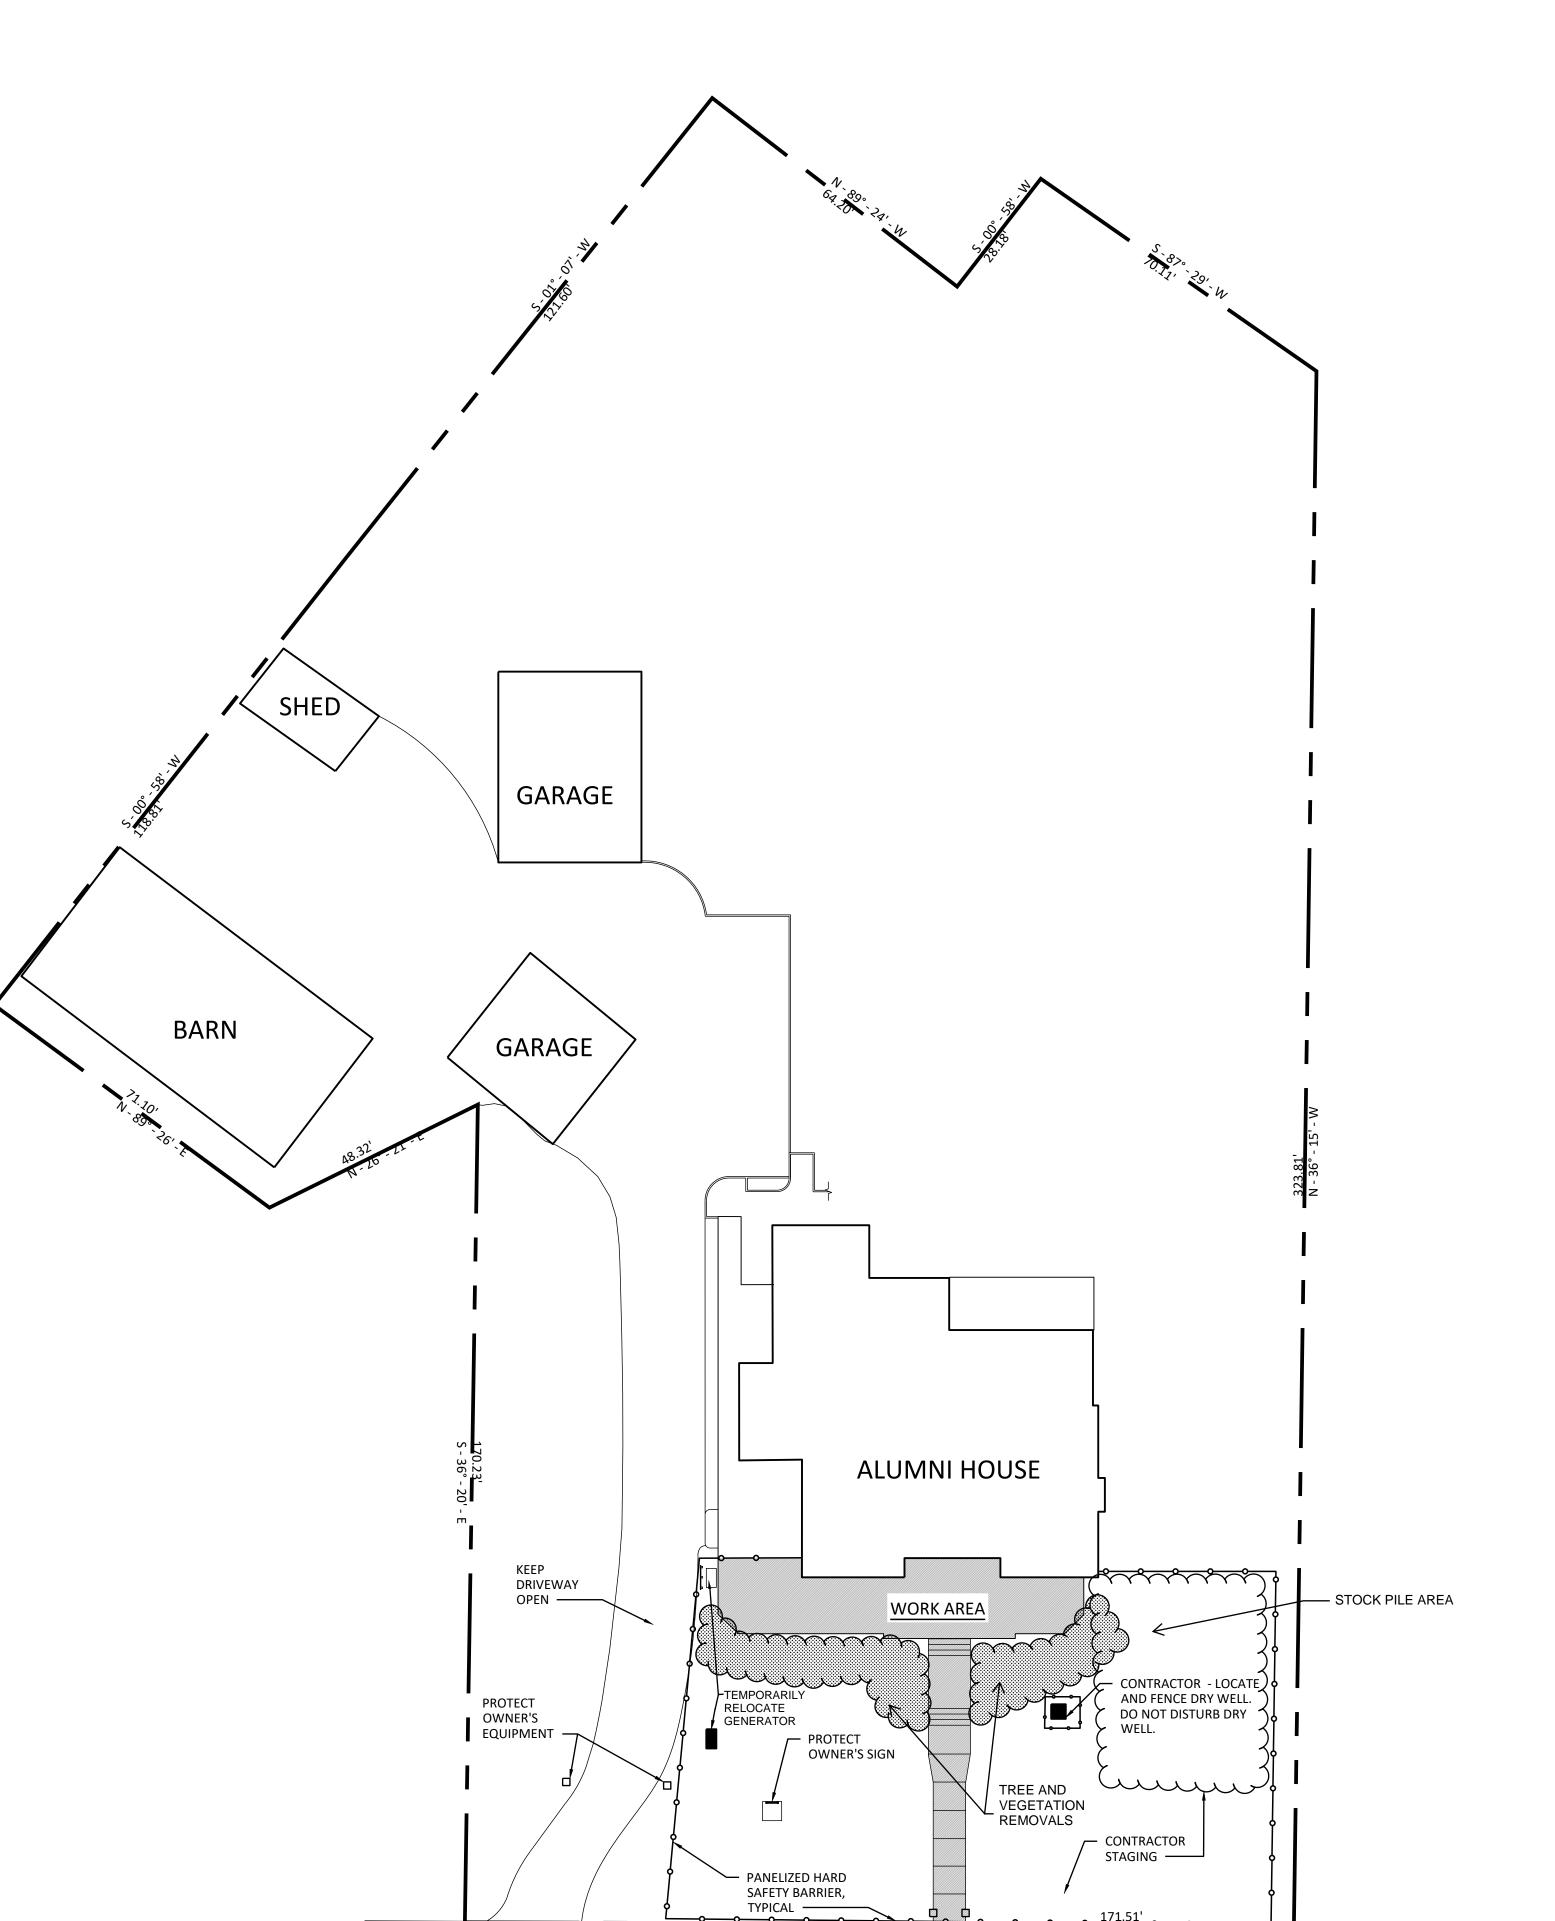

TOMPKINS STREET

SITE LAYOUT

SCALE: 1" = 20'

64 South St. 320 W. Main St., Suite 2 Auburn, NY 13021 Malone, NY 12953 518.483.1585 315.253.7301 SYRACUSE ALBANY

115 Solar St 150 State St., 4th Floor Albany, NY 12207 Syracuse, NY 13204 315.472.6980 518.940.4558



Any alterations to this document not conforming to section 7307. New York State Education Law are strictly prohibited.

Д

DESIGN DEVELOPMENT

25033 08/04/2025 PROJECT NO: Drawn By: EFO Designed By: Reviewed By:


description

OVERALL SITE PLAN AND DETAILS

OVERHEAD UTILITY -

2-HR STREET PARKING AS AVAILABLE

C-101

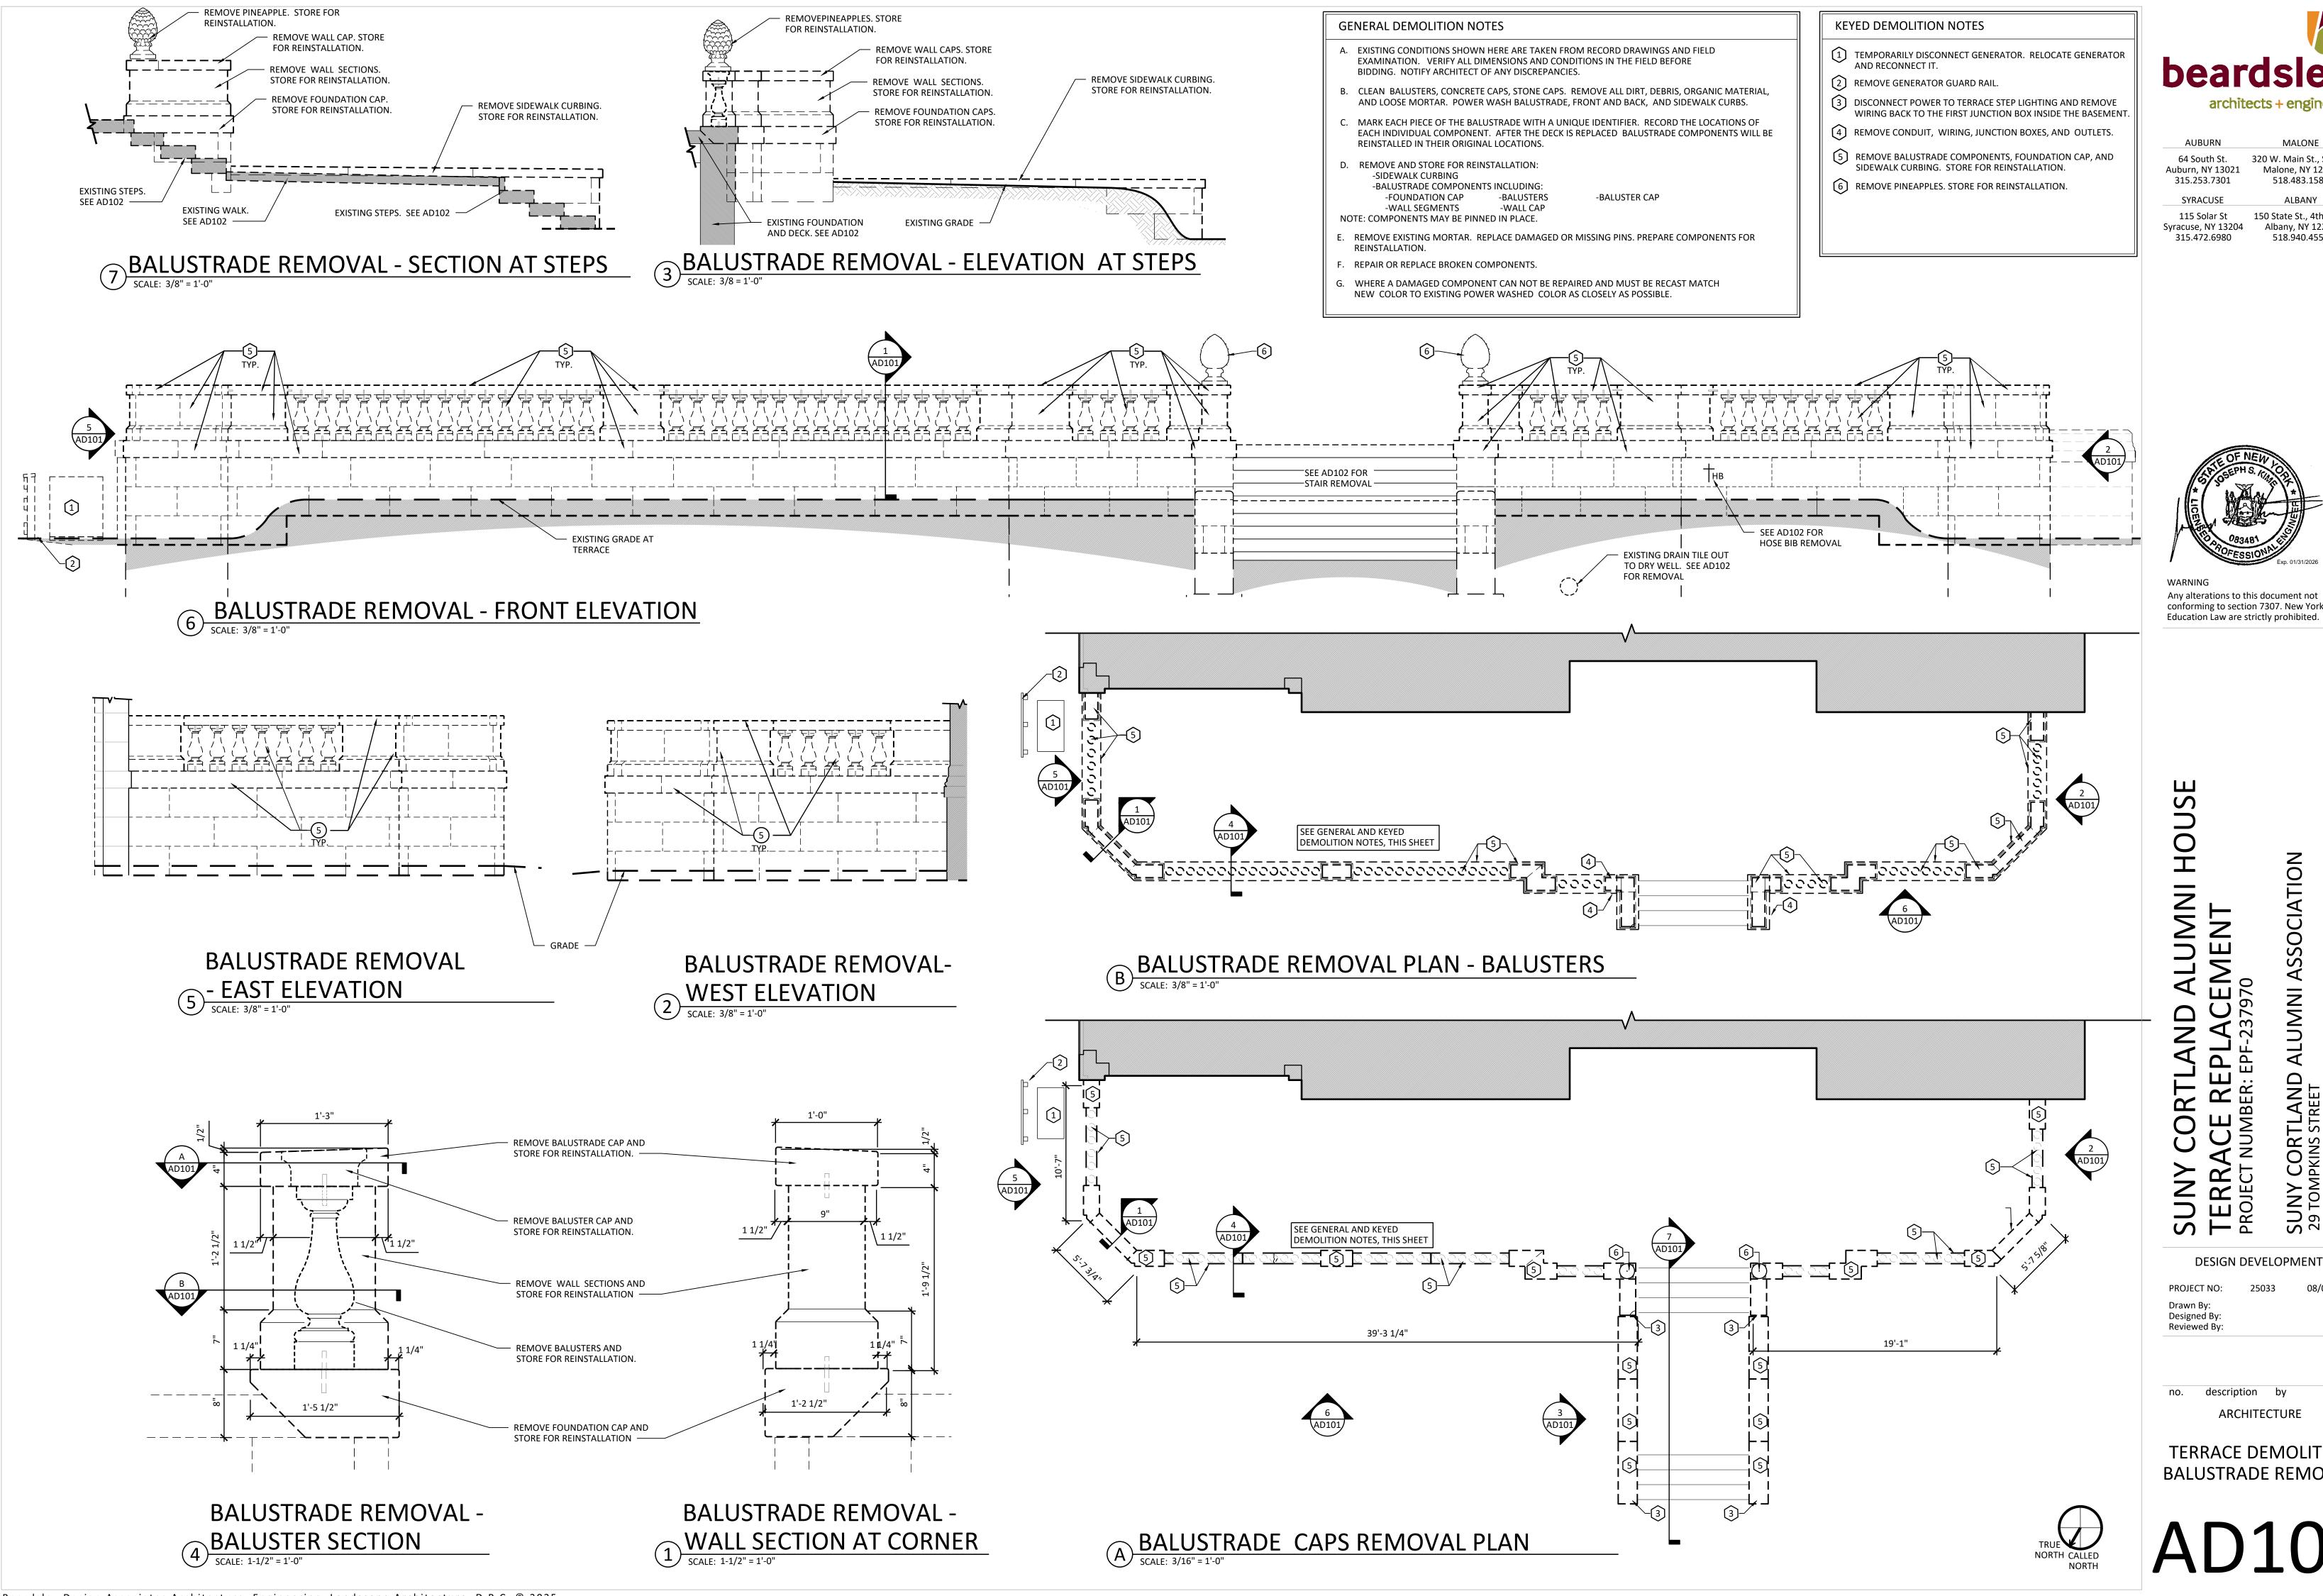

MALONE 64 South St.

320 W. Main St., Suite 2 Malone, NY 12953 518.483.1585 ALBANY


150 State St., 4th Floor Albany, NY 12207 518.940.4558

Any alterations to this document not conforming to section 7307. New York State

description

TAC EFO JSK

TERRACE DEMOLITION **BALUSTRADE REMOVAL**

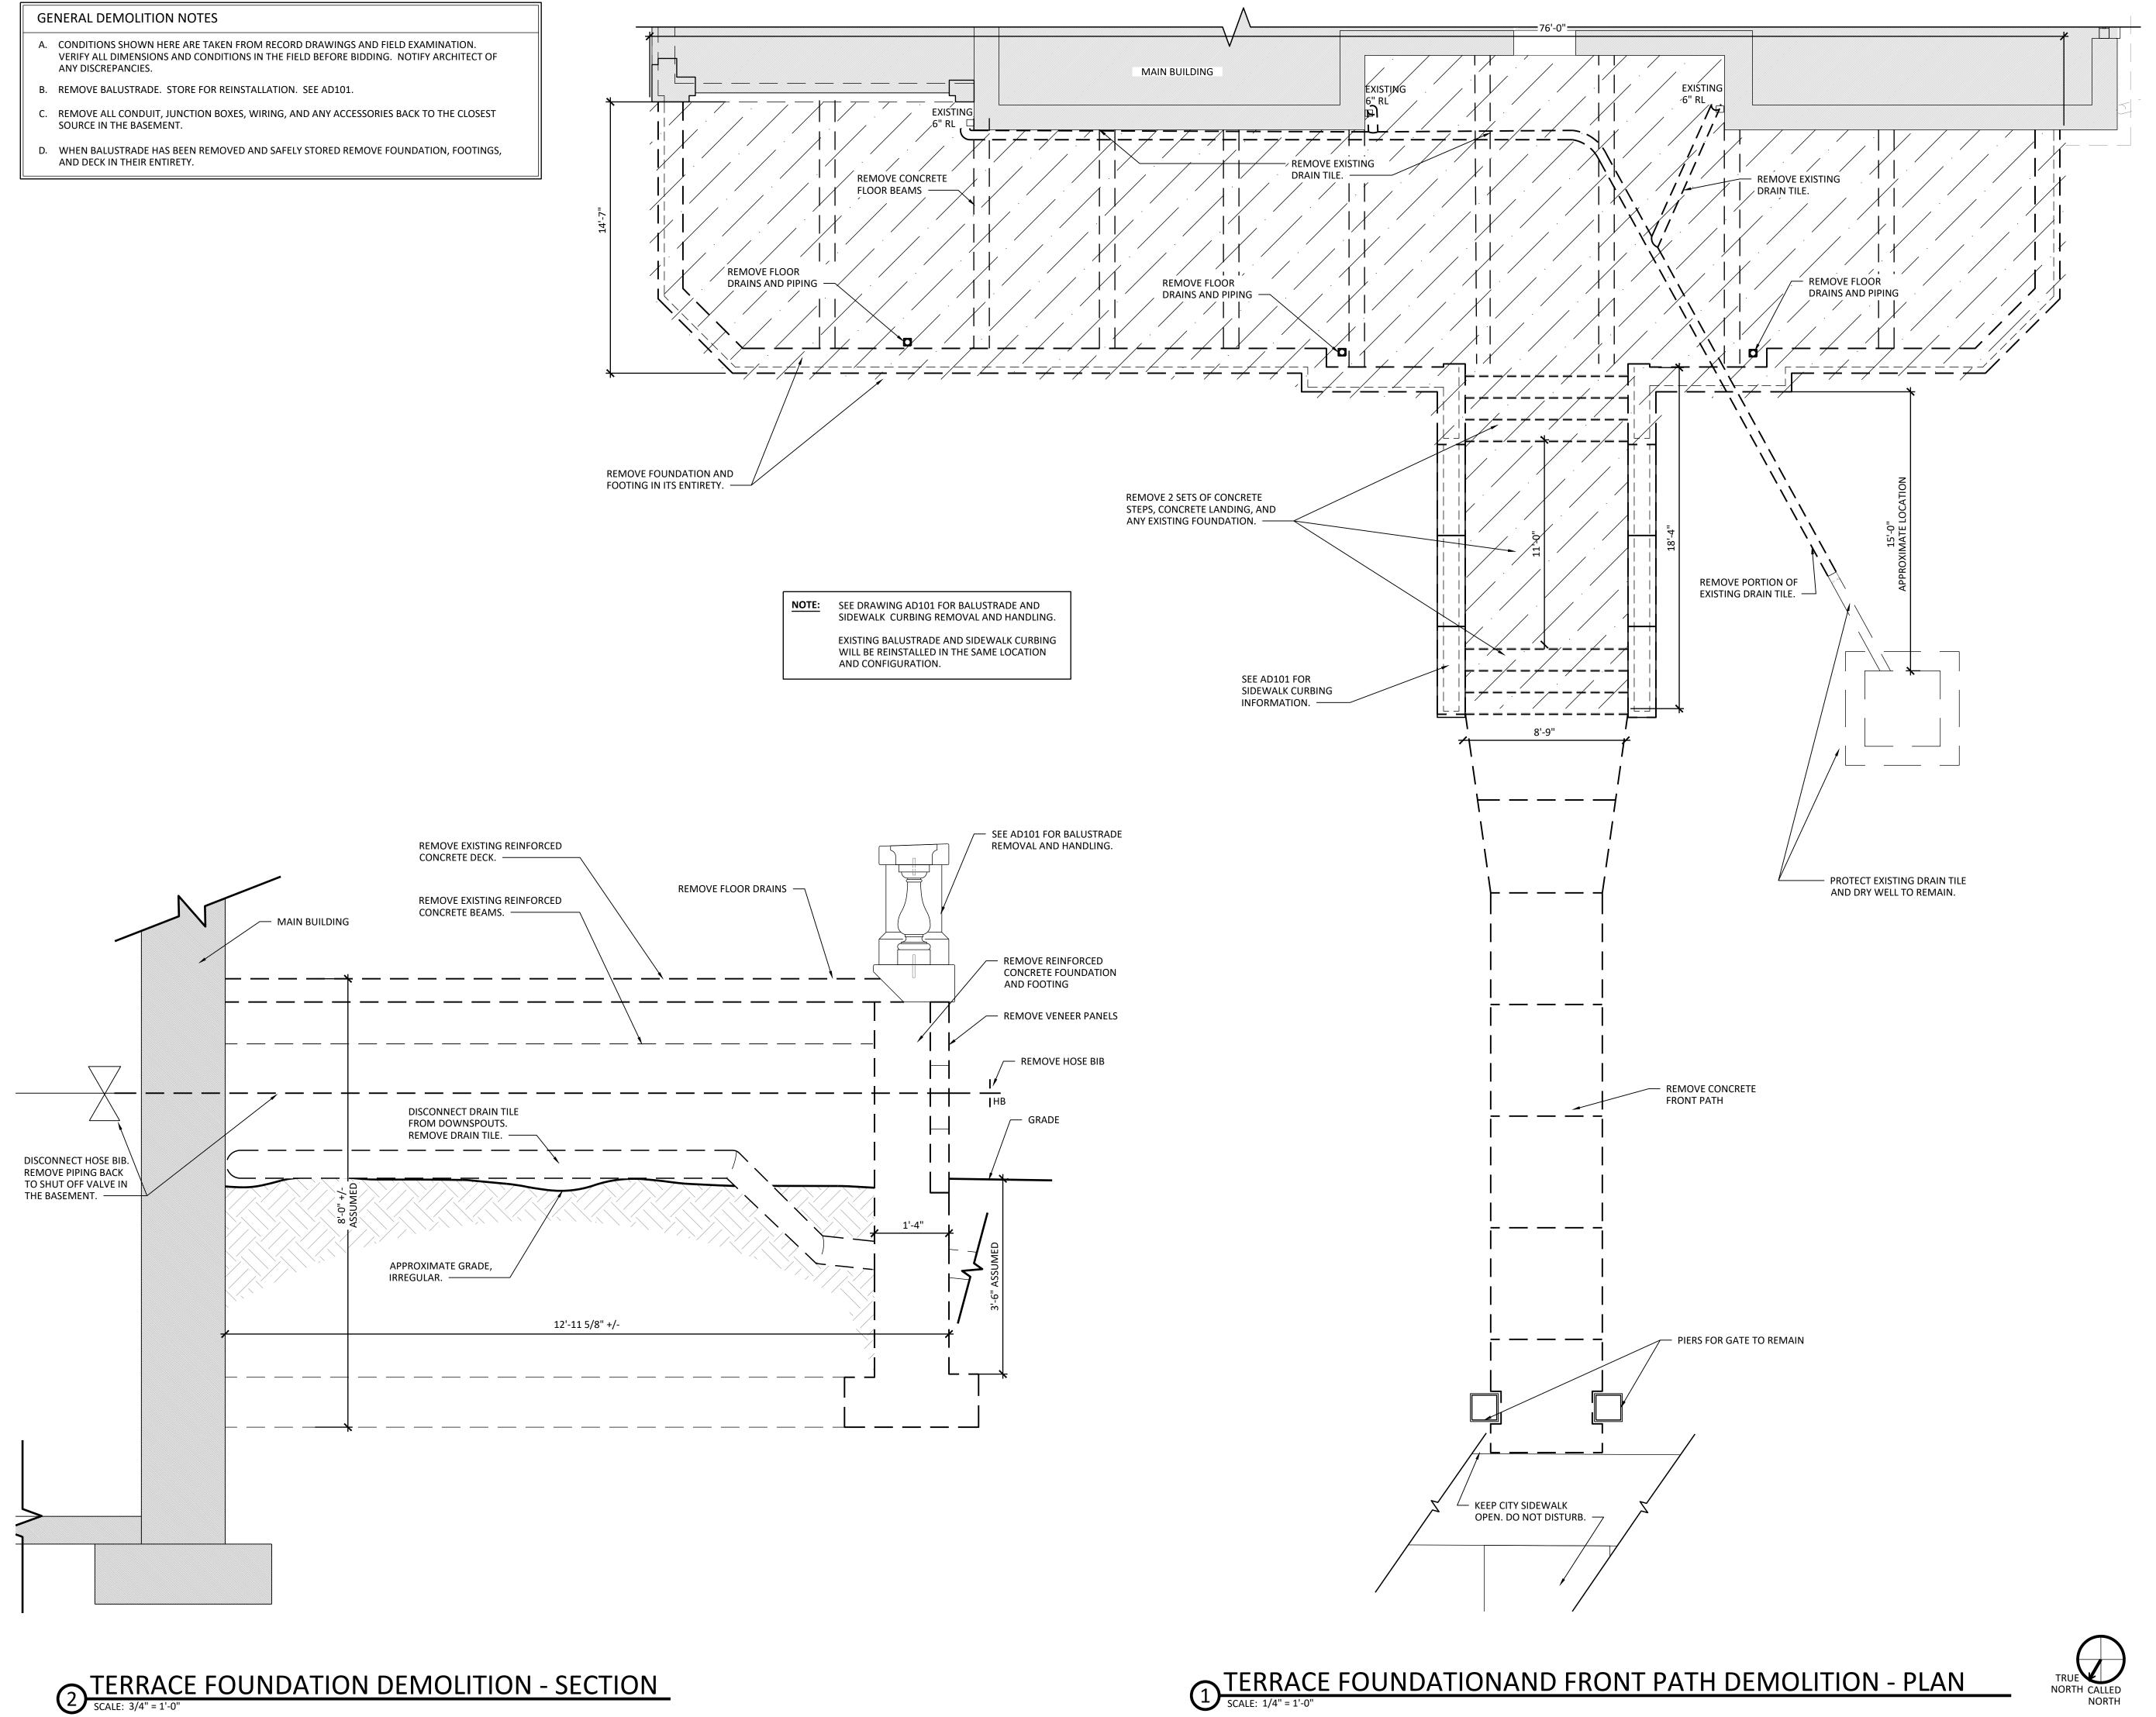



AUBURN MALONE 320 W. Main St., Suite 2 64 South St. Auburn, NY 13021 Malone, NY 12953 315.253.7301 518.483.1585 SYRACUSE

ALBANY 115 Solar St 150 State St., 4th Floor Albany, NY 12207 Syracuse, NY 13204 315.472.6980 518.940.4558

WARNING Any alterations to this document not conforming to section 7307. New York State Education Law are strictly prohibited.


S

DESIGN DEVELOPMENT

TAC EFO JSK Designed By: Reviewed By:

no. description ARCHITECTURE

> TERRACE **FOUNDATION** DEMOLITION

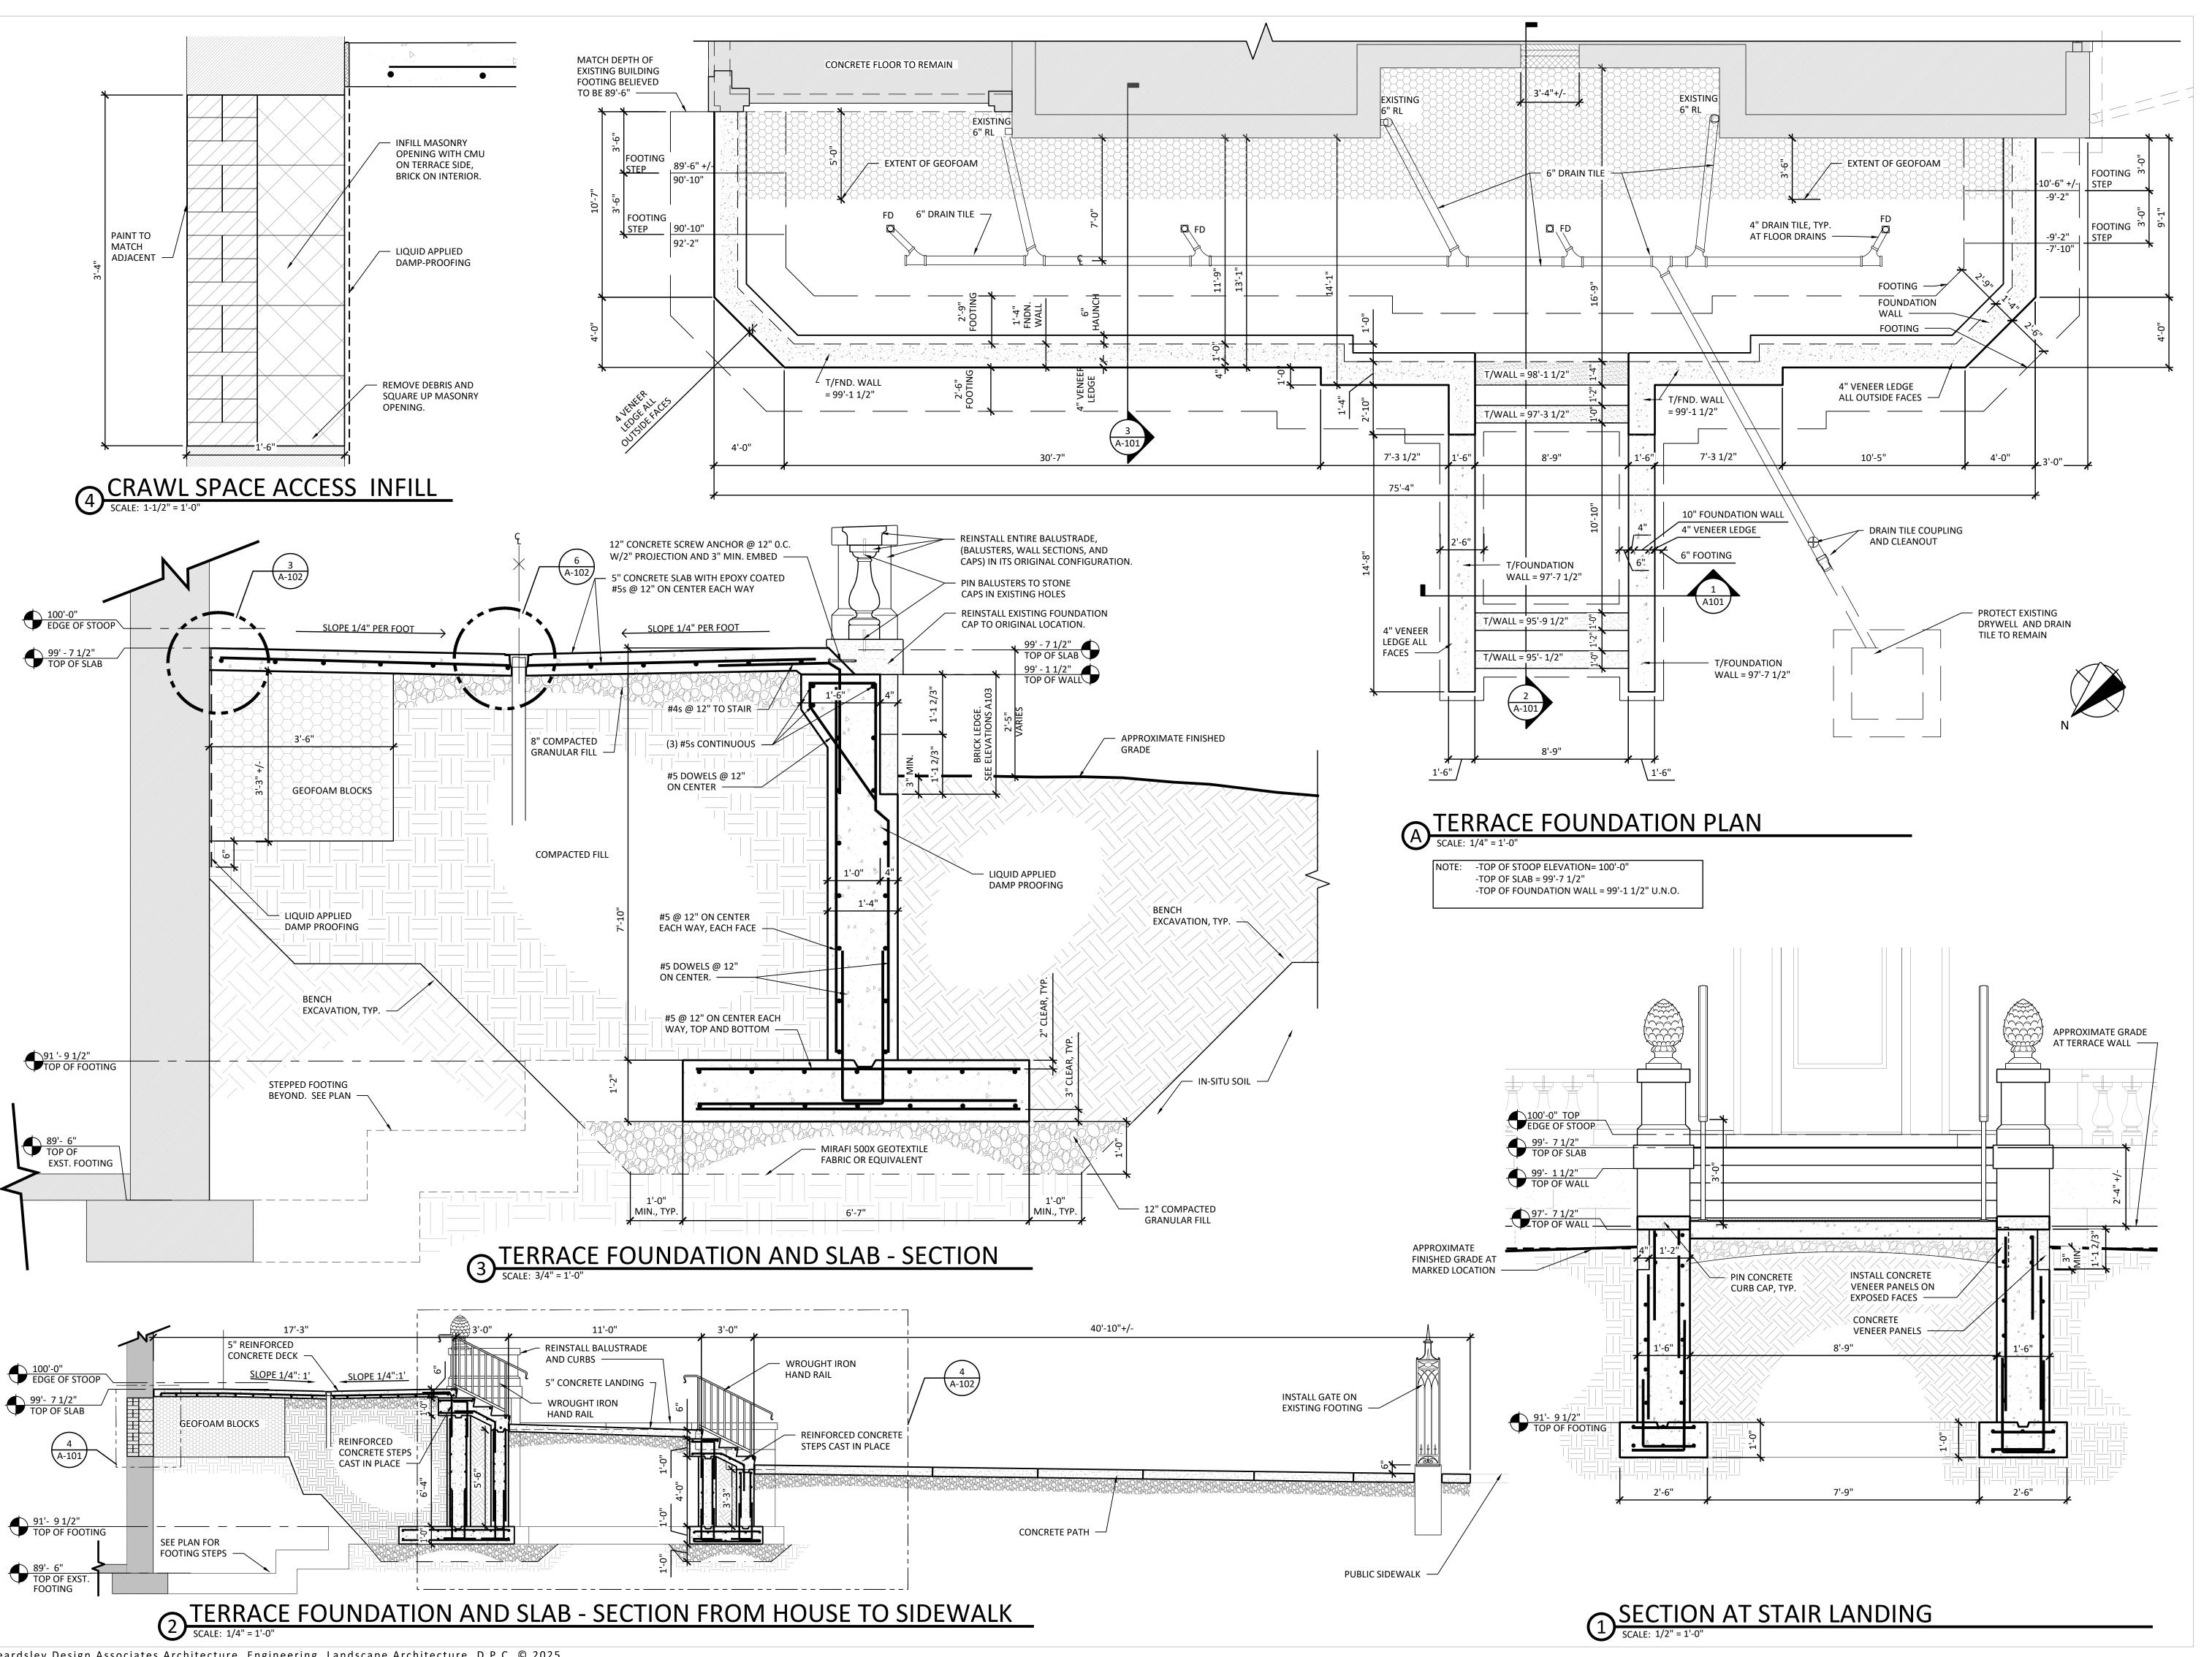



AUBURN MALONE 64 South St. 320 W. Main St., Suite 2 Auburn, NY 13021 Malone, NY 12953 315.253.7301 518.483.1585 SYRACUSE ALBANY 115 Solar St 150 State St., 4th Floor

Syracuse, NY 13204

315.472.6980

Albany, NY 12207

518.940.4558



WARNING Any alterations to this document not conforming to section 7307. New York State Education Law are strictly prohibited.

USE

EMENT


DESIGN DEVELOPMENT PROJECT NO: 25033 08/04/2025 TAC EFO JSK Drawn By: Designed By:

Reviewed By:

description

ARCHITECTURE

TERRACE FOUNDATION PLAN

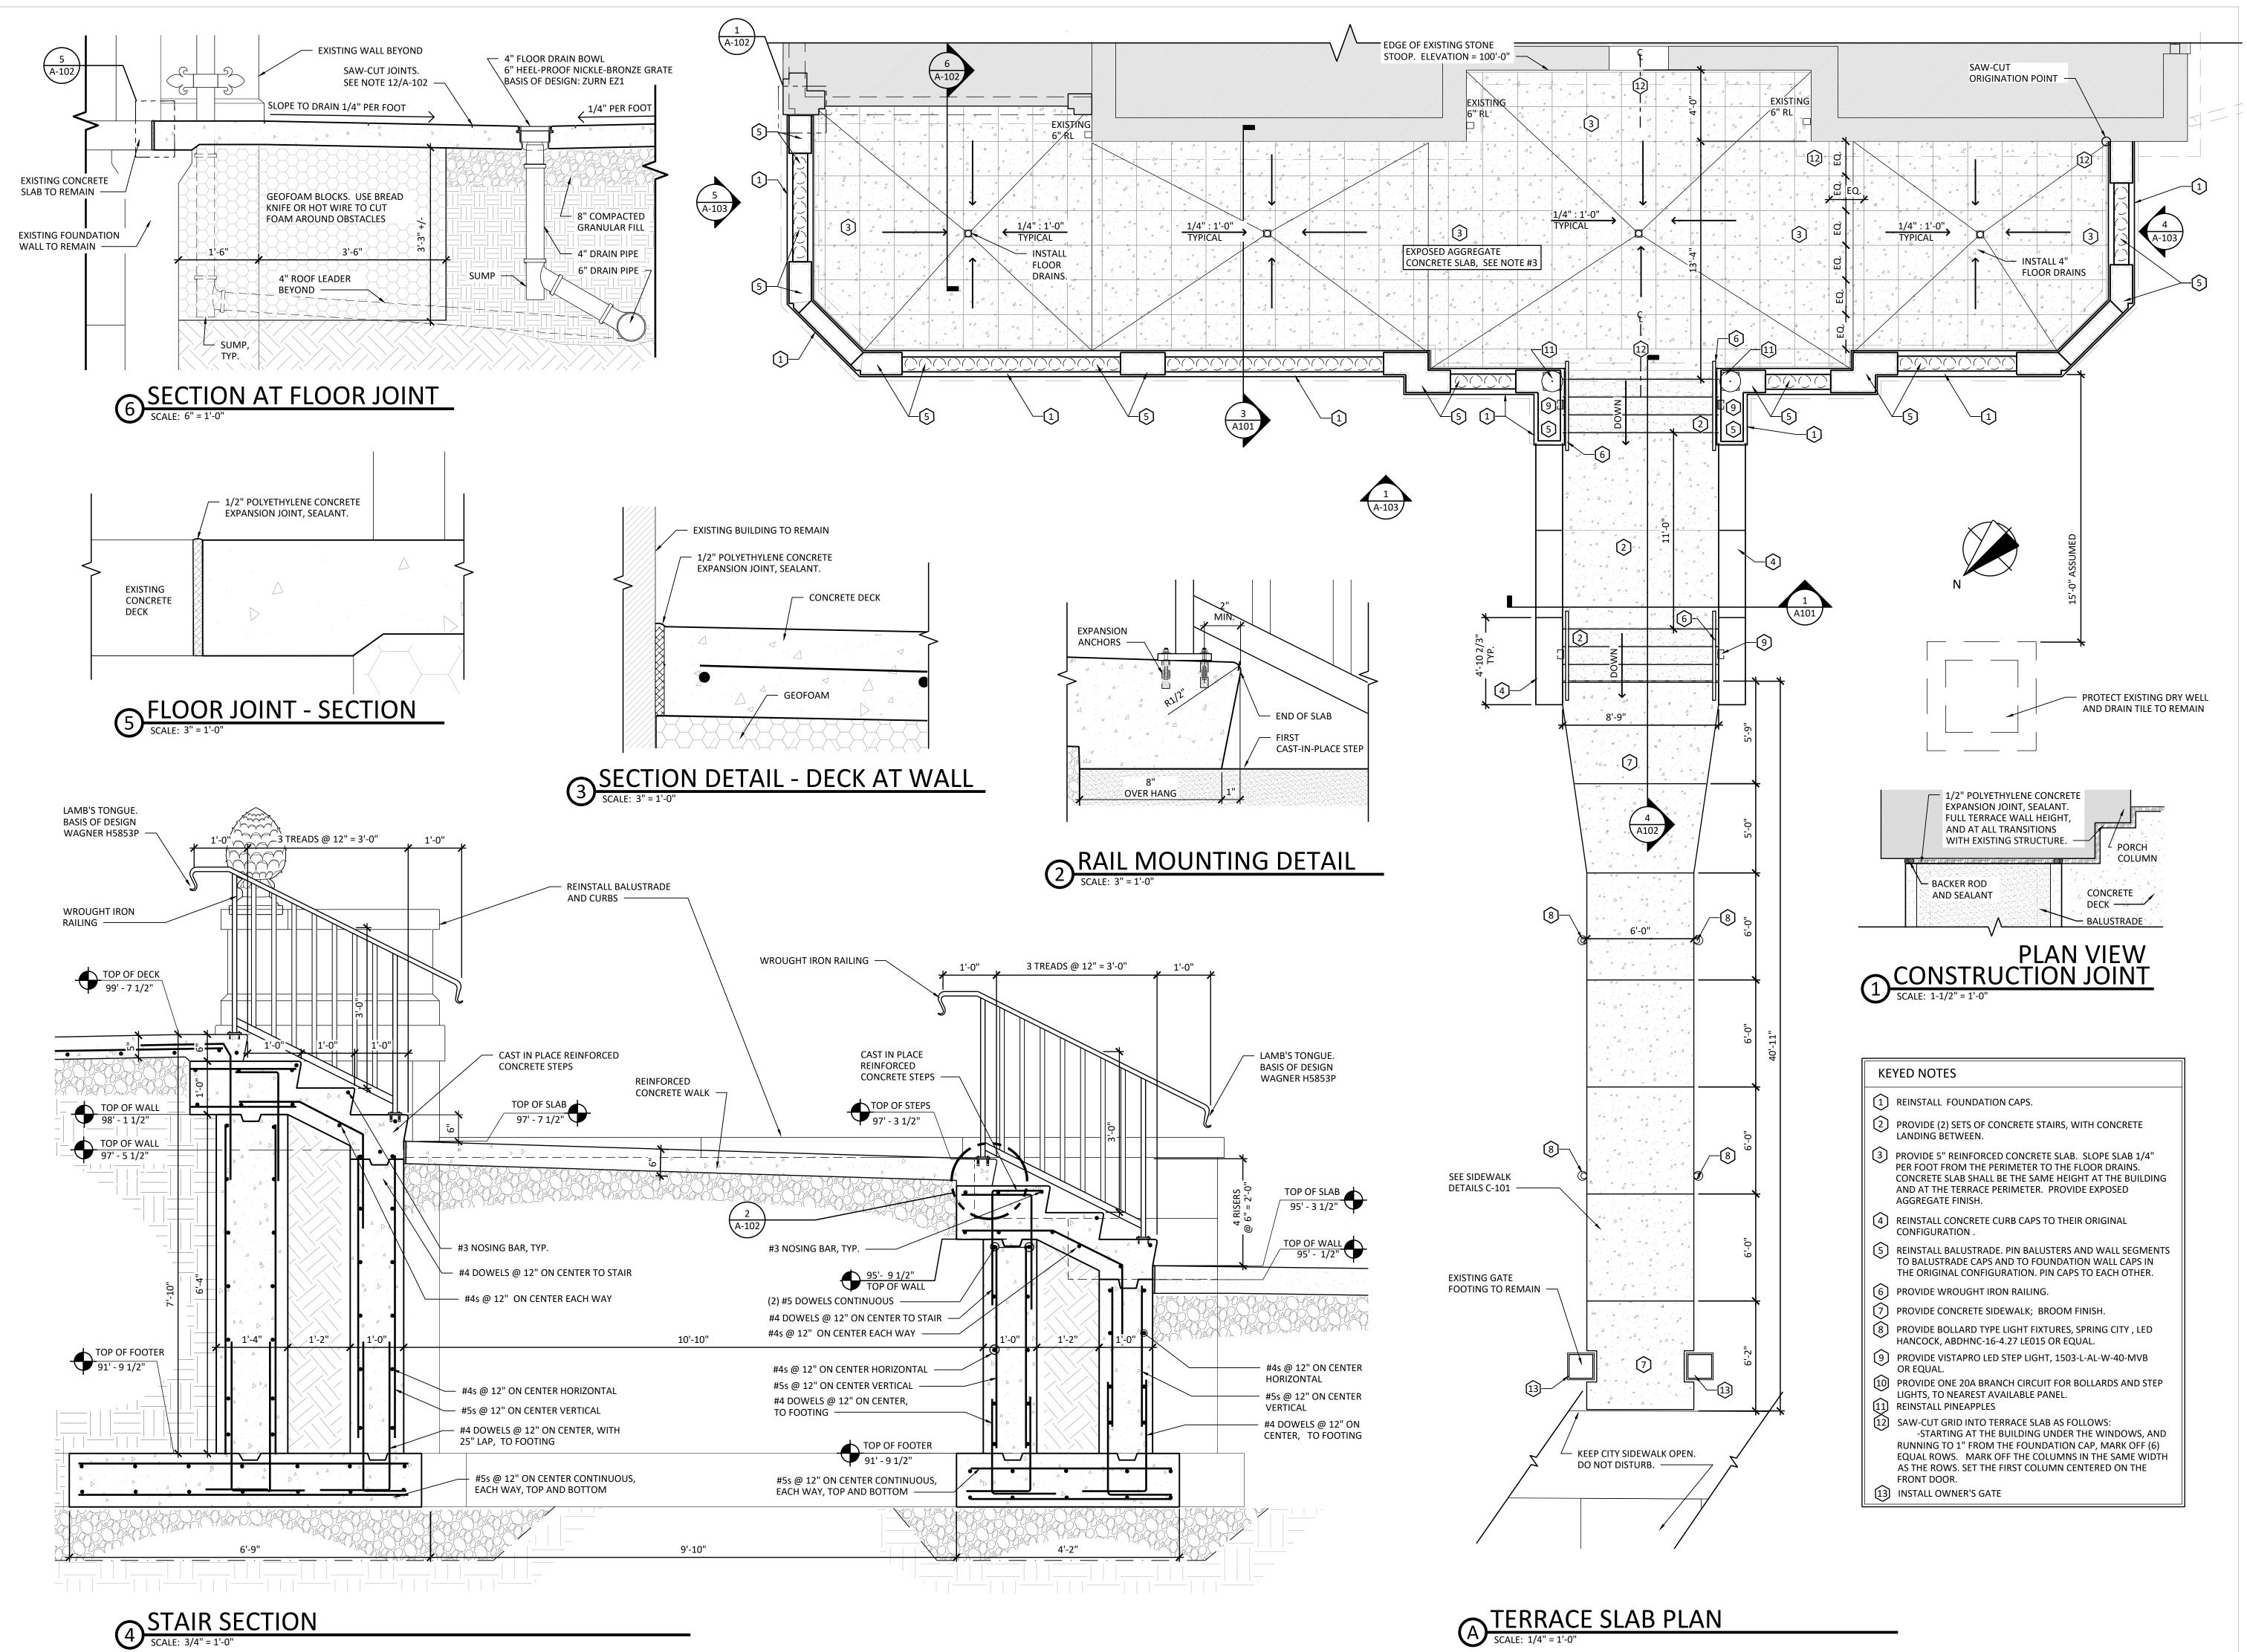

beardsley

AUBURN MALONE

64 South St.
Auburn, NY 13021
315.253.7301 SYRACUSE ALBANY

MALONE

320 W. Main St., Suite 2
Malone, NY 12953
518.483.1585

115 Solar St

Syracuse, NY 13204

315.472.6980

150 State St., 4th Floor

Albany, NY 12207

518.940.4558



WARNING
Any alterations to this document not conforming to section 7307. New York State Education Law are strictly prohibited.

DRTLAND ALUMNI HOUSE E REPLACEMENT

MBER: EPF-237970

DESIGN DEVELOPMENT


PROJECT NO: 25033 08/04/2025

Drawn By: TAC
Designed By: EFO
Reviewed By: JSK

no. description by date of the description description

TERRACE PLAN

A-102

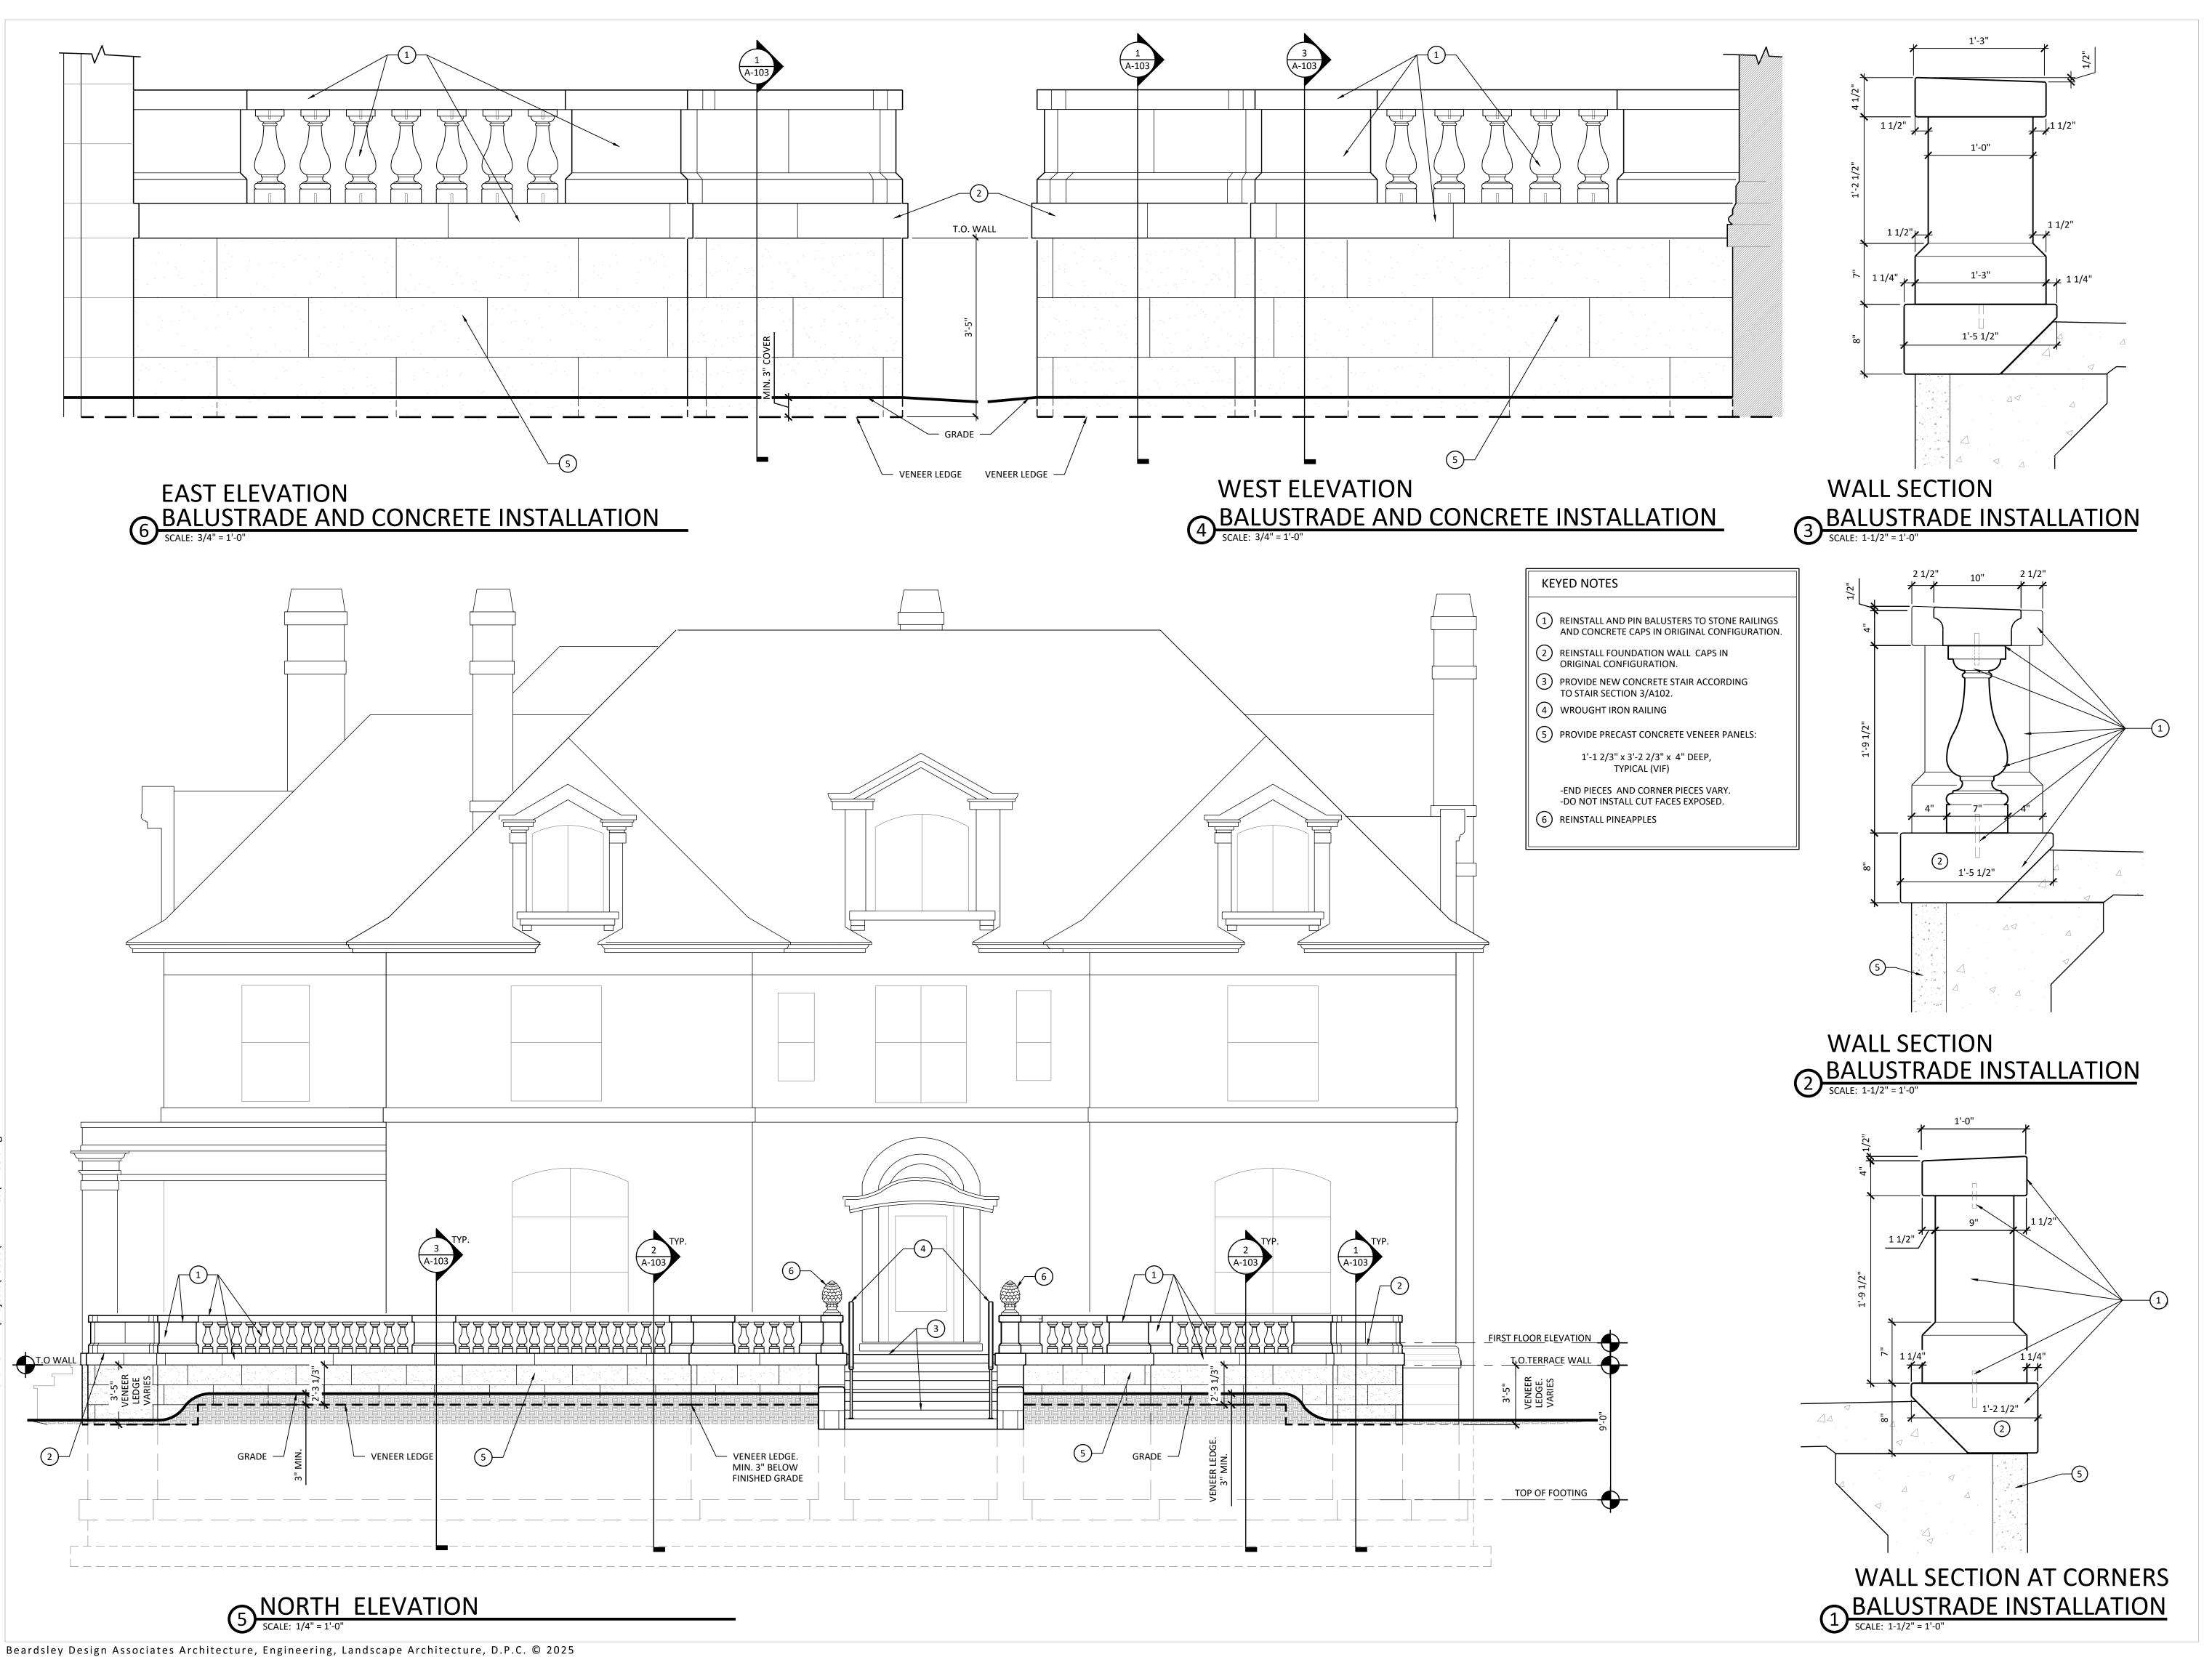



AUBURN MALONE

64 South St.
Auburn, NY 13021
315.253.7301 S18.483.1585

SYRACUSE ALBANY

115 Solar St 150 State St., 4th Floor

Syracuse, NY 13204 315.472.6980 Albany, NY 12207

518.940.4558



WARNING
Any alterations to this document not conforming to section 7307. New York State Education Law are strictly prohibited.

UMNI HOUSE

ERRACE REPLACEMENT

SJECT NUMBER: EPF-237970

DESIGN DEVELOPMENT

PROJECT NO: 25033 08/04/2025


Drawn By: TAC
Designed By: EFO
Reviewed By: JSK

no. description by d


BALUSTRADE

INSTALLATION


A-103

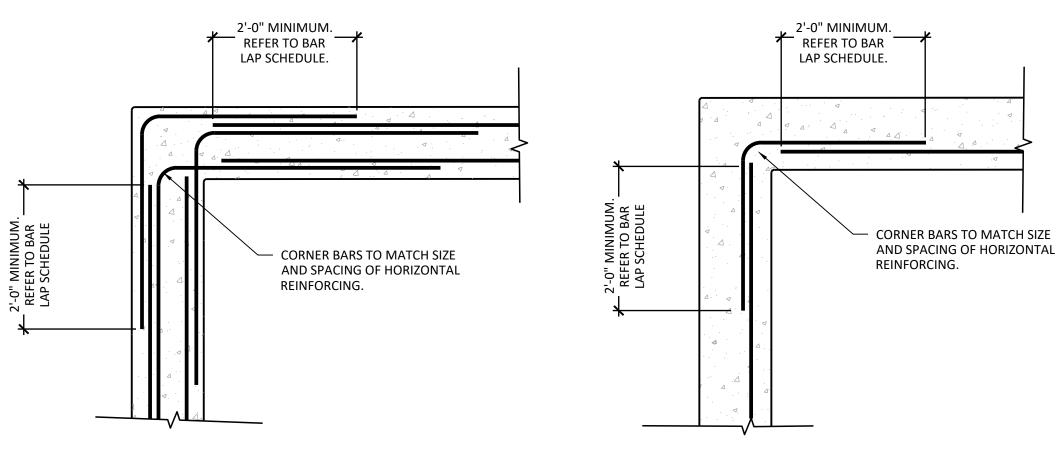


WALL CORNER REINFORCEMENT SCALE: 3/4" = 1'-0"

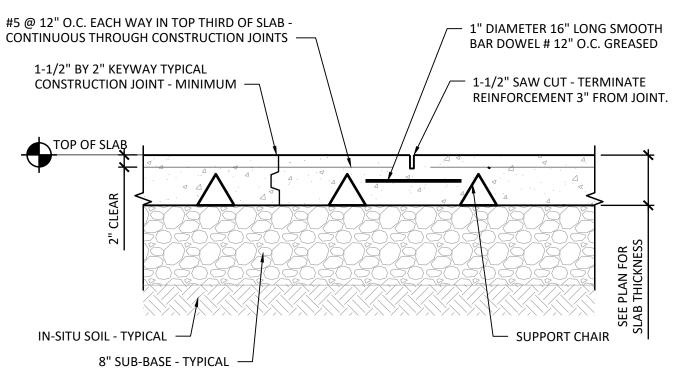



TYPICAL SLAB ON GRADE DETAIL SCALE: 3/4" = 1'-0"

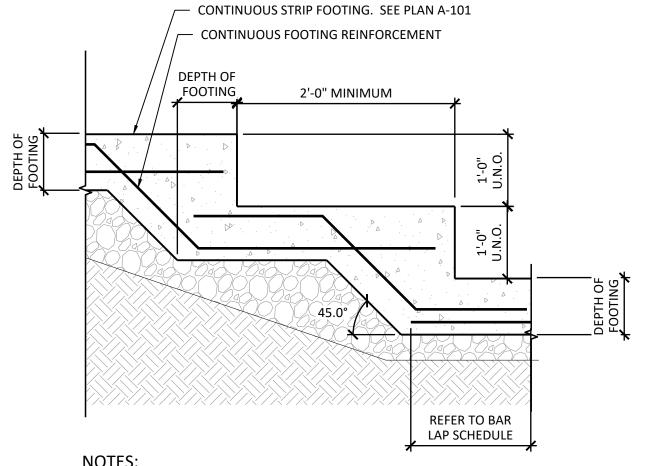

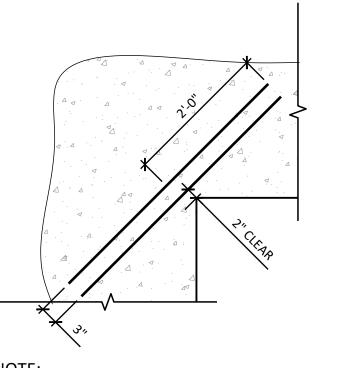

COORDINATE WITH SAW-CUT LINE AND SLAB PLAN
 PLACE AT THRESHOLDS OF TYPICAL FROST PROTECTED OPEININGS.

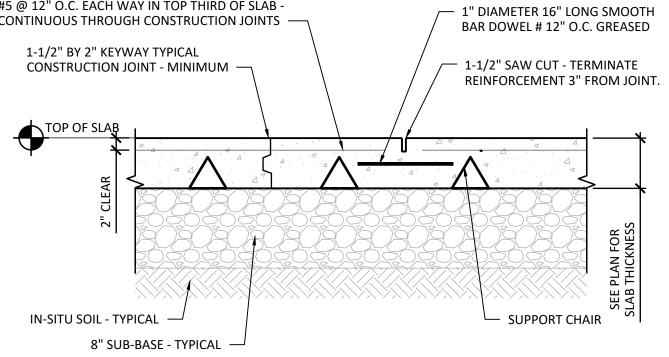

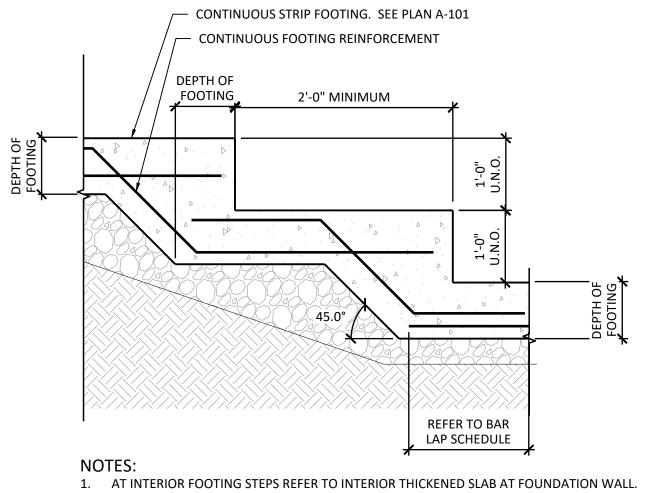

TYPICAL REINFORCING AT FOOTING STEP SCALE: 3/4" = 1'-0"

3. PLACE AT SLAB DEPRESSIONS.

REBAR AT RE-ENTRANT CORNER - TYICAL DETAIL

SCALE: 3/4" = 1'-0"



AUBURN

64 South St.

Auburn, NY 13021

315.253.7301

SYRACUSE

115 Solar St

Syracuse, NY 13204 315.472.6980

MALONE

320 W. Main St., Suite 2

Malone, NY 12953

518.483.1585

ALBANY

150 State St., 4th Floor

Albany, NY 12207

518.940.4558

WARNING Any alterations to this document not conforming to section 7307. New York State Education Law are strictly prohibited.

USE


DESIGN DEVELOPMENT

PROJECT NO: TAC EFO JSK Designed By: Reviewed By:


no. description by ARCHITECTURE

DETAILS

A-104

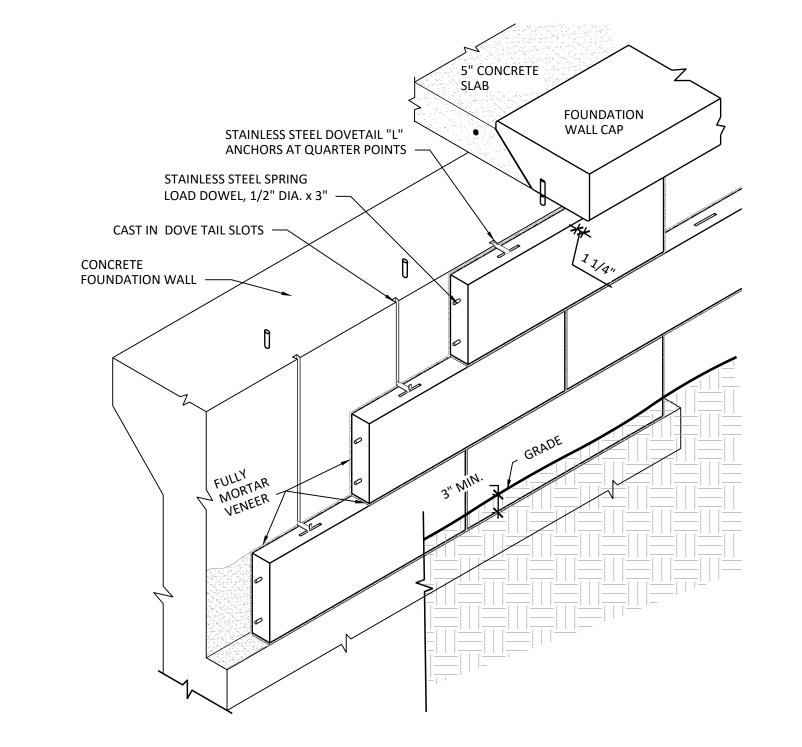

VENEER INSTALLATIONSCALE: 3/4" = 1'-0"

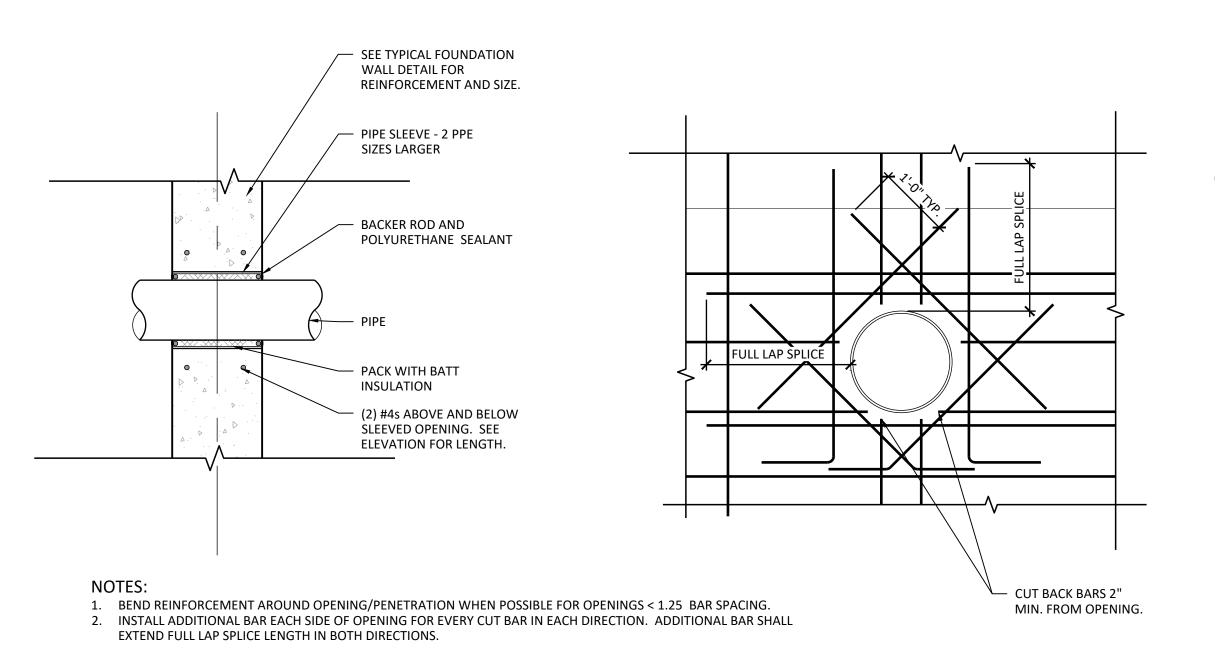

TYPICAL SLEEVE THROUGH FOUNDATION WALL SCALE: 3/4" = 1'-0"